

DEMOLITION GENERAL NOTES

- REFER TO SURVEY SHEETS FOR EXISTING CONDITIONS. FIELD VERIFY UNDERGROUND UTILITIES.
- REFER TO CIVIL FOR UTILITY DEMOLITION PLAN.
- PROTECT EXISTING TREES TO REMAIN.
- MAINTAIN EMERGENCY VEHICLE ACCESS AROUND BUILDING SITE.
- COORDINATE WITH OWNER FOR CONSTRUCTION FENCE LOCATION, VEHICLE ACCESS, CONTRACTOR PARKING, AND LAYDOWN AREA.
- REFER TO MEP DEMOLITION PLANS, NOTES, AND SPECIFICATIONS FOR INFORMATION ON OTHER EXISTING MECHANICAL, ELECTRICAL, AND PLUMBING EQUIPMENT.
- ALL WORK SHALL BE IN ACCORDANCE WITH ALL APPLICABLE CODES, REGULATIONS, AND ORDINANCES HAVING THE JURISDICTION.
- CONTRACTOR'S FORCES ARE NOT ALLOWED TO USE TOILET ROOMS, LAVATORIES SHALL NOT BE USED AS CONTRACTOR WORK CLEANING AREAS.
- CONTRACTOR SHALL CAP AND PLUG EXISTING WATERLINES WITHIN PROJECT LIMITS. SERVICES SHALL REMAIN OPERATIONAL AT ALL TIMES DURING SCHOOL HOURS. DISRUPTION IN SERVICES SHALL BE SCHEDULED AFTER 7PM, WITH DISTRICT APPROVAL.
- THE GC TO DISCONNECT, REMOVE ALL REPLACED HVAC EQUIPMENT, MARKER BOARD, WHITE BOARDS AND OTHER RELATED REMOVED ITEMS FOR FACILITIES TO HAUL OFF. ONCE REMOVED, THE GENERAL CONTRACTOR TO PROVIDE TWO WEEKS FOR THE FACILITIES TO HAUL OFF THESE ITEMS. IF FACILITIES DOES NOT HAUL OFF SALVAGED ITEMS IN 2 WEEKS, THE CONTRACTOR TO REMOVE ALL SALVAGED ITEMS AT NO COST TO THE OWNER.
- NO WORK INSIDE THE EXISTING SCHOOL ALLOWED DURING SCHOOL HOURS.
- ALL OUTDOOR WORK WILL BE ALLOWED DURING SCHOOL HOURS ONCE OK BY SCHOOL DISTRICT SAFETY AND SCHOOL MANAGEMENT.
- CONTRACTOR MUST TEST EXISTING ACCESS CONTROL, SECURITY, PUBLIC ADDRESS & FIRE ALARM SYSTEMS PRIOR TO START OF ANY WORK. IF ANY DEFICIENCY FOUND, BRING IT TO AECOM PM ATTENTION IN WRITING. IF CONTRACTOR CHOOSE TO START THE WORK WITHOUT TESTING THESE EXISTING SYSTEMS, THE CONTRACTOR WILL BE RESPONSIBLE FOR MAINTAINING THESE SYSTEMS AT NO COST TO THE OWNER.
- THE EXISTING SYSTEMS (PA, FA, ACCESS CONTROL, SECURITY & HVAC CONTROL) MUST STAY OPERATIONAL THROUGHOUT THE CONSTRUCTION PHASE UNTIL THE NEW SYSTEMS ARE ACTIVATED.
- IN CASE OF CEILING TILES / GRID TO BE REMOVED, MAKE SURE THAT ALL CEILING MOUNTED DEVICES LIKE PA SPEAKERS, WIFI DEVICES, PROJECTOR MOUNT ETC. TO BE REMOVED, SAFELY STORED AND RE-INSTALLED BY THE CONTRACTOR.
- IN CASE OF ANY EXISTING CIRCUIT / POWER TO BE REUSED, CONTRACTOR TO MUST VERIFY THE VOLTAGE / PHASE / BREAKER SIZE PRIOR TO ORDERING ANY NEW EQUIPMENT OR LIGHT FIXTURE TO MATCH THE EXISTING ONES.

DEMOLITION LEGEND

●

●

●

●

PROPERTY LIMIT LINE

DEMOLITION OF EXISTING, ALL ASSOCIATED FINISHES & EQUIPMENTS

■

■

■

■

NON RENOVATED AREA

■

■

■

■

■

■

■

■

⊙

⊙

⊙

⊙

⊙

⊙

⊙

⊙

KEYNOTE LEGEND

D.101	EXISTING CURB CUT AND SLIDING GATE TO BE UTILIZED. REMOVE EXISTING GRASS AND SIDEWALK AREA AS NEEDED TO ACCOMMODATE NEW ENTRY ASPHALT PAVING AND CONCRETE CURB RADIUS PER NEW SITE WORK.
D.102	EXISTING CONCRETE CURB AND SOD AREA TO BE REMOVED
D.104	LINE OF NEW BUILDING
D.105	EXISTING CONCRETE PAVING TO BE REMOVED
D.106	EXISTING CONCRETE CURB, SOD AND SIDEWALK TO BE REMOVED AS NEEDED TO PROVIDE NEW DRIVE ENTRY PER NEW SITE WORK.
D.107	EXISTING CONCRETE PAVING TO REMAIN
D.108	EXISTING 6TH ORNAMENTAL FENCE TO REMAIN
D.109	EXISTING TRACK SURFACE TO REMAIN
D.110	EXISTING TRACK SURFACE TO BE REMOVED
D.111	EXISTING ASPHALT PAVING TO REMAIN
D.112	SAW CUT AND REMOVE EXISTING CONCRETE LANDING, STEPS, FOUNDATION AND FOOTINGS
D.113	EXISTING PLAYGROUND AREA TO BE REMOVED. EXISTING GROUNDCOVER, BORDER WALLS, AND PLAYGROUND EQUIPMENT TO BE SALVAGED AND RELOCATED.
D.114	EXISTING PLAYGROUND AREA TO REMAIN
D.115	EXISTING MASONRY SCREEN WALL TO REMAIN
D.116	EXISTING MASONRY SCREEN WALL AREA TO BE REMOVED
D.117	EXISTING ORNAMENTAL FENCE AND GATE TO BE REMOVED
D.118	EXISTING LIGHT POLE, BASE AND FOOTING TO BE REMOVED
D.119	EXISTING GATE TO BE REMOVED
D.121	EXISTING CONCRETE RAMP/STAIR AND ASSOCIATED HANDRAILS TO BE REMOVED
D.122	EXISTING CONCRETE DRAINAGE CHANNEL TO REMAIN
D.123	EXISTING DAYCARE BUILDING AND GRAVEL LOT TO BE REMOVED IN PREPARATION FOR NEW PARKING LOT. SEE ALSO CIVIL.
D.124	EXISTING CONCRETE STAIR AND CONCRETE FOUNDATION TO REMAIN
D.141	EXISTING IRRIGATION SPRINKLER HEAD TO BE REMOVED
D.142	EXISTING TRANSFORMER AND CONCRETE PAD TO REMAIN
D.149	EXISTING FIRE HYDRANT AND UTILITIES TO BE RELOCATED. SEE ALSO CIVIL AND MEP

KEYPLAN

REFERENCE SITE PLAN - DEMOLITION
1" = 40'-0"

DEMOLITION GENERAL NOTES

- REFER TO SURVEY SHEETS FOR EXISTING CONDITIONS. FIELD VERIFY UNDERGROUND UTILITIES.
- REFER TO CIVIL FOR UTILITY DEMOLITION PLAN.
- PROTECT EXISTING TREES TO REMAIN.
- MAINTAIN EMERGENCY VEHICLE ACCESS AROUND BUILDING SITE.
- COORDINATE WITH OWNER FOR CONSTRUCTION FENCE LOCATION, VEHICLE ACCESS, CONTRACTOR PARKING, AND LAYDOWN AREA.
- REFER TO MEP DEMOLITION PLANS, NOTES, AND SPECIFICATIONS FOR INFORMATION ON OTHER EXISTING MECHANICAL, ELECTRICAL, AND PLUMBING EQUIPMENT.
- ALL WORK SHALL BE IN ACCORDANCE WITH ALL APPLICABLE CODES, REGULATIONS, AND ORDINANCES HAVING THE JURISDICTION.
- CONTRACTOR'S FORCES ARE NOT ALLOWED TO USE TOILET ROOMS, LAVATORIES SHALL NOT BE USED AS CONTRACTOR WORK CLEANING AREAS.
- CONTRACTOR SHALL CAP AND PLUG EXISTING WATERLINES WITHIN PROJECT LIMITS. SERVICES SHALL REMAIN OPERATIONAL AT ALL TIMES DURING SCHOOL HOURS. DISRUPTION IN SERVICES SHALL BE SCHEDULED AFTER 7PM, WITH DISTRICT APPROVAL.
- THE GC TO DISCONNECT, REMOVE ALL REPLACED HVAC EQUIPMENT, MARKER BOARD, WHITE BOARDS AND OTHER RELATED REMOVED ITEMS FOR FACILITIES TO HAUL OFF. ONCE REMOVED, THE GENERAL CONTRACTOR TO PROVIDE TWO WEEKS FOR THE FACILITIES TO HAUL OFF THESE ITEMS. IF FACILITIES DOES NOT HAUL OFF SALVAGED ITEMS IN 2 WEEKS, THE CONTRACTOR TO REMOVE ALL SALVAGED ITEMS AT NO COST TO THE OWNER.
- NO WORK INSIDE THE EXISTING SCHOOL ALLOWED DURING SCHOOL HOURS.
- ALL OUTDOOR WORK WILL BE ALLOWED DURING SCHOOL HOURS ONCE OK BY SCHOOL DISTRICT SAFETY AND SCHOOL MANAGEMENT.
- CONTRACTOR MUST TEST EXISTING ACCESS CONTROL, SECURITY, PUBLIC ADDRESS & FIRE ALARM SYSTEMS PRIOR TO START OF ANY WORK. IF ANY DEFICIENCY FOUND, BRING IT TO AECOM PM ATTENTION IN WRITING. IF CONTRACTOR CHOOSE TO START THE WORK WITHOUT TESTING THESE EXISTING SYSTEMS, THE CONTRACTOR WILL BE RESPONSIBLE FOR MAINTAINING THESE SYSTEMS AT NO COST TO THE OWNER.
- THE EXISTING SYSTEMS (PA, FA, ACCESS CONTROL, SECURITY & HVAC CONTROL) MUST STAY OPERATIONAL THROUGHOUT THE CONSTRUCTION PHASE UNTIL THE NEW SYSTEMS ARE ACTIVATED.
- IN CASE OF CEILING TILES / GRID TO BE REMOVED, MAKE SURE THAT ALL CEILING MOUNTED DEVICES LIKE PA SPEAKERS, WIFI DEVICES, PROJECTOR MOUNT ETC. TO BE REMOVED, SAFELY STORED AND RE-INSTALLED BY THE CONTRACTOR.
- IN CASE OF ANY EXISTING CIRCUIT / POWER TO BE REUSED, CONTRACTOR TO MUST VERIFY THE VOLTAGE / PHASE / BREAKER SIZE PRIOR TO ORDERING ANY NEW EQUIPMENT OR LIGHT FIXTURE TO MATCH THE EXISTING ONES.

DEMOLITION LEGEND

●

●

●

●

PROPERTY LIMIT LINE

DEMOLITION OF EXISTING, ALL ASSOCIATED FINISHES & EQUIPMENTS

■

■

■

■

NON RENOVATED AREA

■

■

■

■

■

■

■

■

⊙

⊙

⊙

⊙

⊙

⊙

⊙

⊙

KEYNOTE LEGEND

D.101	EXISTING CURB CUT AND SLIDING GATE TO BE UTILIZED. REMOVE EXISTING GRASS AND SIDEWALK AREA AS NEEDED TO ACCOMMODATE NEW ENTRY ASPHALT PAVING AND CONCRETE CURB RADIUS PER NEW SITE WORK.
D.102	EXISTING CONCRETE CURB AND SOD AREA TO BE REMOVED
D.104	LINE OF NEW BUILDING
D.105	EXISTING CONCRETE PAVING TO BE REMOVED
D.106	EXISTING CONCRETE CURB, SOD AND SIDEWALK TO BE REMOVED AS NEEDED TO PROVIDE NEW DRIVE ENTRY PER NEW SITE WORK.
D.107	EXISTING CONCRETE PAVING TO REMAIN
D.108	EXISTING 6TH ORNAMENTAL FENCE TO REMAIN
D.109	EXISTING TRACK SURFACE TO REMAIN
D.110	EXISTING TRACK SURFACE TO BE REMOVED
D.111	EXISTING ASPHALT PAVING TO REMAIN
D.112	SAW CUT AND REMOVE EXISTING CONCRETE LANDING, STEPS, FOUNDATION AND FOOTINGS
D.113	EXISTING PLAYGROUND AREA TO BE REMOVED. EXISTING GROUNDCOVER, BORDER WALLS, AND PLAYGROUND EQUIPMENT TO BE SALVAGED AND RELOCATED.
D.114	EXISTING PLAYGROUND AREA TO REMAIN
D.115	EXISTING MASONRY SCREEN WALL TO REMAIN
D.116	EXISTING MASONRY SCREEN WALL AREA TO BE REMOVED
D.117	EXISTING ORNAMENTAL FENCE AND GATE TO BE REMOVED
D.118	EXISTING LIGHT POLE, BASE AND FOOTING TO BE REMOVED
D.119	EXISTING GATE TO BE REMOVED
D.121	EXISTING CONCRETE RAMP/STAIR AND ASSOCIATED HANDRAILS TO BE REMOVED
D.122	EXISTING CONCRETE DRAINAGE CHANNEL TO REMAIN
D.123	EXISTING DAYCARE BUILDING AND GRAVEL LOT TO BE REMOVED IN PREPARATION FOR NEW PARKING LOT. SEE ALSO CIVIL.
D.124	EXISTING CONCRETE STAIR AND CONCRETE FOUNDATION TO REMAIN
D.141	EXISTING IRRIGATION SPRINKLER HEAD TO BE REMOVED
D.142	EXISTING TRANSFORMER AND CONCRETE PAD TO REMAIN
D.149	EXISTING FIRE HYDRANT AND UTILITIES TO BE RELOCATED. SEE ALSO CIVIL AND MEP

KEYPLAN

723 South Flores,
San Antonio, Texas 78204
Tel: (210) 349-1163
www.alta-architects.com

Permit/Seal

06.24.24

Consultant

Client/Project

SAN ANTONIO INDEPENDENT SCHOOL DISTRICT

BOND 2020 FOX TECH CAMPUS

ADDITIONS & RENOVATIONS

637 N. MAIN AVE.
SAN ANTONIO, TEXAS 78205

DATE

06/24/24

CONSTRUCTION DOCUMENTS

PROJECT NO.

A202108.00

DRAWN BY

Author

CHECKED BY

Checker

ISSUE / REVISIONS

#	DESCRIPTION	DATE
1	PERMIT SET	08/23/24

Sheet Name

REFERENCE SITE PLAN - DEMOLITION

Drawing No.

A-001D

Client/Project

BOND 2020 FOX TECH CAMPUS ADDITIONS & RENOVATIONS

637 N. MAIN AVE.

DATE
06/24/24

CONSTRUCTION DOCUMENTS

PROJECT NO. DRAWN BY CHECKED BY
A202108.00 **Author** **Checker**

ISSUE / REVISIONS

#	DESCRIPTION	DATE
	PERMIT SET	08/23/2


PERMIT SET

Sheet Name
**ENLARGED SITE
DEMOLITION**

Drawing No.

A-002D



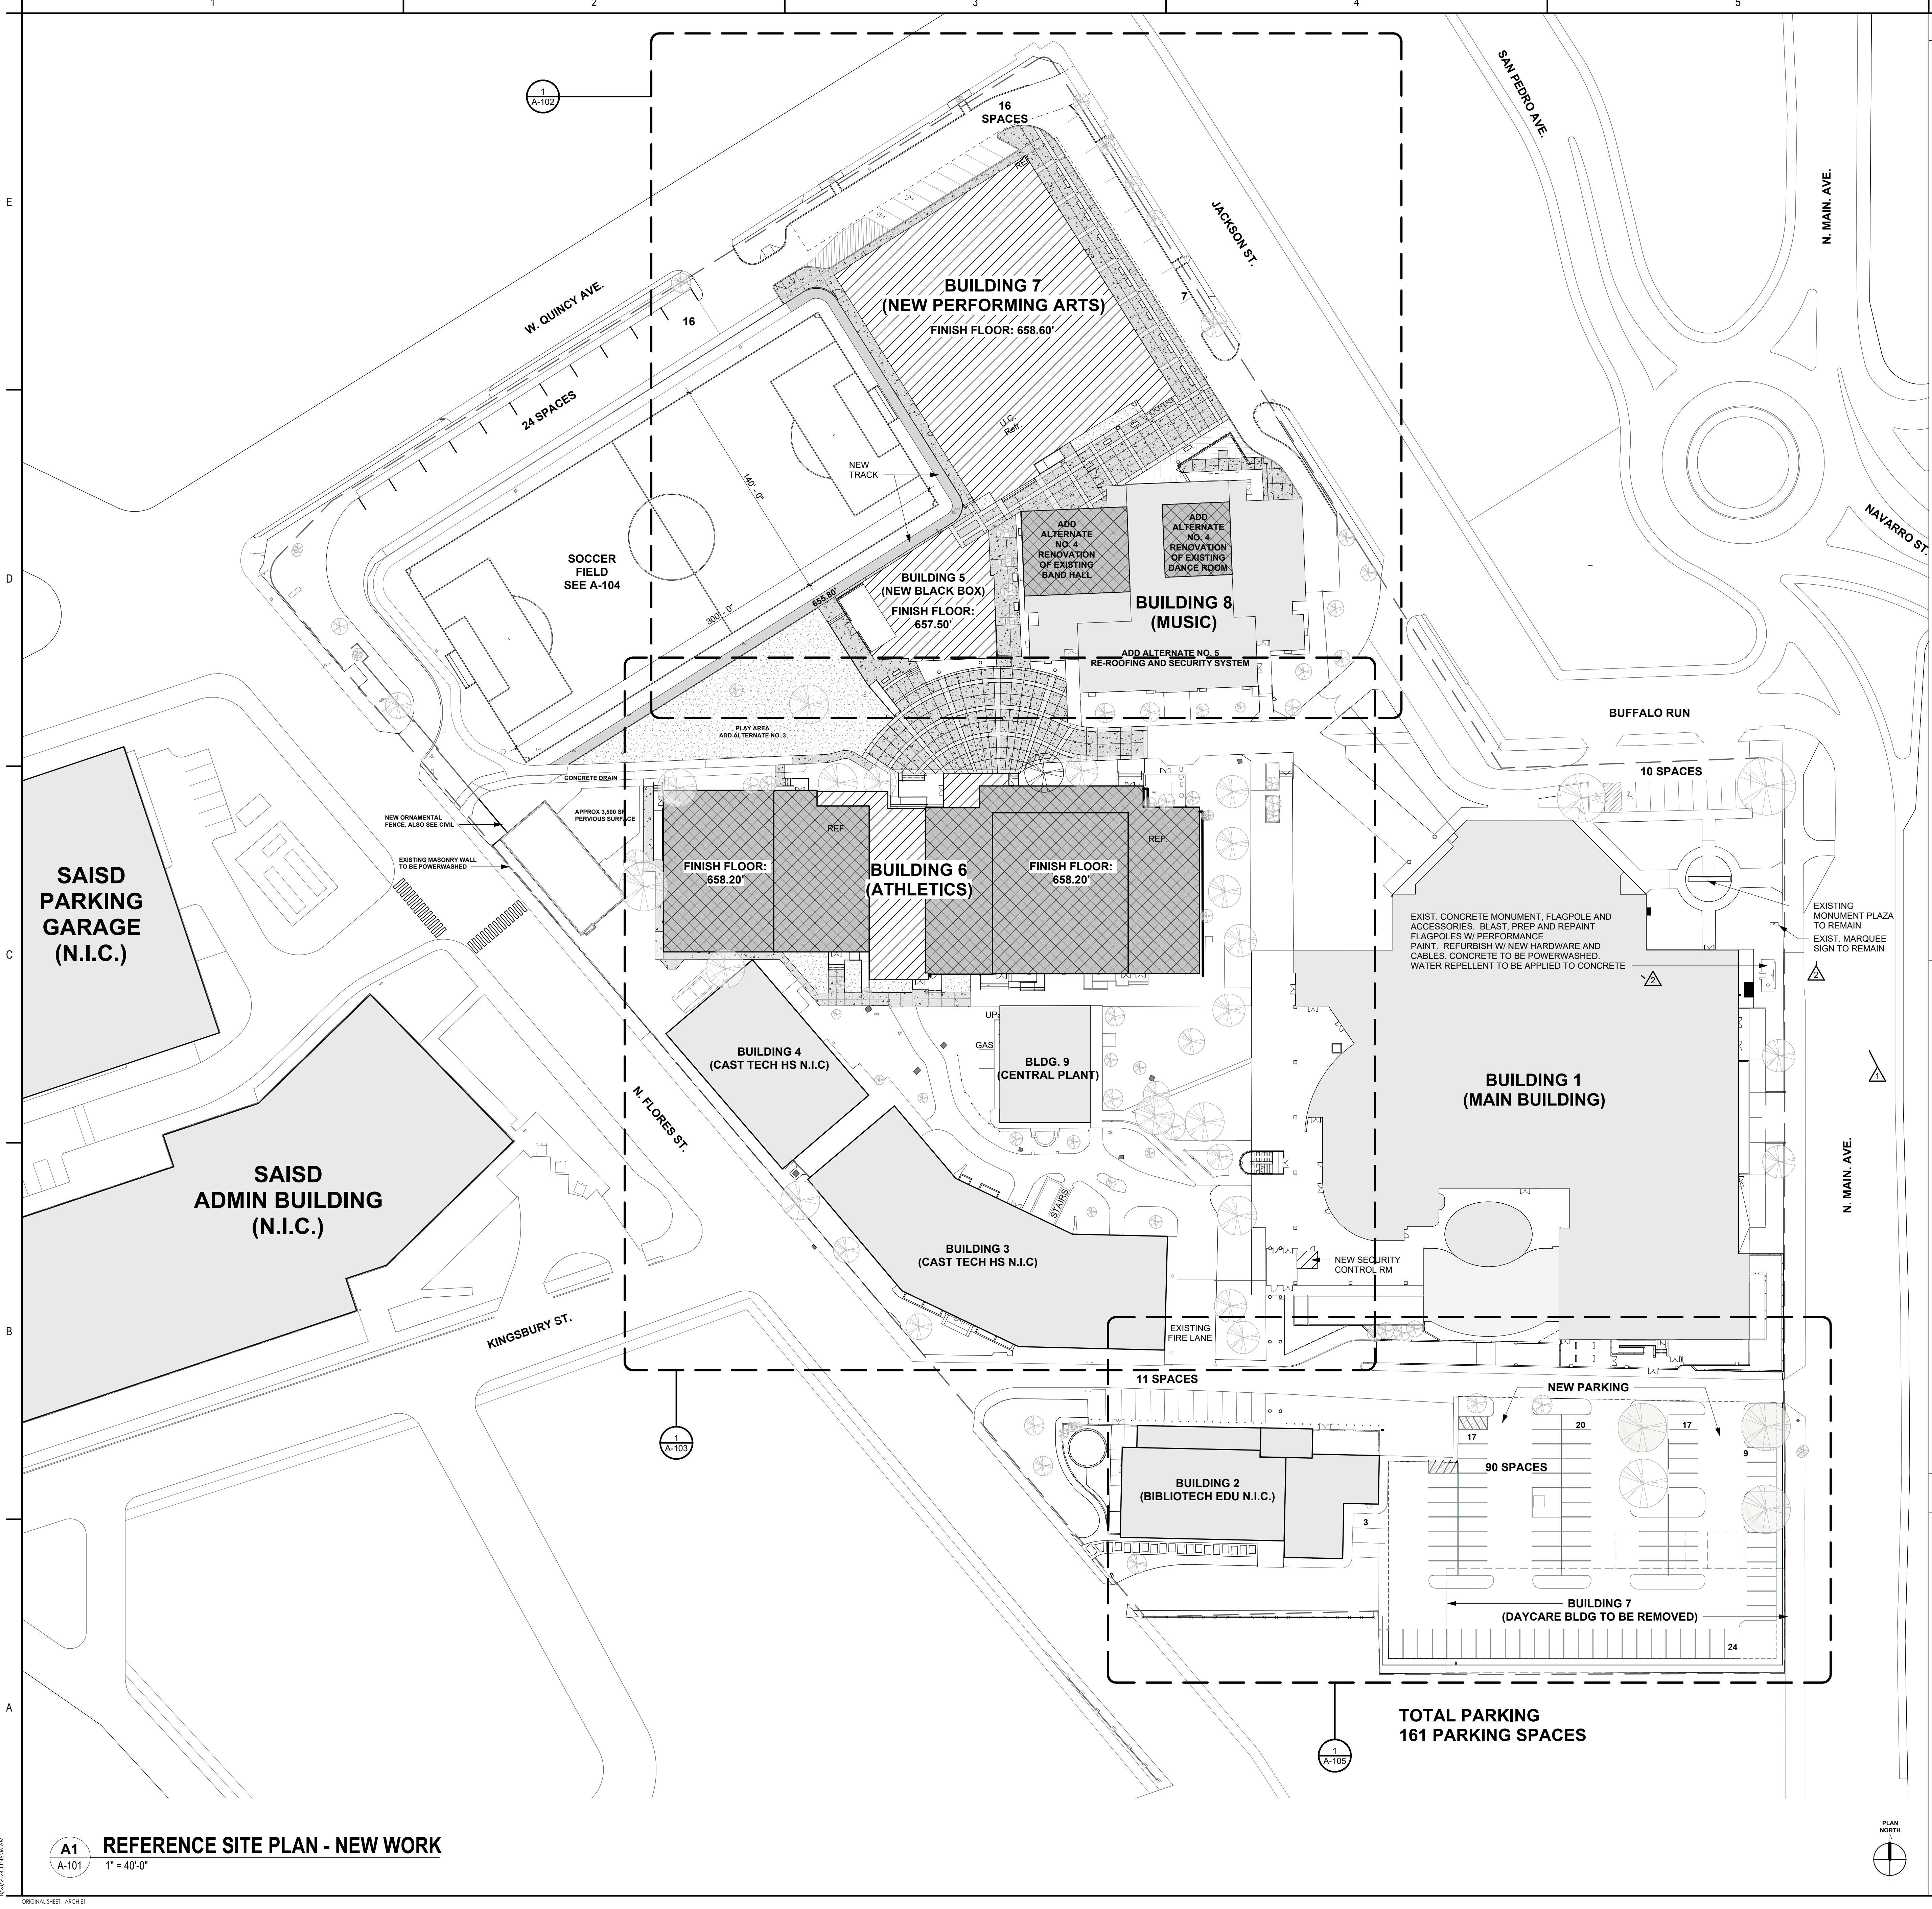

SITE REFERENCE PLAN GENERAL NOTES

- REFER TO CIVIL, MEP AND LANDSCAPE DRAWINGS FOR ADDITIONAL DIMENSIONAL, ELEVATION INFORMATION, AND SITE DETAILING FOR FINISH GRADING, PAVING IMPROVEMENTS AND SITE UTILITIES NOT SHOWN HERE, ALSO INCLUDING TRAFFIC SIGNAGE, SIGNAL DEVICES, AND MARKINGS.
- REFER TO CIVIL FOR ALL PAVING EXPANSION JOINTS AND CONTROL JOINTS SPACING AT GENERAL WALKS WHERE NOT SHOWN ON ARCHITECTURAL OR LANDSCAPE PLANS.
- FOR LANDSCAPING NOT SHOWN, REFER TO LANDSCAPING PLANS.
- THE CONTRACTOR, IN SUBMITTING A BID FOR THIS WORK, IS ASSUMED TO HAVE THOROUGHLY FAMILIARIZED HIMSELF WITH ALL EXISTING CONDITIONS AT THE PROJECT SITE AND TO HAVE REQUESTED, FROM THE ARCHITECT, CLARIFICATION FOR ANY DISCREPANCIES AND/OR AMBIGUOUS ITEMS ENCOUNTERED AFTER THOROUGHLY READING THE CONSTRUCTION DOCUMENTS. (DRAWINGS & SPECIFICATIONS)
- THE CONTRACTOR SHALL FIELD VERIFY ALL EXISTING & PROPOSED DIMENSIONS, CONDITIONS, AND WORK, AND SHALL NOTIFY THE ARCHITECT OF ANY DISCREPANCIES AND/OR AMBIGUITIES BETWEEN THE CONSTRUCTION DOCUMENTS AND ACTUAL CONDITIONS PRIOR TO PROCEEDING WITH PROCURING AFFECTED MATERIALS OR PROCEEDING THE WORK.
- DO NOT SCALE THESE DRAWINGS. USE DIMENSIONS THAT ARE ON THE DRAWINGS OR ARE PROVIDED BY THE ARCHITECT OR OWNER VERIFY ALL DIMENSIONS BY FIELD MEASUREMENT.
- VERIFY LOCATION OF ALL EXISTING UTILITIES AND TIE-IN POINTS PRIOR TO PROCEEDING WITH ANY WORK. CALL 811 SERVICE PRIOR TO ANY DIGGING. REFER TO S.U.E. SURVEYS PROVIDED TO OWNER.
- CONTRACTOR SHALL ASSURE ACCESSIBILITY OF FIRE TRUCKS AT ALL TIMES ON ALL PUBLIC STREETS, DRIVEWAYS, AND ARE AS DESIGNATED FIRE LANES. ANY DAMAGE OUTSIDE OF CONSTRUCTION AREA BY THE CONTRACTORS CAUSING THE DAMAGE WILL BE REQUIRED TO BE REPAIRED TO MATCH EXISTING CONDITIONS.
- THE CONTRACTOR SHALL BE RESPONSIBLE FOR PROVIDING ALL COSTS AND OBTAIN ALL NECESSARY PERMITS AND APPROVALS FROM ALL AGENCIES HAVING JURISDICTION OVER THE PROJECT, INCLUDING BUT NOT LIMITED TO STREET CLOSURES, DEMOLITION AND RESURFACING OF EXISTING R.O.W. CONSTRUCTION REQUIRED TO INSTALL UTILITIES, AND OTHER WORK REQUIRED BY PUBLIC AGENCIES.
- THE CONTRACTOR SHALL BE RESPONSIBLE FOR PROVIDING ALL COSTS ASSOCIATED WITH ANY PROTECTION MEASURES THAT WILL BE REQUIRED BY THE CONSTRUCTION/DEMOLITION ACTIVITIES TO SAFEGUARD THE HEALTH, SAFETY AND WELFARE OF THE PUBLIC.
- PROVIDE TEMPORARY GRAPHIC CONSTRUCTION SIGNS, DIRECTIONAL SIGNS AND ANY OTHER SIGNS THAT MAY BE REQUIRED TO DIRECT PEDESTRIAN AND VEHICULAR TRAFFIC DURING CONSTRUCTION.
- ALL UTILITY MANHOLES, FIRE HYDRANTS AND FIRE DEPARTMENT CONNECTIONS SHALL BE PROTECTED DURING THE CONSTRUCTION PERIOD. PROVIDE ACCESS TO THE SAME WHEN NEEDED BY THE UTILITY AGENCIES.
- THE CONTRACTOR SHALL BE RESPONSIBLE FOR VISITING THE SITE AND FAMILIARIZING HIMSELF WITH ALL EXISTING CONDITIONS THAT WILL AFFECT THE DEMOLITION AND CONSTRUCTION OF ALL WORK REQUIRED TO COMPLETE THIS PROJECT, AND INCORPORATE ALL SUCH CONDITIONS INTO ITS BID.
- NOT ALL LANDSCAPE, MEP, AND CIVIL SITE WORK AND IMPROVEMENTS ARE SHOWN ON ARCHITECTURAL SITE PLANS. SEE ALSO LANDSCAPE, CIVIL, TECHNOLOGY AND MEP DRAWINGS.
- RESTORE AND FILL TO DESIGN FINISH GRADE WHERE SITE ITEMS AND IMPROVEMENTS REMOVED.
- PROVIDE AND COORDINATE CONSTRUCTION SITE FENCING AND EVERY CONSTRUCTION GATE LOCATION WITH OWNER. PROVIDE CONSTRUCTION FENCING AROUND ENTIRE SITE REQUIRED BY OWNER.
- PROVIDE EXPANSION JOINT SLIP DOWELS TO BUILDING AND STRUCTURAL SLAB, FROM PAVING, AT PAVING TO ENTRY DOOR AREAS AND AT ALL PAVING EXPANSION JOINTS.
- PROVIDE 1/2" MIN. EXP JOINT W/SEALANT AND FILLER AT ALL LOCATIONS WHERE CONCRETE SITE PAVING ABUTS BUILDINGS, STRUCTURAL SLABS, AND SITE WALLS.
- REFER TO CIVIL AND LANDSCAPING FOR ALL SITE ELEMENTS AND WORK NOT INDICATED.
- PHASE SITE WORK TO ALLOW FOR CONTINUOUS SCHOOL OPERATIONS DURING CONSTRUCTION. PROVIDE MINIMUM 48 HOUR NOTICE OF ANY DISCONTINUATION TO UTILITIES.

SITE LEGEND

- NEW BUILDING
- EXISTING BUILDING TO BE RENOVATED
- EXISTING BUILDING TO REMAIN
- NEW CONCRETE PAVING/WALK, (BROOM FINISH) REF. TO CIVIL
- NEW CONC. PAVING/WALK, (STAINED BROOM FINISH) REF. TO CIVIL
- PLANTING AREA, REF. TO LANDSCAPE
- DECOMPOSED GRANITE, REF. TO LANDSCAPE
- EXISTING LANDSCAPE, REF. TO LANDSCAPE FOR EXTENTS. NEW SOD/PLANTING/GROUND COVER
- PLANTING BED WITH IRRIGATION, REF. LANDSCAPE
- NEW TREE (BOLD), REF. LANDSCAPE
- EXISTING TREE (HALFTONE)

KEYPLAN

723 South Flores,
San Antonio, Texas 78204
Tel: (210) 349-1163
www.alta-architects.com

Permit/Seal

06.24.24

Consultant

Client/Project

SAN ANTONIO INDEPENDENT SCHOOL DISTRICT

BOND 2020 FOX TECH CAMPUS ADDITIONS & RENOVATIONS

637 N. MAIN AVE.
SAN ANTONIO, TEXAS 78205

DATE
06/24/24

CONSTRUCTION DOCUMENTS

PROJECT NO.
A202108.00

DRAWN BY
RL, DR

CHECKED BY
RH


ISSUE / REVISIONS

#	DESCRIPTION	DATE
	PERMIT SET	08/23/24
1	ADDENDUM #01	07/17/24
2	ADDENDA #02	07/26/24

PERMIT SET

Sheet Name
REFERENCE SITE PLAN

Drawing No.
A-101

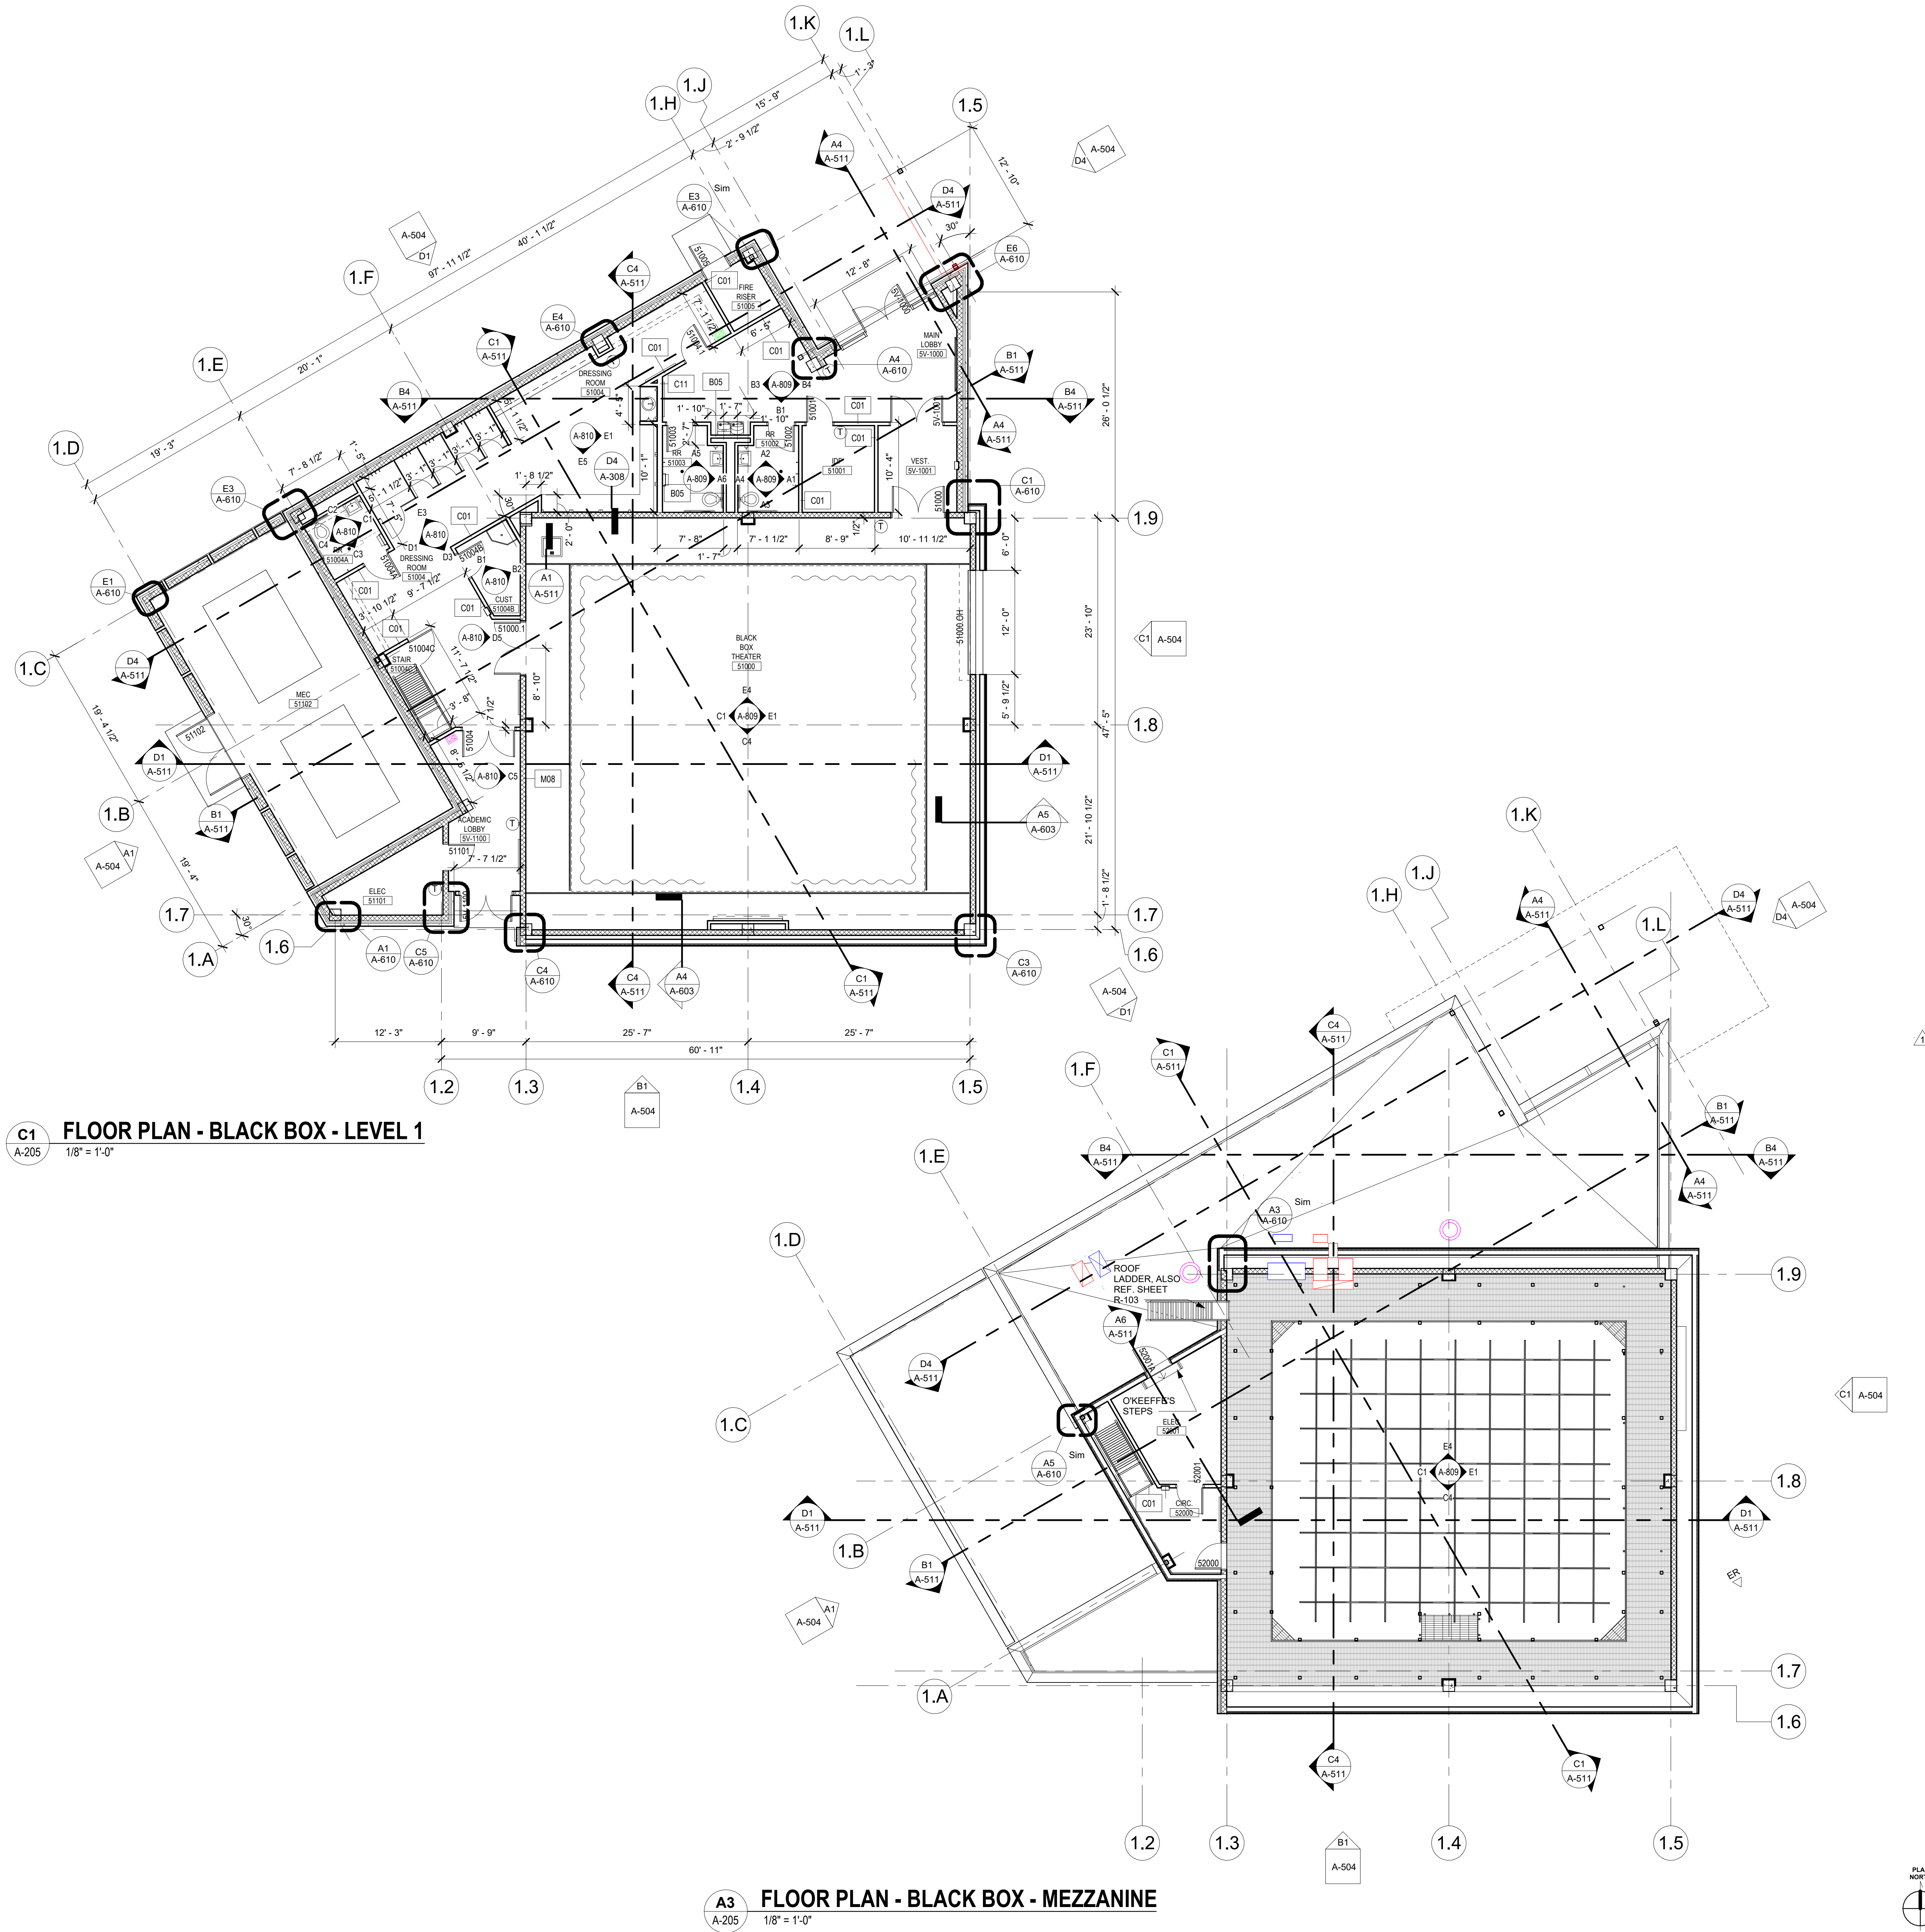

C1 FLOOR PLAN - BLACK BOX - LEVEL 1
A-205 1/8" = 1'-0"

A3 FLOOR PLAN - BLACK BOX - MEZZANINE
A-205 1/8" = 1'-0"



FLOOR PLAN GENERAL NOTES

1. FIELD VERIFY ALL DIMENSIONS TO EXISTING CONSTRUCTION BEFORE STARTING CONSTRUCTION. NOTIFY ARCHITECT OF ANY DISCREPANCIES.
2. REFER TO MEP DRAWINGS FOR OTHER ITEMS, EQUIPMENT AND DEVICES TO BE COORDINATED WITH FLOOR PLANS. PROVIDE ALL CUT OUTS AND BLOCK OUTS REQUIRED.
3. ALL COLUMN FURRING TO BE MIN. 4" CMU TO ABOVE CEILING UNLESS NOTED OTHERWISE.
4. ELECTRICAL BOXES ARE TO BE STAGGERED IN PARTITIONS 16" MIN., NOT BACK TO BACK.
5. PROVIDE ADA DOOR IDENTIFICATION SIGNS AT ALL DOORS, AND AS INDICATED ON SIGNAGE SHEETS.
6. REFER TO SHEET A-901 & A-902 FOR ROOM FINISH SCHEDULE.
7. PARTITION TYPE, TOILET ACCESSORY MARKER/TACKBOARD, PROJECTION SCREEN AND MOUNTING HEIGHT SCHEDULES AND WATERPROOFING SCHEDULES. REFER TO SHEETS A-901 THRU A-903.
8. REF. A-401 & A-402 FOR DOOR SCHEDULE. DENOTES DOOR NUMBER.
9. REF. A-403 THRU A-405 FOR WINDOW SCHEDULE. DENOTES WINDOW TYPE.
10. DASHED LINE INDICATES 1 HR RATED PARTITION WITH 20 MINUTE DOORS AND FRAMES; 60 MINUTES AT ELECTRICAL CLOSETS. ALSO REFER TO CEILING PLAN FOR LOCATIONS OF PARTITIONS EXTENDING TO STRUCTURE. TYP. ALL FIRE AND RATED PARTITIONS TO RECEIVE FIRE CAULKING TO STRUCTURE AND ABOVE CEILING WHERE CODE REQUIRES. AT PARTITIONS SEAL HEAD COURSE TO STRUCTURE AND SEAL ALL PENETRATIONS.
11. PROVIDE CONTROL JOINTS IN INTERIOR CMU PARTITIONS NO FURTHER APART AS SPECIFIED, UNLESS SHOWN OTHERWISE IN DRAWINGS. COORDINATE EXACT PLACEMENT OF ANY CONTROL JOINTS REQUIRED BUT NOT INDICATED WITH THE ARCHITECT. CONTROL JOINTS TO HAVE SEALANT AND BACKER ROD.
12. ALL INTERIOR DIMENSIONS ARE TO FINISH FACE U.N.O.
13. MB DENOTES MARKER BOARD, TB DENOTES TACK BOARD, PS DENOTES PROJECTION SCREEN. REFER TO INTERIOR ELEVATION SCHEDULES, SHEETS AND SPECIFICATIONS.
14. PROVIDE WINDOW BLINDS AT ALL EXTERIOR AND INTERIOR WINDOW LOCATIONS AND WHERE INDICATED ON THE EXTERIOR.
15. REF. REFLECTED CEILING PLANS FOR WALLS TO STRUCTURE.
16. PROVIDE CORNER GUARDS AT ALL OUTSIDE CORNERS ALONG GENERAL CIRCULATION PATHS OF CORRIDORS, LOBBIES AND OTHER LOCATIONS AS INDICATED. REFER TO DETAIL.
17. REFER TO DOOR SCHEDULE FOR STC RATINGS.
18. ALL INTERIOR CMU PARTITIONS AND OPENINGS TO HAVE BULLNOSE EDGES AT OUTSIDE CORNERS. PROVIDE SQUARE BLOCK EXTERIOR CORNERS AT STARTER COURSES TO FACILITATE RUBBER BASE INSTALLATION AND WHERE COVERED BY TILE.
19. PROVIDE CMU BLOCKOUTS FOR ALL RECESSED AND SEMI-RECESSED TOILET ACCESSORIES, HAND DRYERS, AND OTHER ITEMS.
20. ALL INSTALLED FIRE ALARM DEVICE WALL J-BOXES NOT UTILIZED FOR DEVICES BY THE FIRE ALARM INSTALLER ARE TO BE CONCEALED AND COVERED WITH WALL FINISH.
21. PROVIDE LOCKS ON ALL DRAWERS AND CABINETS.
22. ALL FLOOR DRAINS TO BE RECESSED 1/2" IN 36" X 36" AREA. COORDINATE W/ FLOOR TILE PATTERN.

- NON RENOVATED AREA
EXISTING TO REMAIN
EXISTING AREA TO BE RENOVATED
NEW WORK AREA
NEW WORK

KEYNOTE LEGEND

KEYPLAN

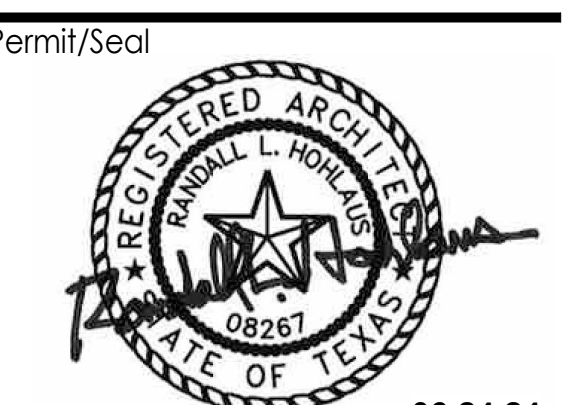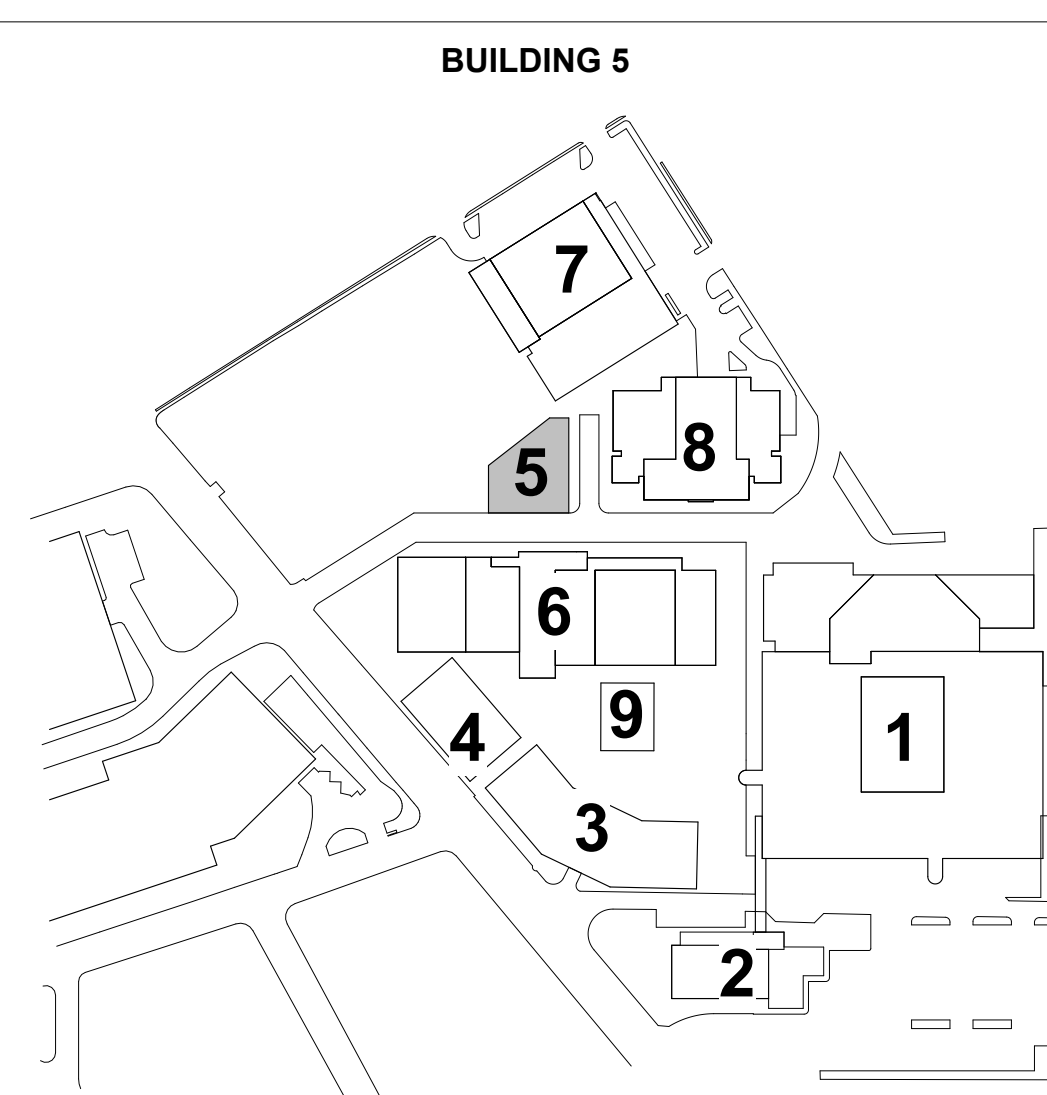

Consultant




SAN ANTONIO INDEPENDENT SCHOOL DISTRICT
BOND 2020 FOX TECH CAMPUS
ADDITIONS & RENOVATIONS
Client/Project
637 N. MAIN AVE.
SAN ANTONIO, TEXAS 78205

DATE		CONSTRUCTION DOCUMENTS	
06/24/24		A202108.00	
PROJECT NO.	DRAWN BY	CHECKED BY	ALTA
A202108.00	RL/PM	ALTA	
ISSUE / REVISIONS			
#	DESCRIPTION	DATE	
1	PERMIT SET	08/23/24	
1	ADDENDA #02	07/26/24	


PERMIT SET

Sheet Name
FLOOR PLAN - BLACK BOX - LEVEL 1 & 2


Drawing No.
A-205

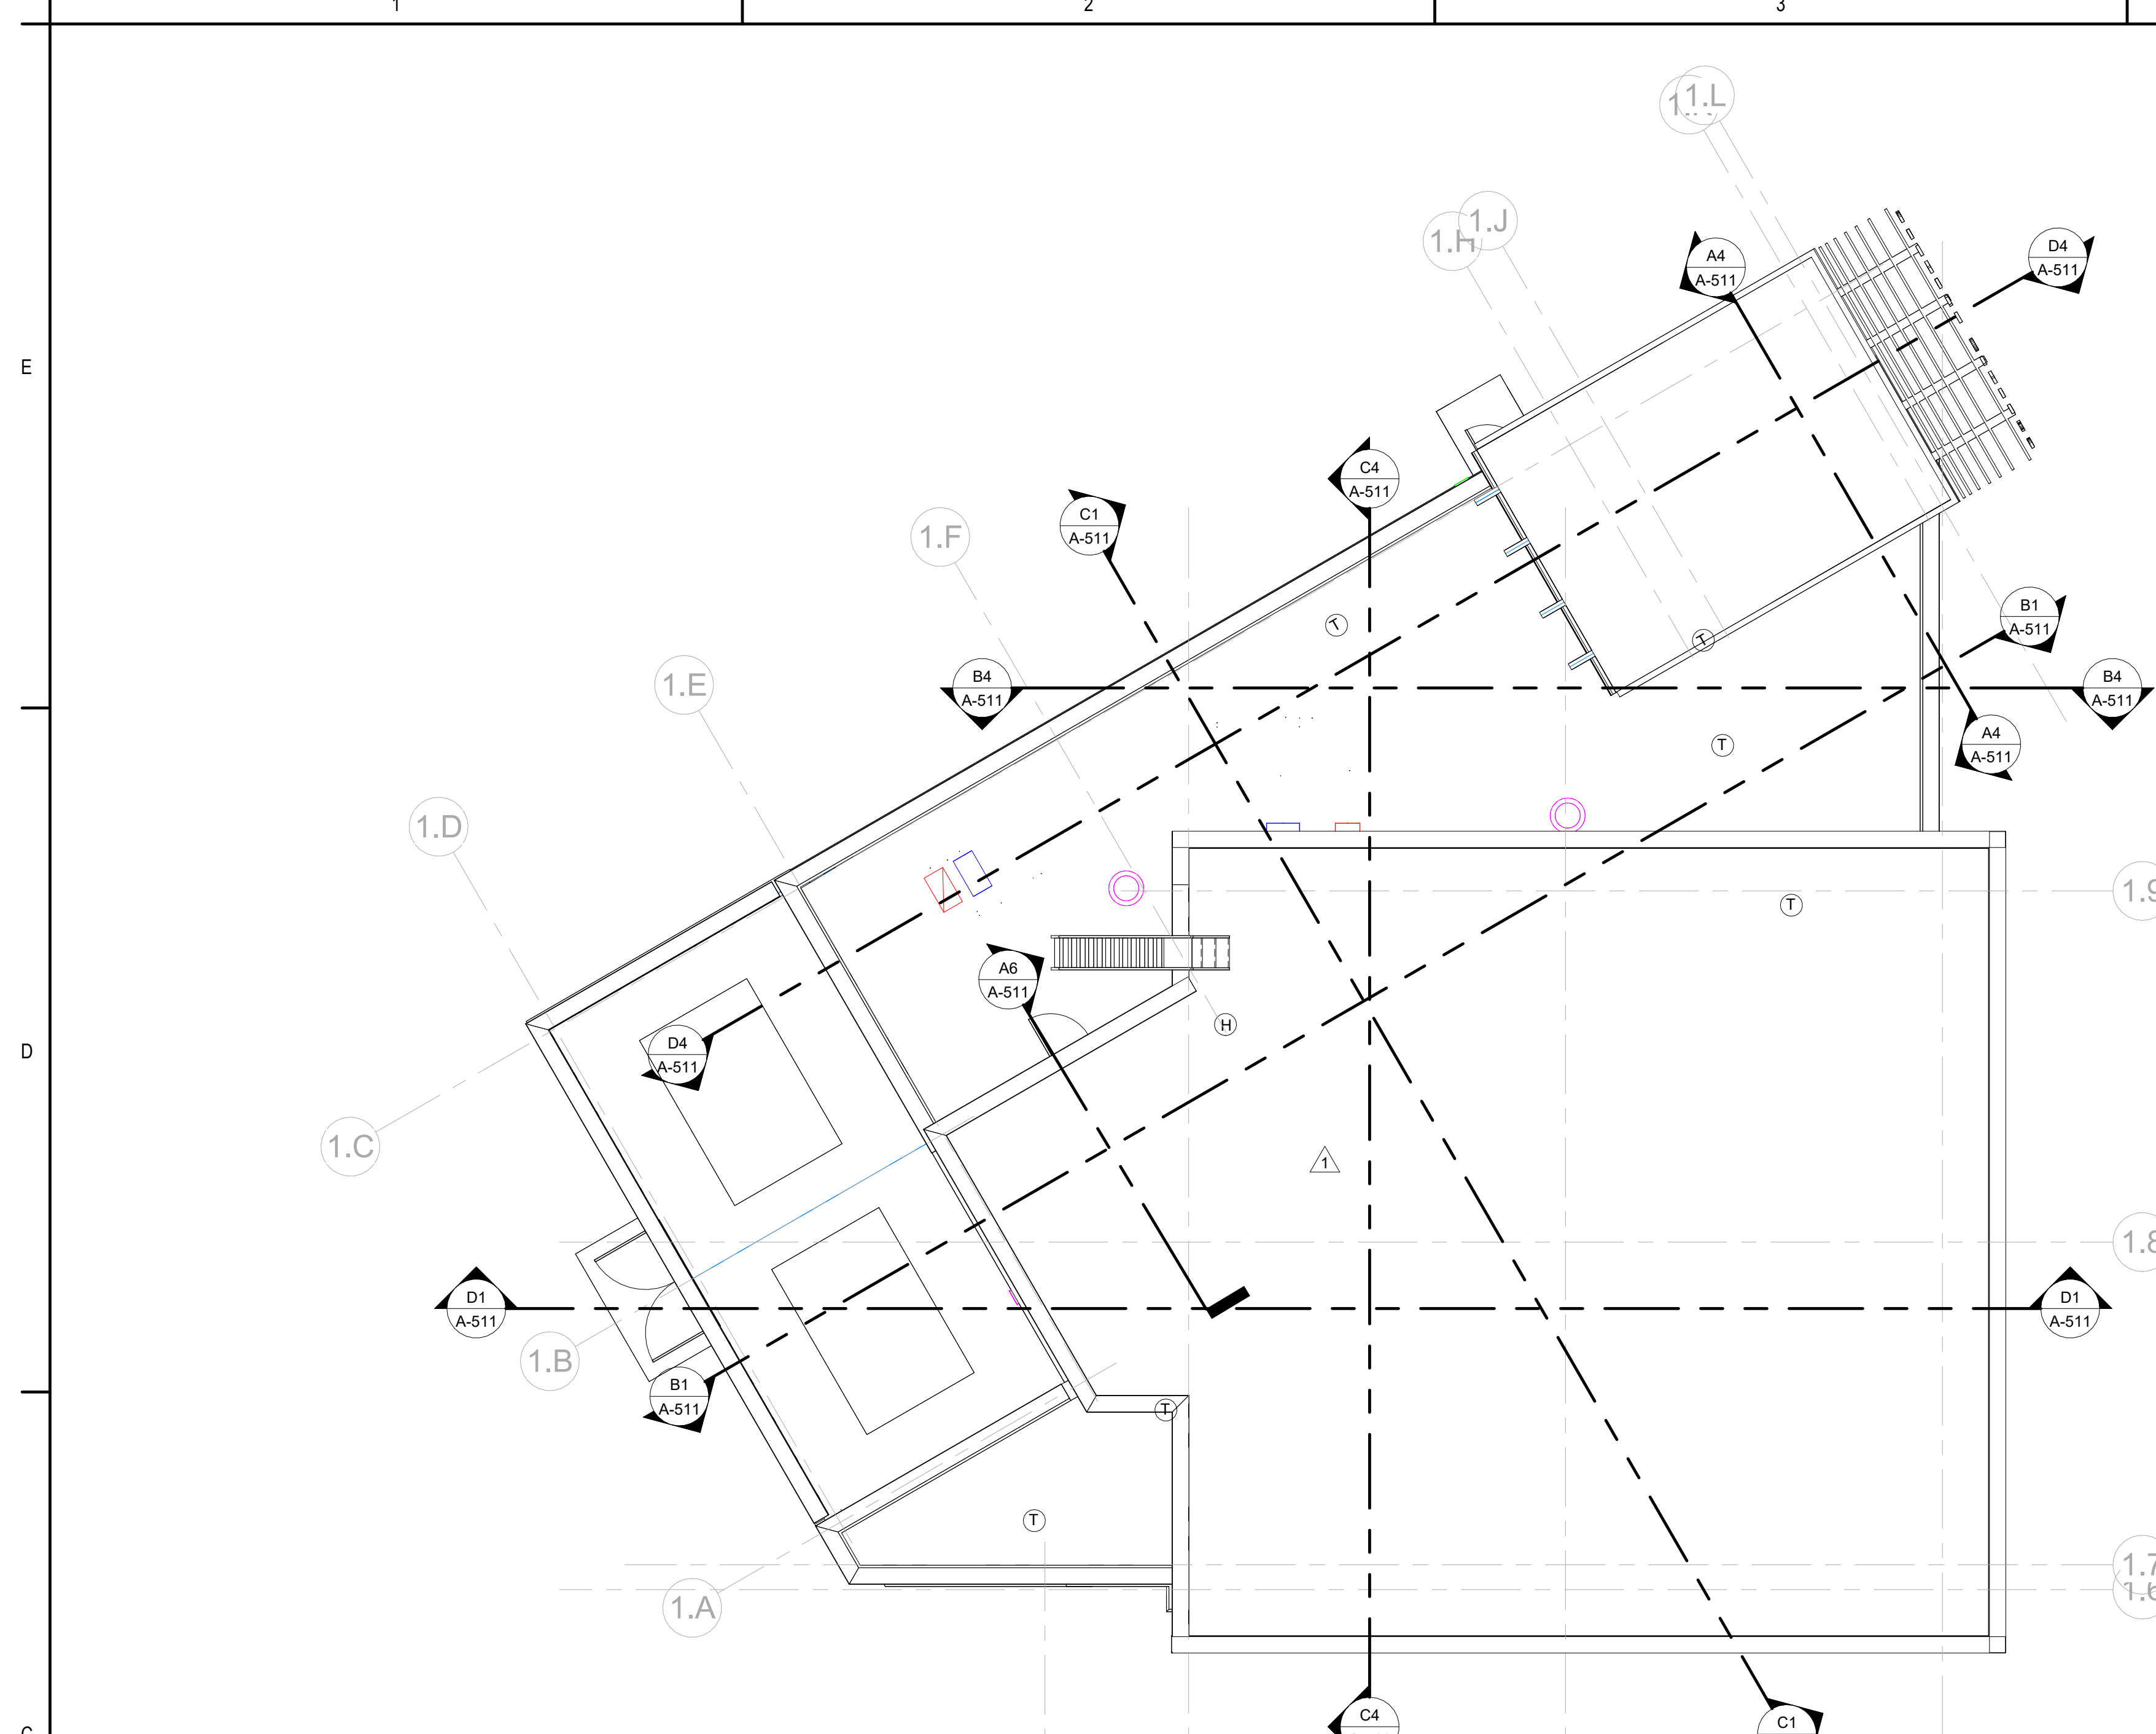


C1 ROOF PLAN - BLACK BOX
A-206 1/8" = 1'-0"

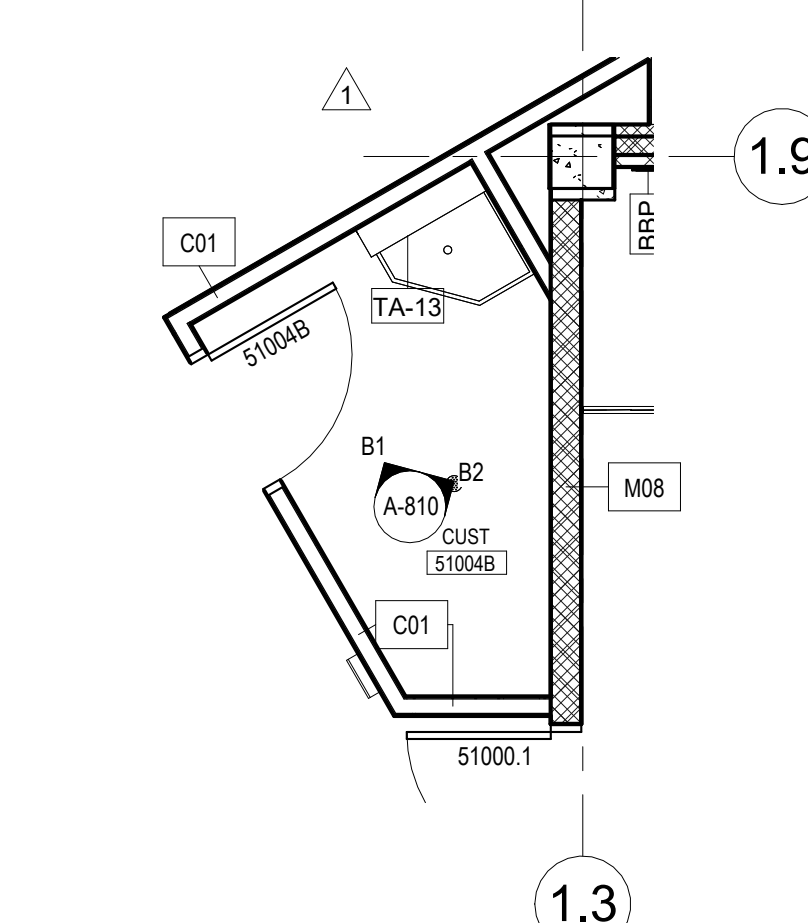


A2 ENLARGED PLAN - BLACK BOX - CUST.
A-206 1/4" = 1'-0"

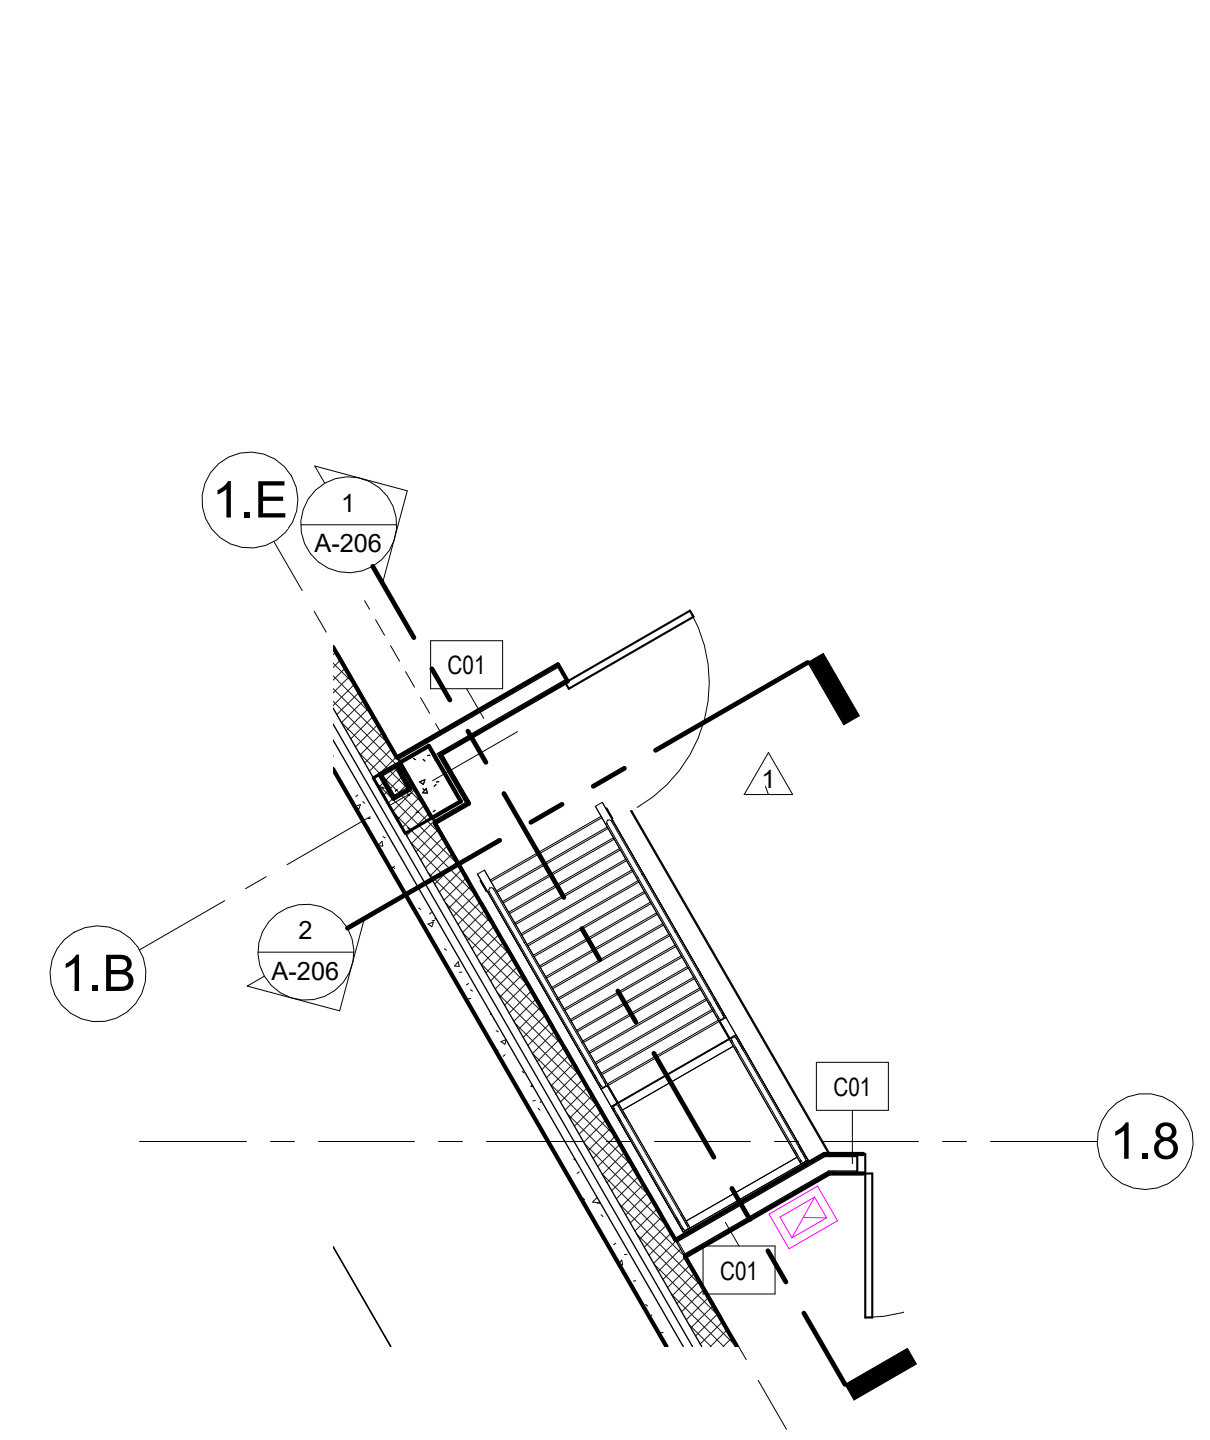


A1 ENLARGED PLAN - BLACK BOX - STAIR
A-206 1/4" = 1'-0"

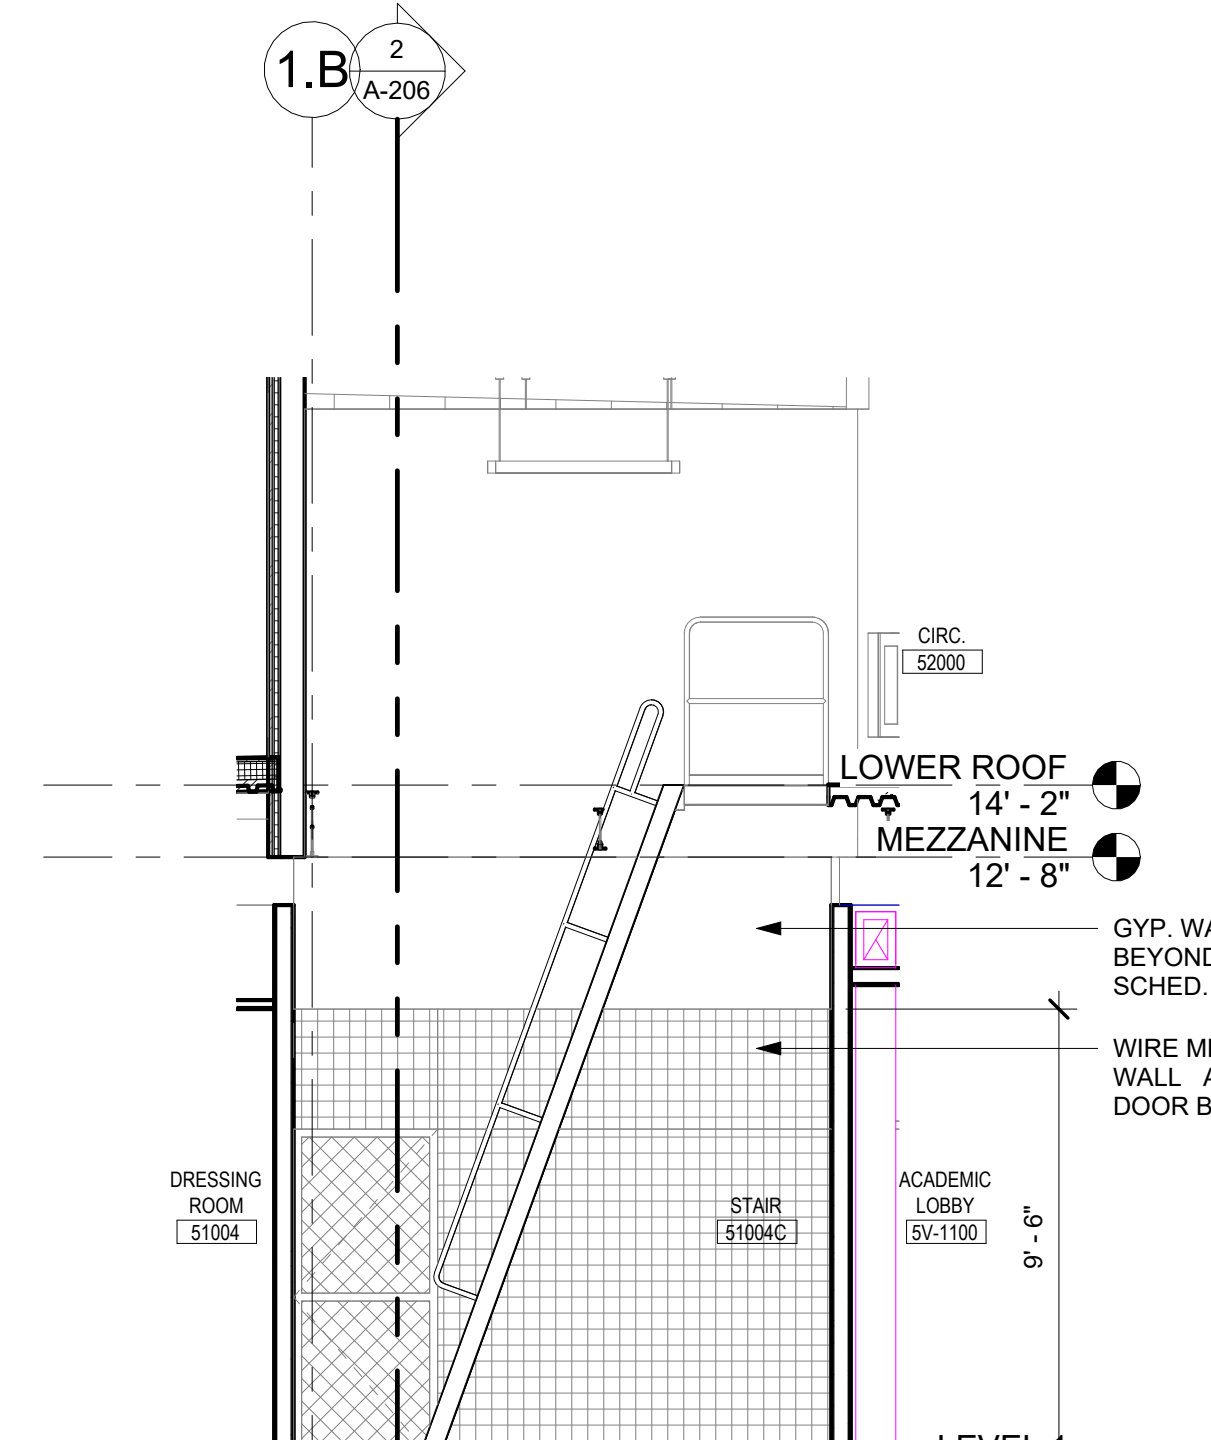

1 SHIP LADDER SECTION
A-206 1/4" = 1'-0"

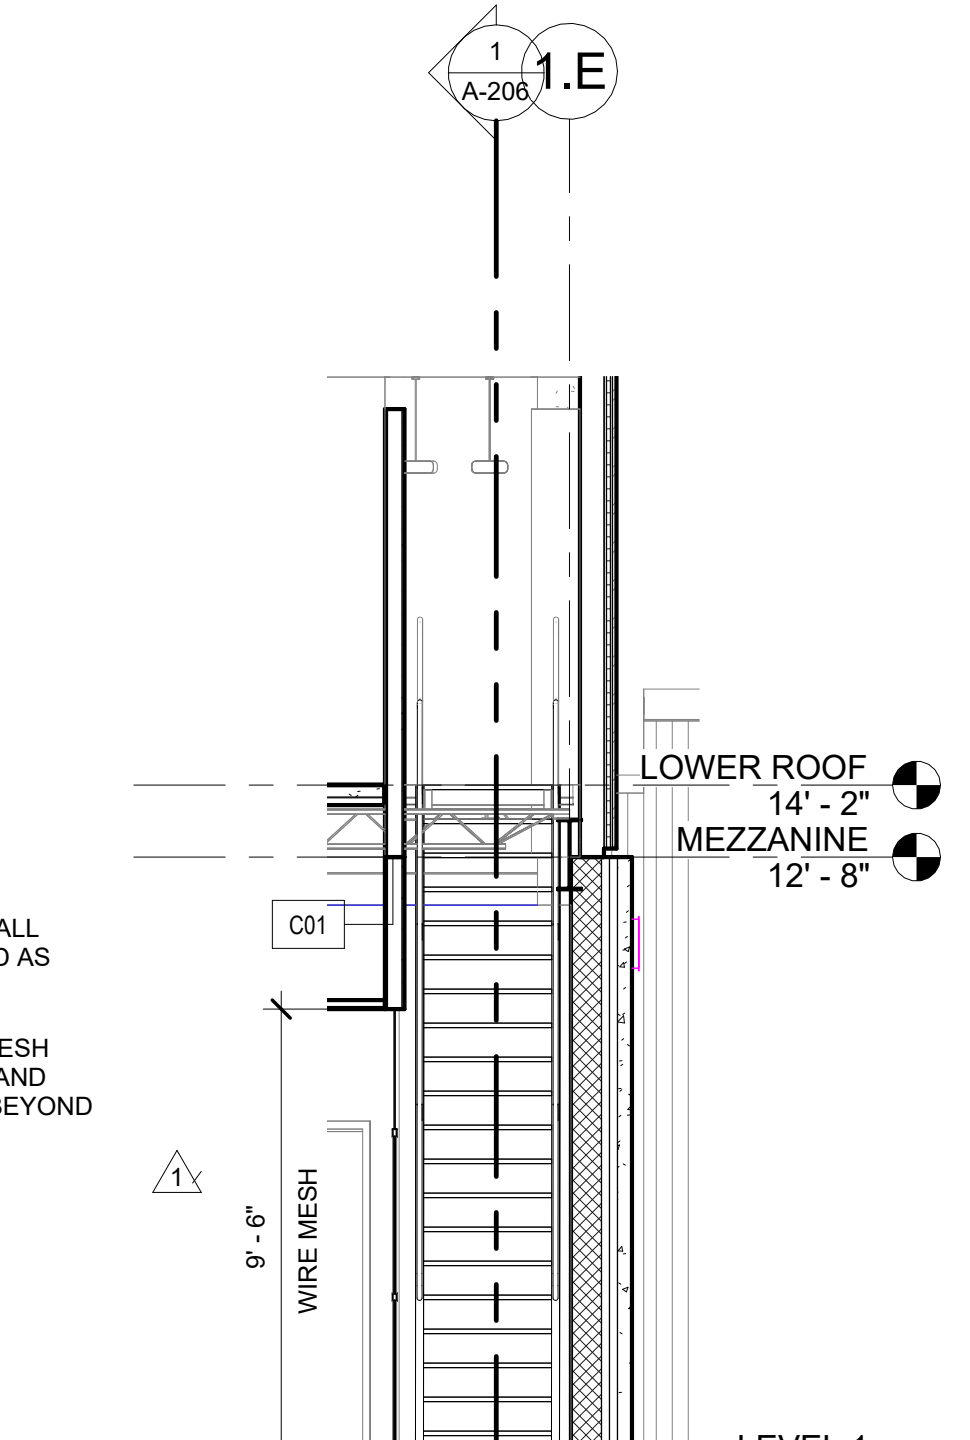



2 SHIP LADDER CROSSECTION
A-206 1/4" = 1'-0"

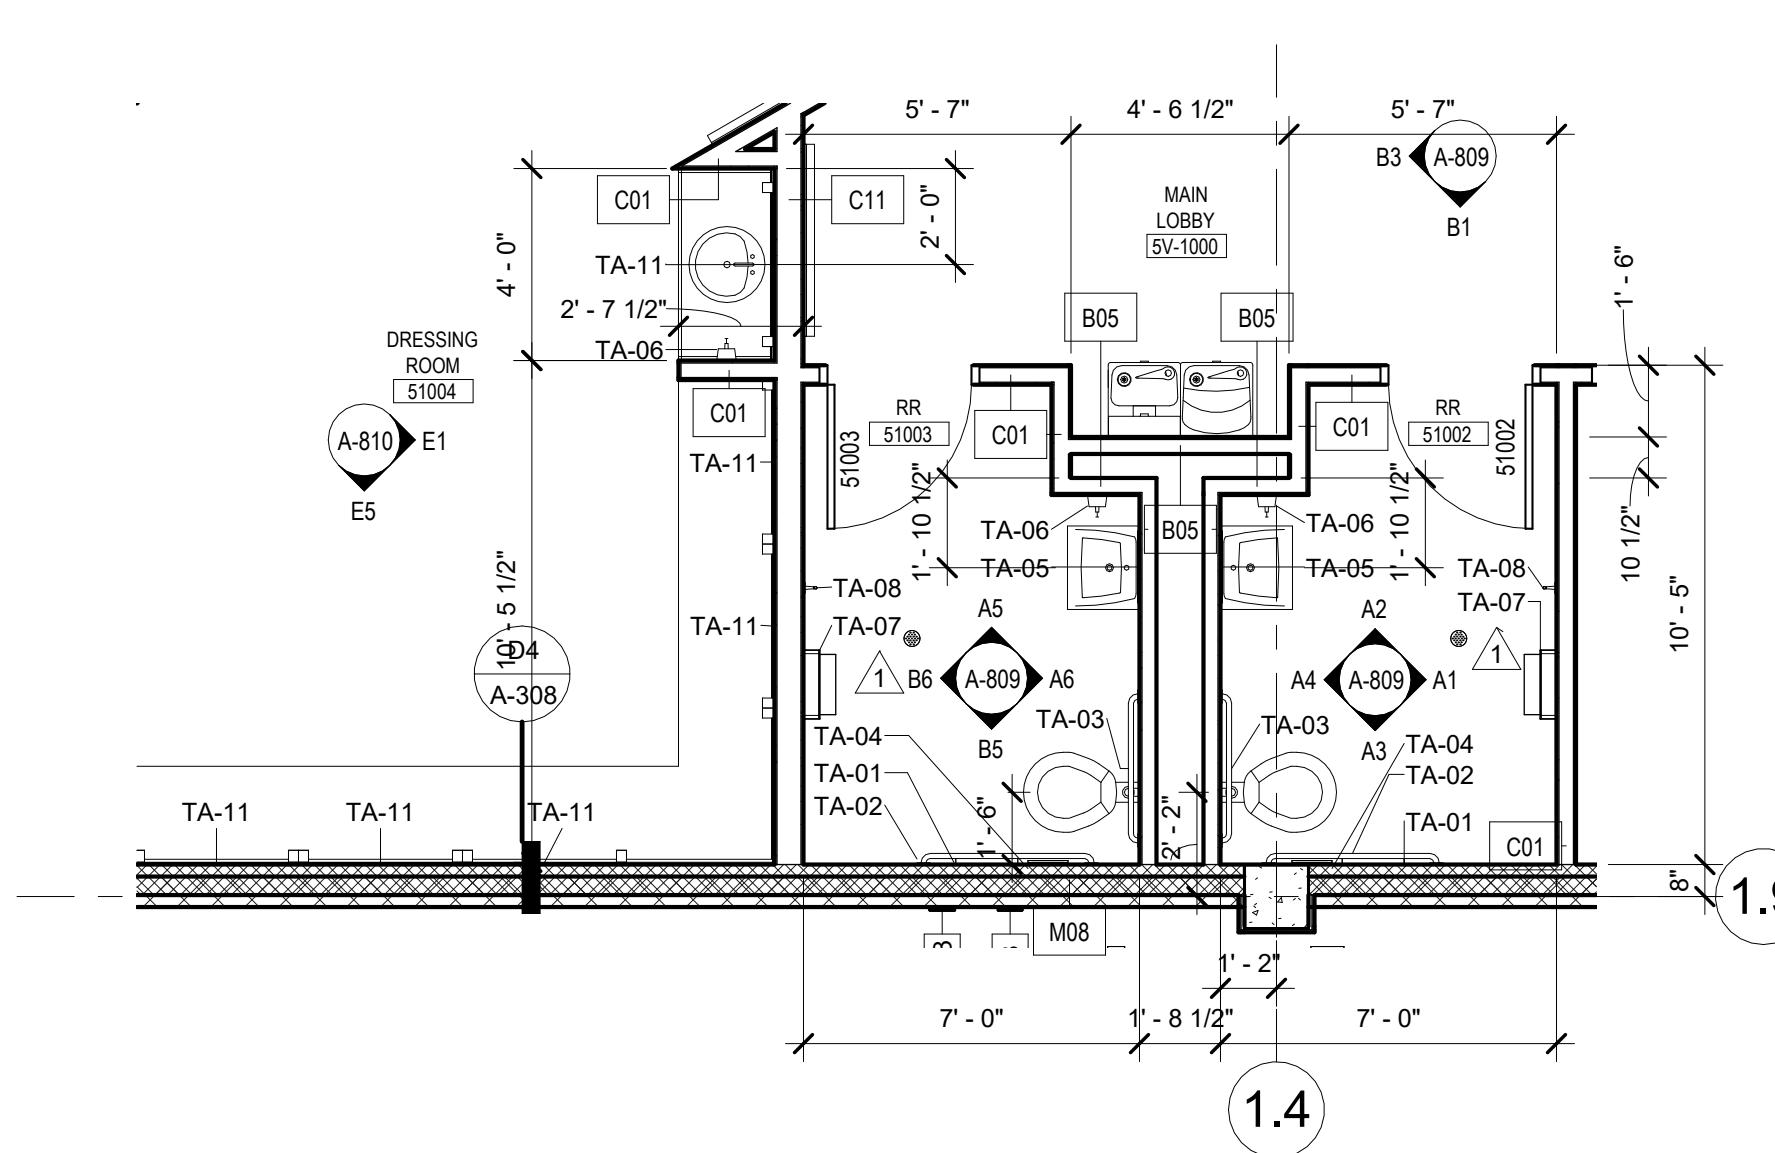

A4 ENLARGED FLOOR PLAN - RESTROOMS & DRESS
A-206 1/4" = 1'-0"

GENERAL NOTES:
INSIDE TOILET STALL DIMENSIONS NOTED ARE FROM FINISH TO FINISH.
MOP RACK TYP. ACCESSORY IN ALL CUSTODIAL

TOILET ACCESSORY SCHEDULE			
MARK	MODEL NO.	MFGR.	DESCRIPTION.
TA-01	58209	Georgia Pacific	SURFACE MOUNTED TOILET PAPER DISPENSER
TA-02	B-6806.99X42	BOBRICK	GRAB BAR 42"
TA-03	B-6806.99X36	BOBRICK	GRAB BAR 36"
TA-04	B-270	BOBRICK	SANITARY NAPKIN DISPOAL
TA-05	B-290	Bobrick	18" x 36" SURFACE MOUNTED MIRROR WITH STAINLESS STEEL FRAME
TA-06	B 9010001	Symmetry	SURFACE MOUNTED FOAM SOAP DISPENSER
TA-07	B-3949(OFCI)	Bobrick	PAPER TOWEL DISPENSER AND DISPOSAL
TA-08	B-6717	BOBRICK	COAT HOOKS
TA-11	B	Bobrick	36" x 36" GLASS MIRROR WITH STAINLESS STEEL FRAME
TA-12	B	Bobrick	72" x 36" GLASS MIRROR
TA-13	B-239	Bobrick Washroom Equipment, Inc.	MOP AND BROOM HOLDER SURFACE MOUNTED WITH CAPACITY OF FOUR HOOKS AND THREE MOP HOLDERS

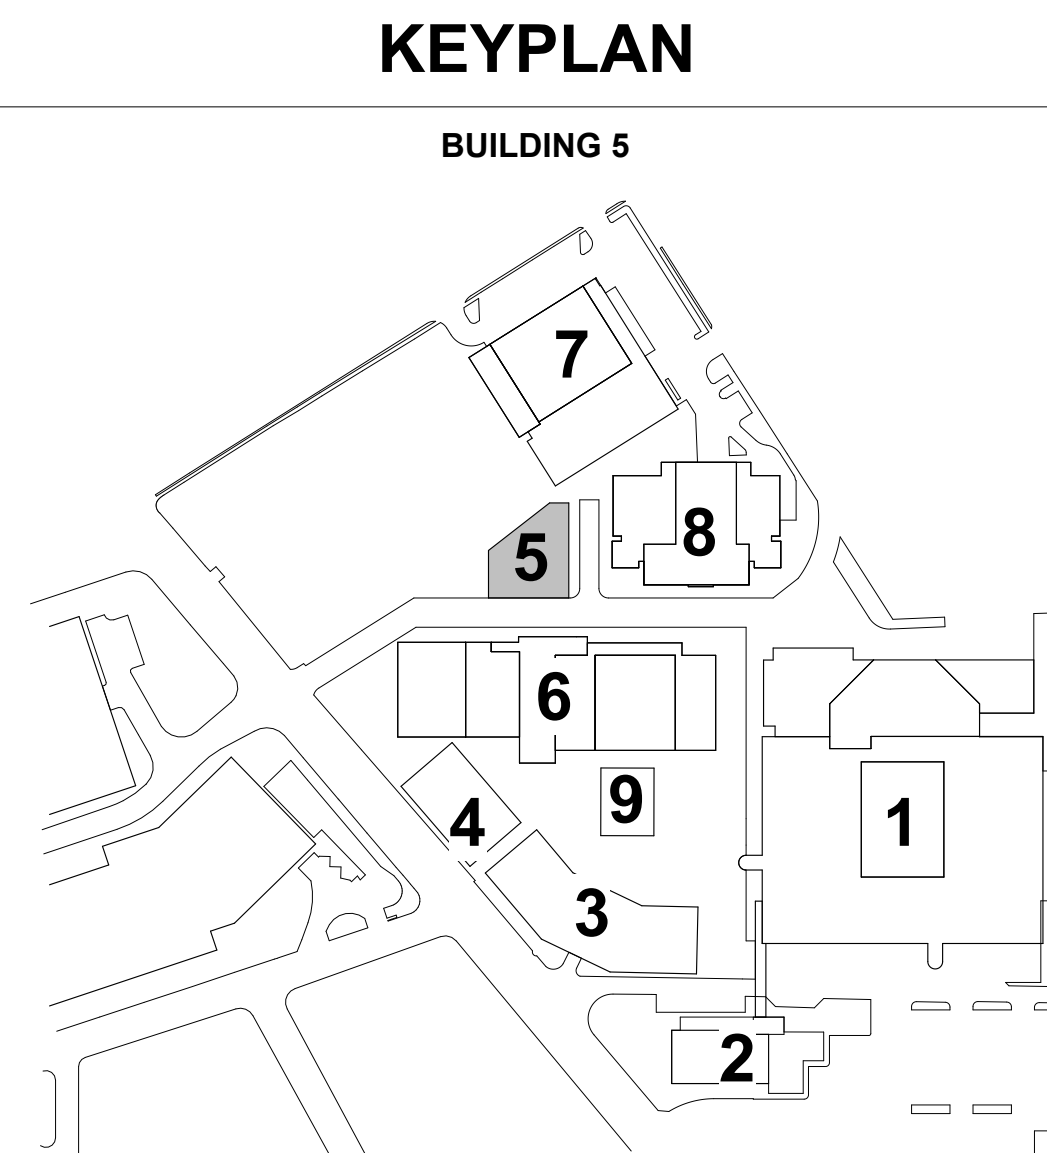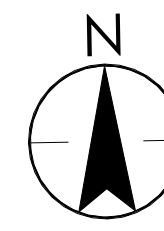

KEYPLAN

PERMIT SET

Sheet Name
ROOF PLAN & ENLARGED PLAN - BLACK BOX

Drawing No.
A-206

Permit/Seal

06.24.24

Consultant




Client/Project
SAN ANTONIO INDEPENDENT SCHOOL DISTRICT

BOND 2020 FOX TECH CAMPUS ADDITIONS & RENOVATIONS

637 N. MAIN AVE.
SAN ANTONIO, TEXAS 78205

DATE		CONSTRUCTION DOCUMENTS	
06/24/24		PROJECT NO. A202108.00	
DRAWN BY RL/AA		CHECKED BY ALTA	
ISSUE / REVISIONS			DATE
#	DESCRIPTION		
1	PERMIT SET		08/23/24
1	ADDENDA #02		07/26/24

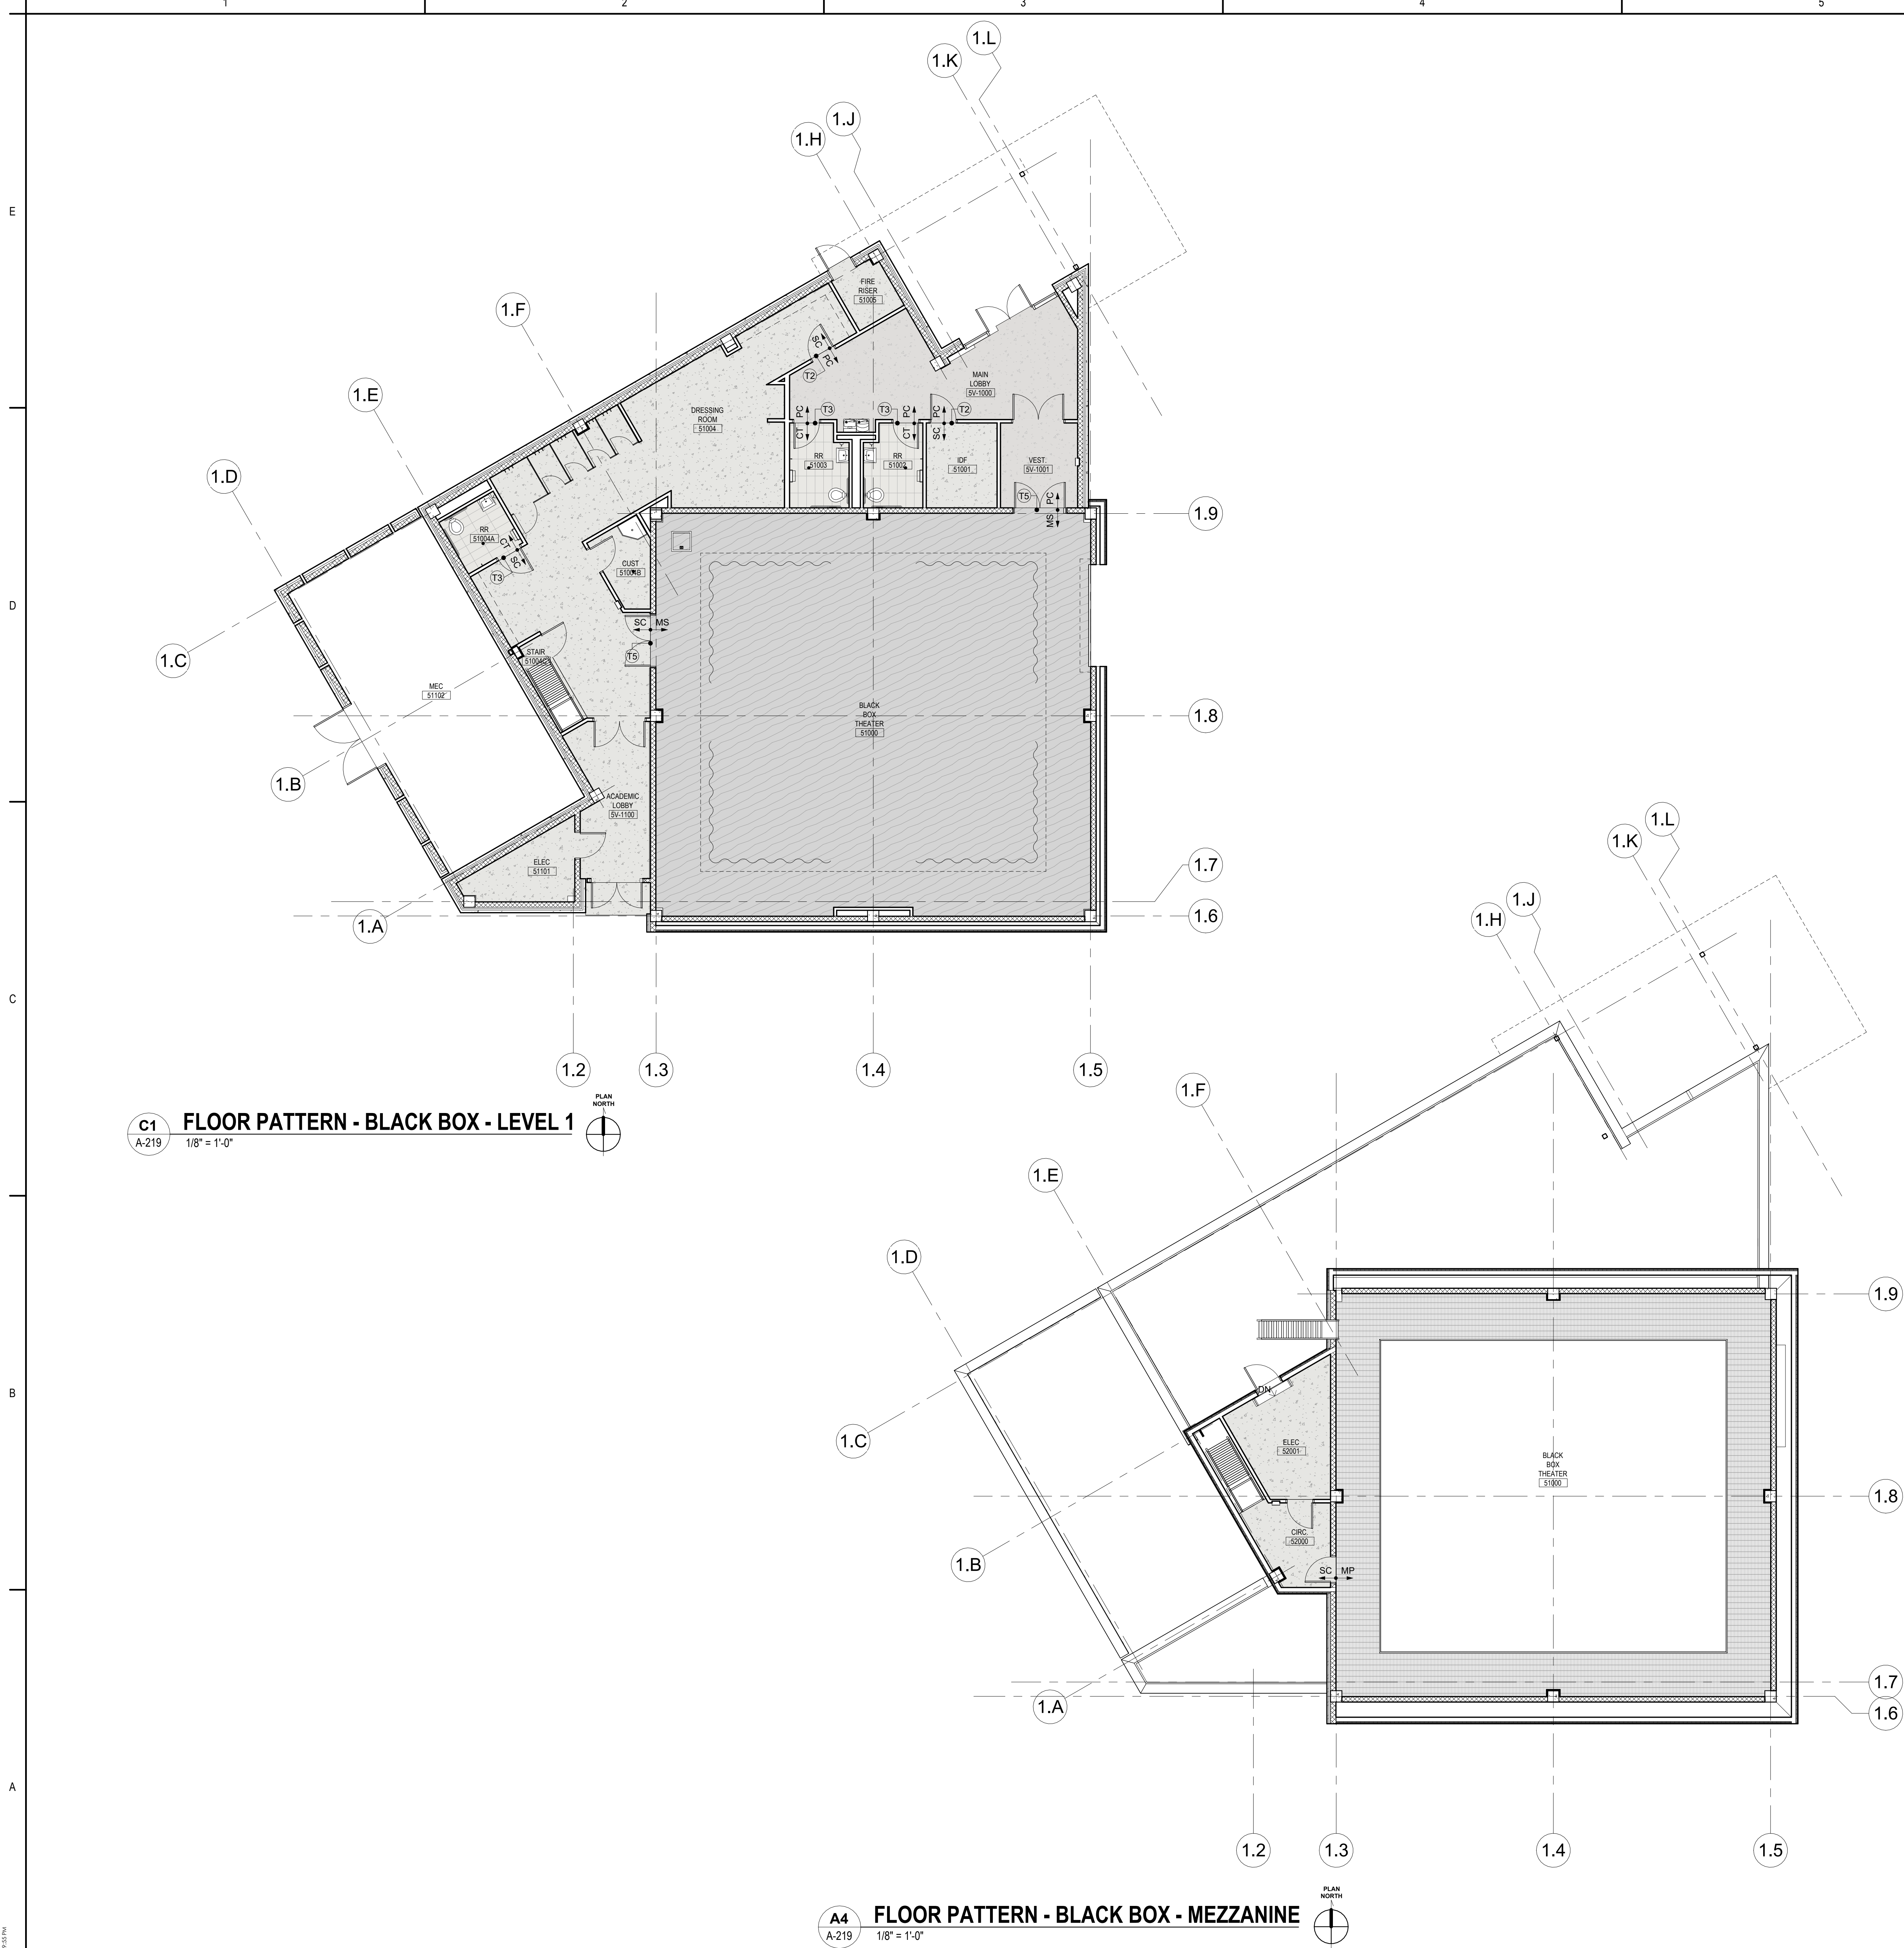

C1 FLOOR PATTERN - BLACK BOX - LEVEL 1
A-219 1/8" = 1'-0"

A4 FLOOR PATTERN - BLACK BOX - MEZZANINE
A-219 1/8" = 1'-0"

FLOOR FINISH LEGEND


CT-1 CERAMIC TILE 12" X 24"	CP-1 CARPET TILE - AUDITORIUM 24" X 24"
LVT-1 LUXURY VINYL TILE 12" X 48"	CP-2 CARPET TILE - PERFORMING ARTS 24" X 24"
LVT-2 LUXURY VINYL TILE 12" X 48"	PC-1 POLISHED CONCRETE - LOBBY CLASS B LEVEL 3
LVT-3 LUXURY VINYL TILE 12" X 48"	STC-1 STAINED CONCRETE COLOR
LVT-4 LUXURY VINYL TILE 12" X 48"	SC-1 SEALED CONCRETE
LVT-5 LUXURY VINYL TILE 12" X 48"	RWAF-1 RESILIENT WOOD ATHLETIC FLOOR
LVT-6 LUXURY VINYL TILE 12" X 48"	MS-1 MASONITE FLOOR
LVT-7 LUXURY VINYL TILE 12" X 48"	WF-1 WOOD FLOOR (MARLEY FLOOR)
TZ-1 EPOXY TERRAZZO	RT-1 RUBBER FLOOR
EPX-1 EPOXY FLOOR	MP-1 METAL GRID - CATWALK REFER TO STRUCTURAL

GENERAL NOTES

- REFER TO SHEET A-401 FOR ROOM FINISH SCHEDULE.
- REFER TO SHEET A-825 FOR FLOOR TRNASITION DETAILS.
- ALL INTERIOR DIMENSIONS ARE TO FINISH FACE U.N.O.

KEYPLAN

BUILDING 5

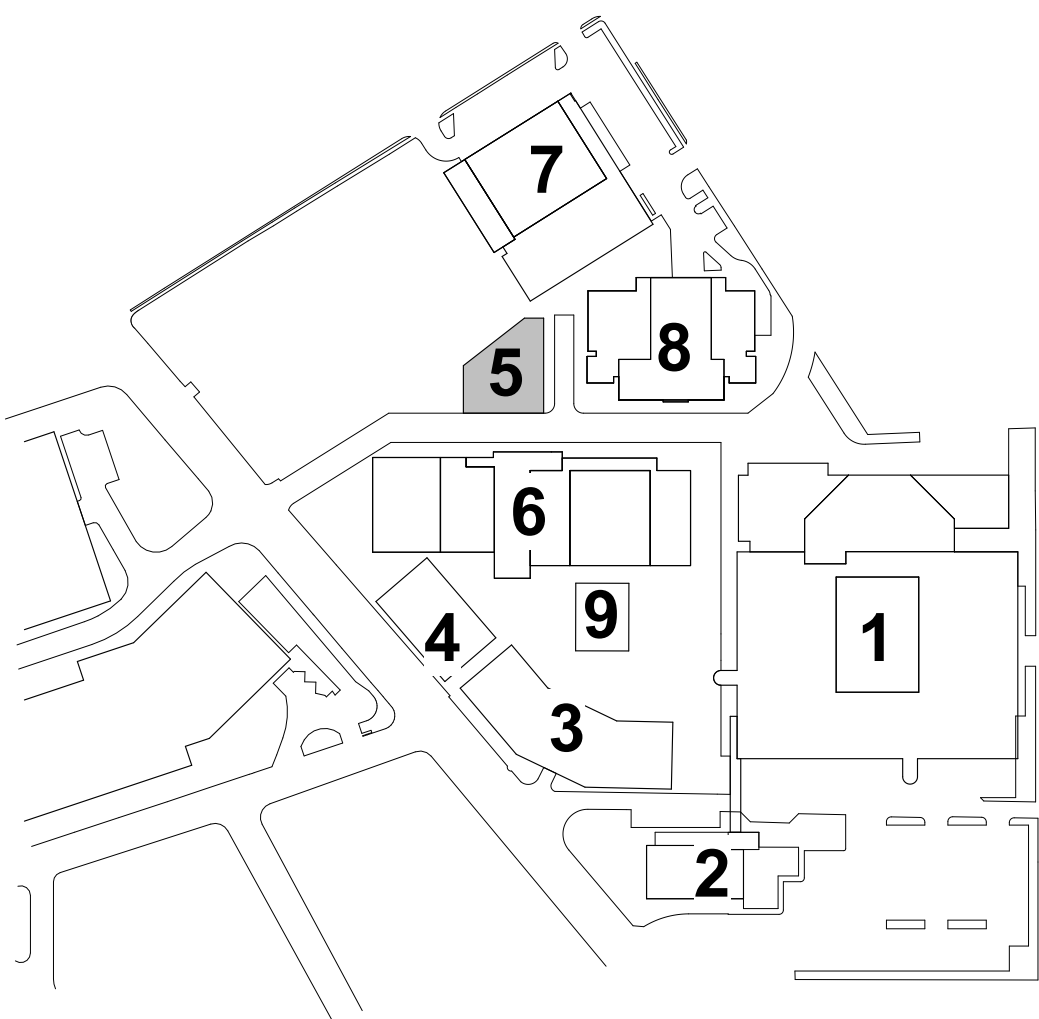

Client/Project

SAN ANTONIO INDEPENDENT SCHOOL DISTRICT

**BOND 2020 FOX TECH CAMPUS
ADDITIONS & RENOVATIONS**

637 N. MAIN AVE.
SAN ANTONIO, TEXAS 78205

DATE

06/24/24

**CONSTRUCTION
DOCUMENTS**

PROJECT NO.

A202108.00

DRAWN BY

LA

CHECKED BY

LD

ISSUE / REVISIONS

#	DESCRIPTION	DATE
1	PERMIT SET	08/23/24

PERMIT SET

Sheet Name
**PATTERN FLOOR PLAN -
BLACK BOX BLDG -
LEVELS 1 & 2**


Drawing No.
A-219

Permit/Seal




06.24.24

Consultant

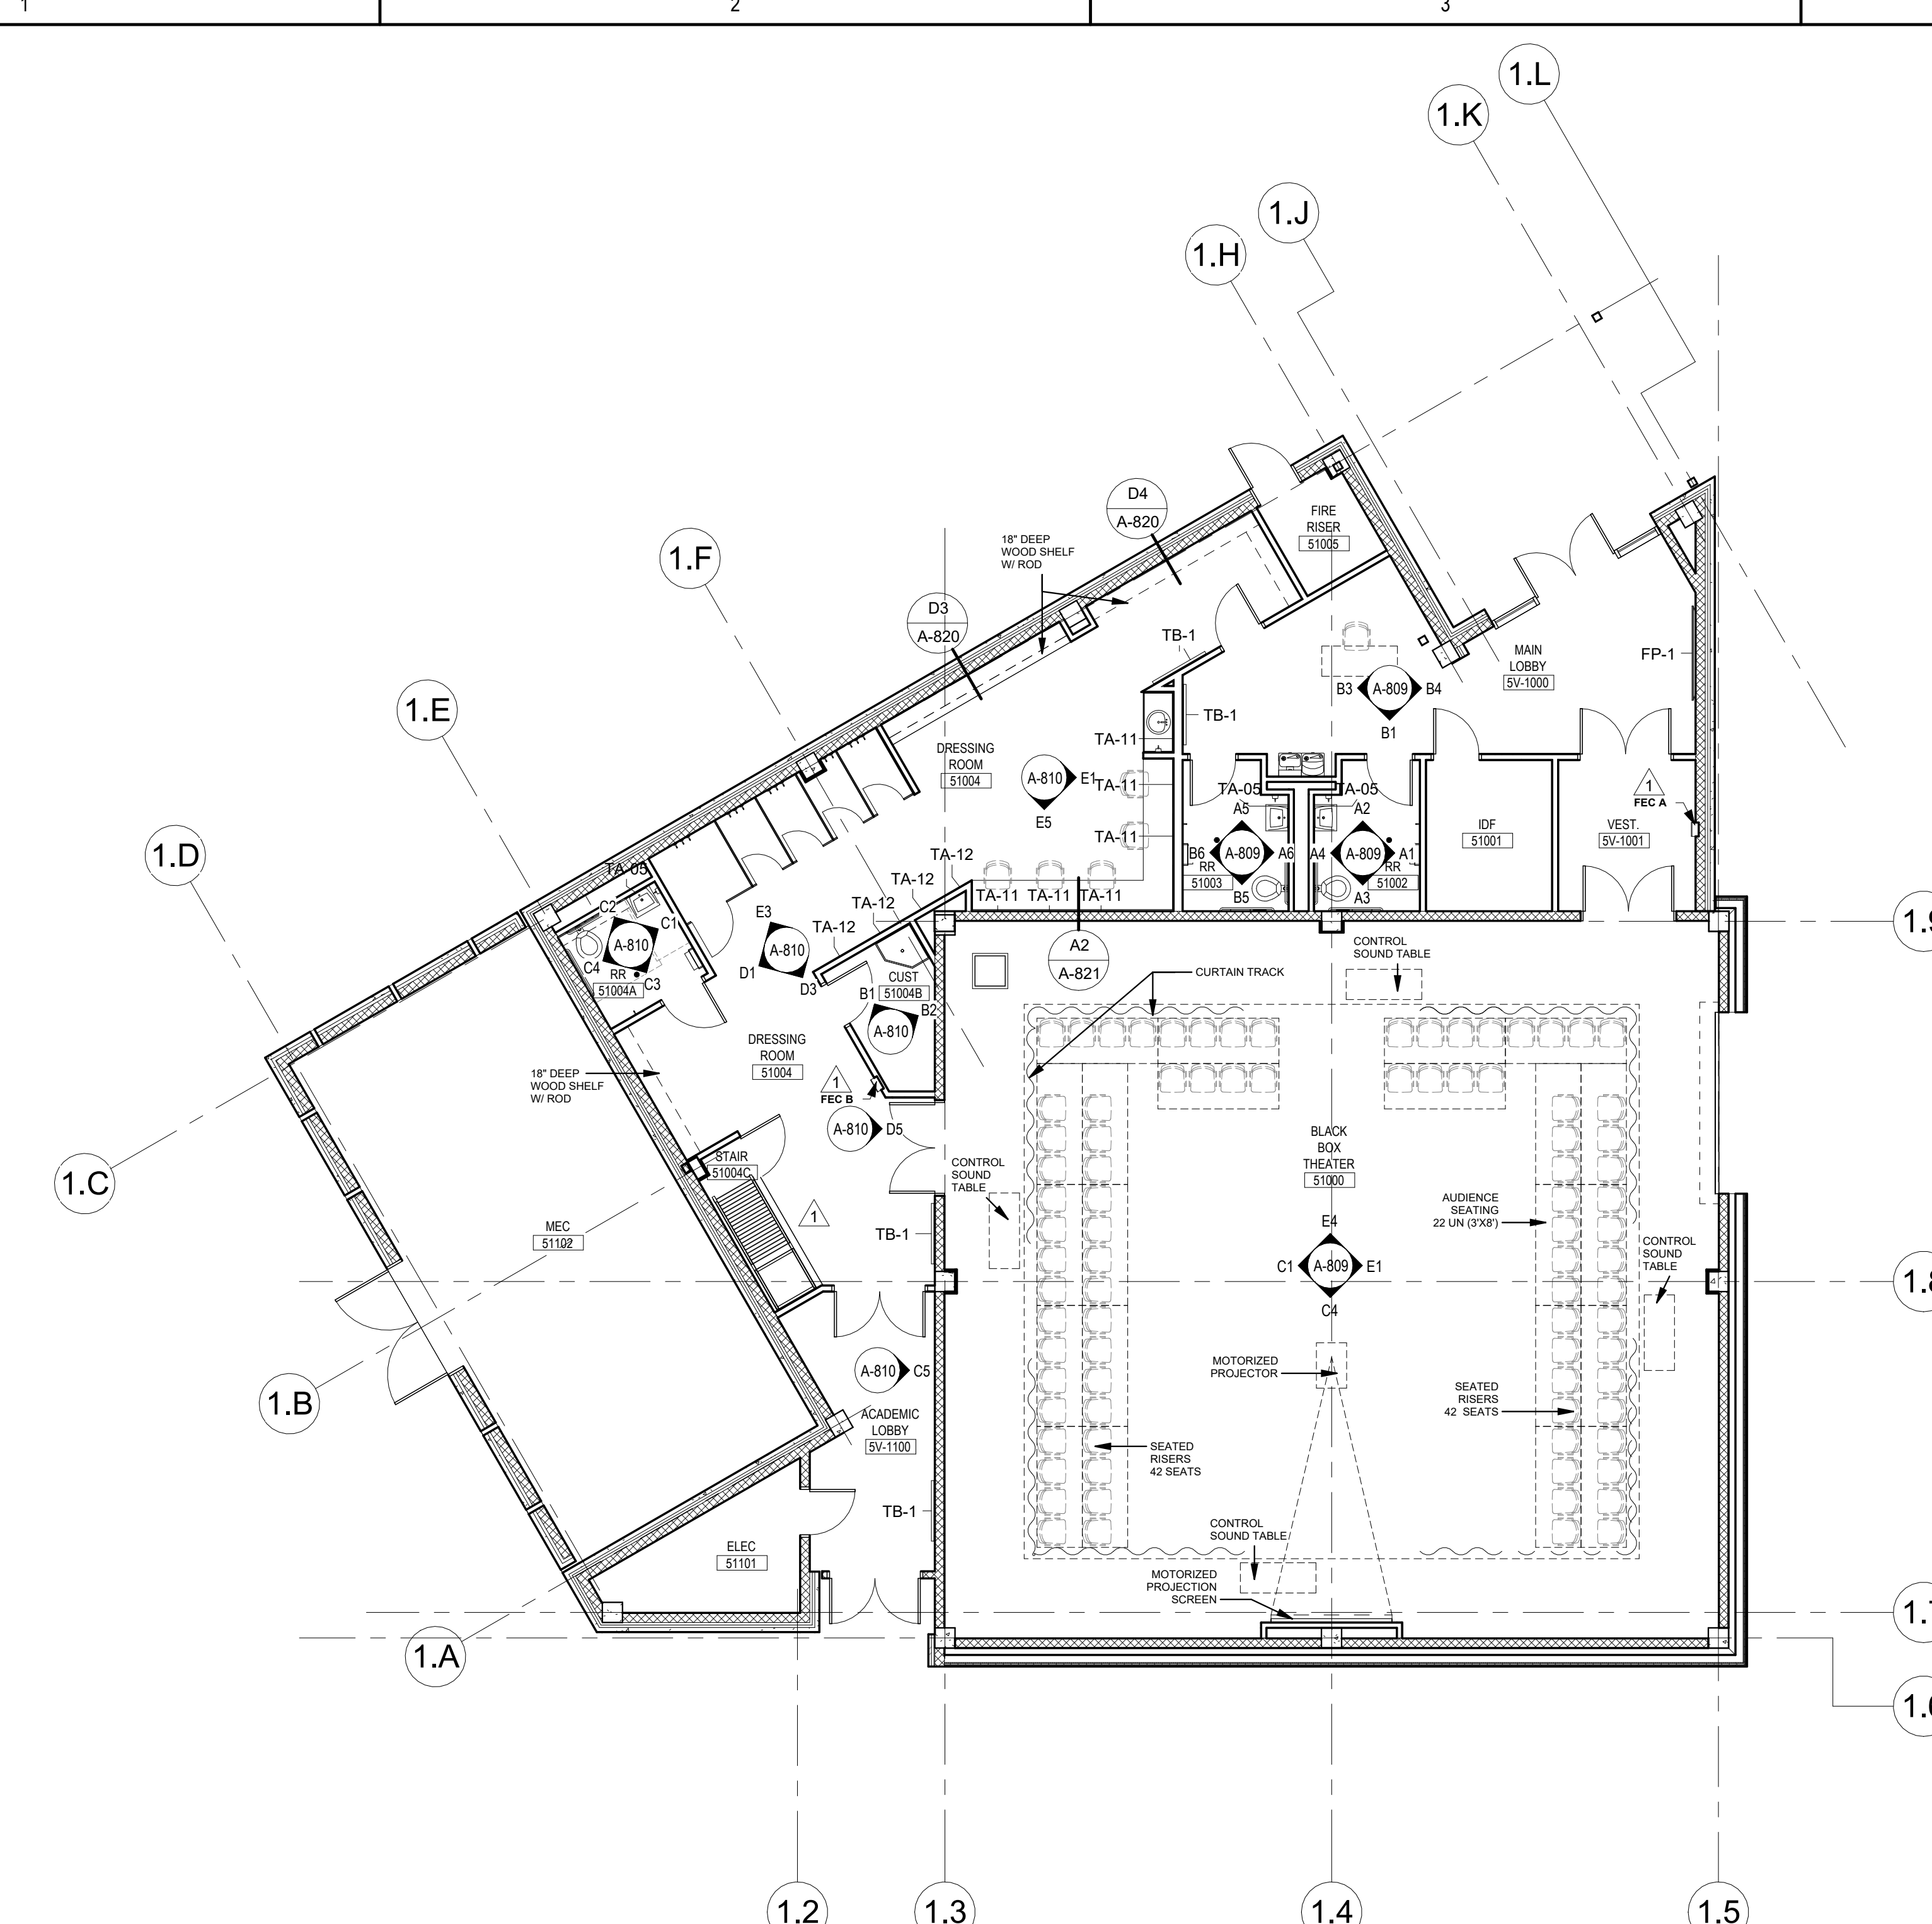


C1
A-225
F.F.E. FLOOR PLAN - BLACK BOX - LEVEL 1
1/8" = 1'-0"

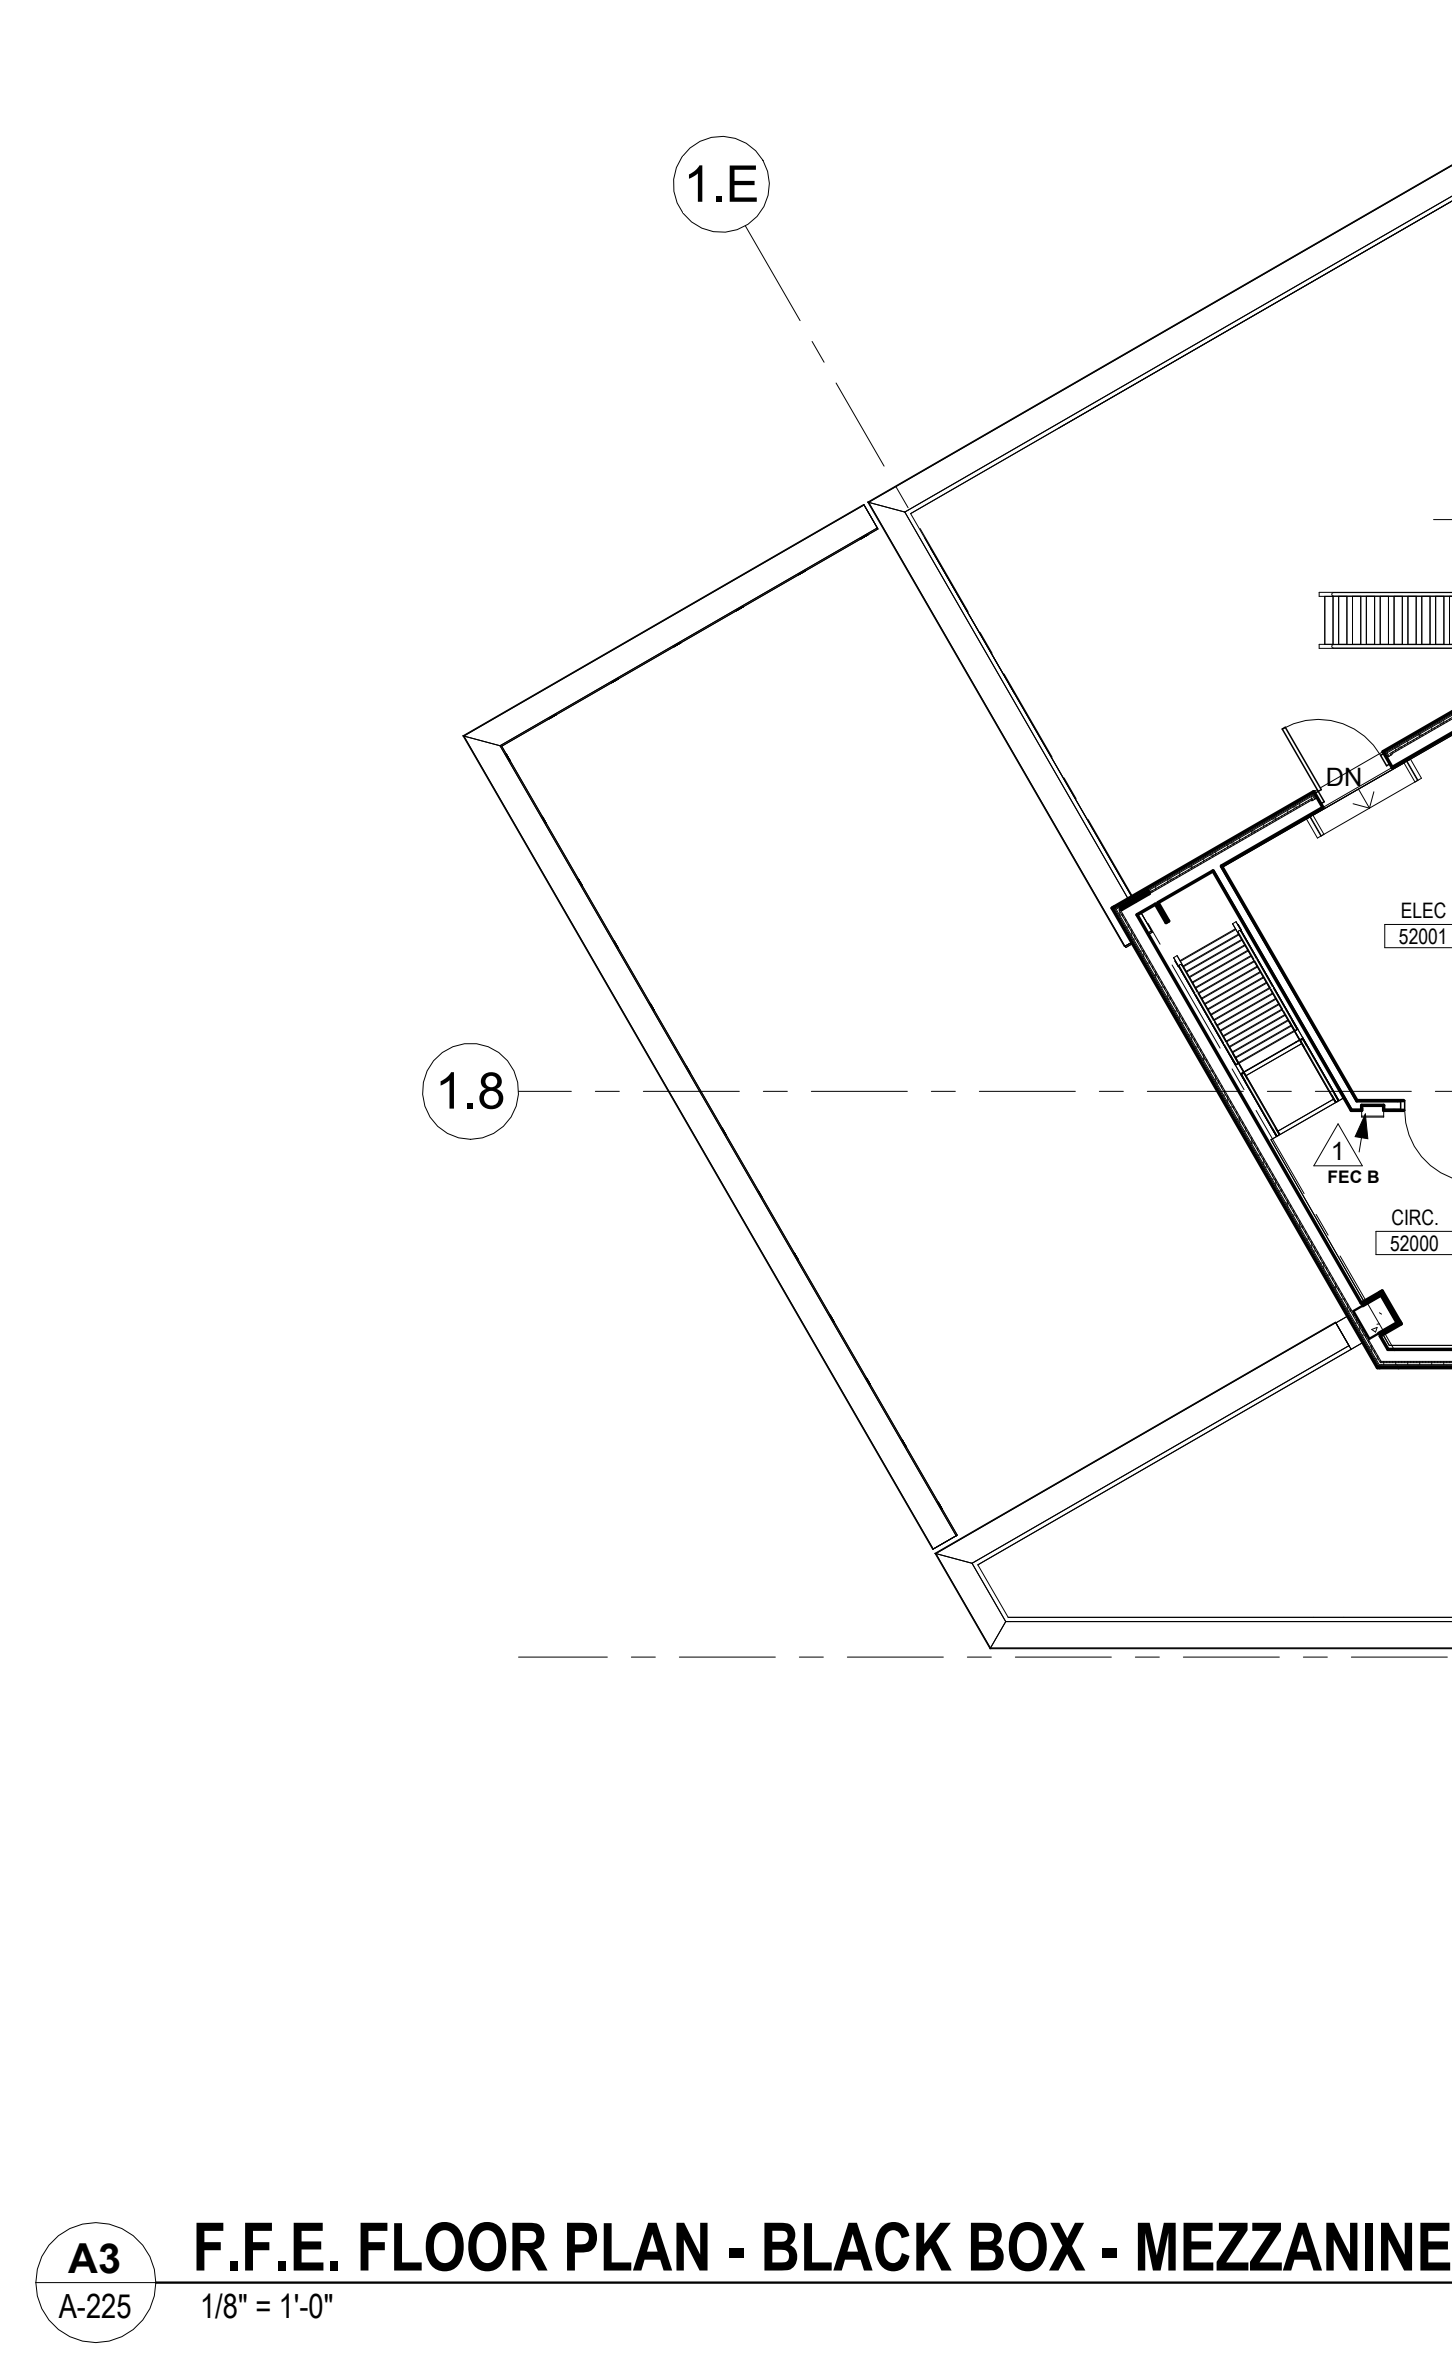

A3
A-225
F.F.E. FLOOR PLAN - BLACK BOX - MEZZANINE
1/8" = 1'-0"

ROOM FURNITURE, FIXTURES & EQUIPMENT SCHEDULE - BLACK BOX					
LEVEL	ROOM N.	ROOM NAME	EQUIPMENT	QTY	PROV./INTAL. BY
L1	5V-1000	MAIN LOBBY	TV SCREEN	1	OPCI
			TV MOUNTING BRACKETS	1	OPCI
			TABLE	1	NIC
			CHAIR	1	NIC
L1	51002 51003 51004A	RR RR RR	SINK AND ACCESSORIES	1 SET	OPCI
			MIRROR	1	OPCI
			TOILET ROOM FIXTURES	1 SET	OPCI
			PAPER TOWEL DISPENSER	1	OPCI
			HANDICAP ACCESSORIES/ GRAB BARS	1	OPCI
			COAT HOOK	1	OPCI
L1	51004B	CUST	SINK MOP	1	OPCI
L1	51004	DRESSING HS	TACKBOARD	2	OPCI
			MIRROR	6	OPCI
			MIRROR	4	OPCI
			SINK AND ACCESSORIES	1 SET	OPCI
			COAT HOOK	15	OPCI
			CLOSET SHELF WITH ROD	3 SETS	OPCI
L1	5V-1100	ACADEMIC LOBBY	TACKBOARD	1	OPCI
L1	51000	BLACK BOX CATWALK	BLACK VELVET CURTAIN	1	OPCI
			PORTABLE SMARTBOARD	1	OPCI
			MOTORIZED PROJECTION SCREEN	1	OPCI
			MOTORIZED PROJECTOR	1	OPCI
			CHAIR	2	NIC
			CONTROL SOUND SYSTEM	2	OPCI
L2	52000	CIRC	B.B. SEATING PLATFORM (22 UN. 3X6)	SET	NIC
L2	52001	AV RACK ROOM	TACKBOARD	1	OPCI
			METAL SHELF	11	NIC

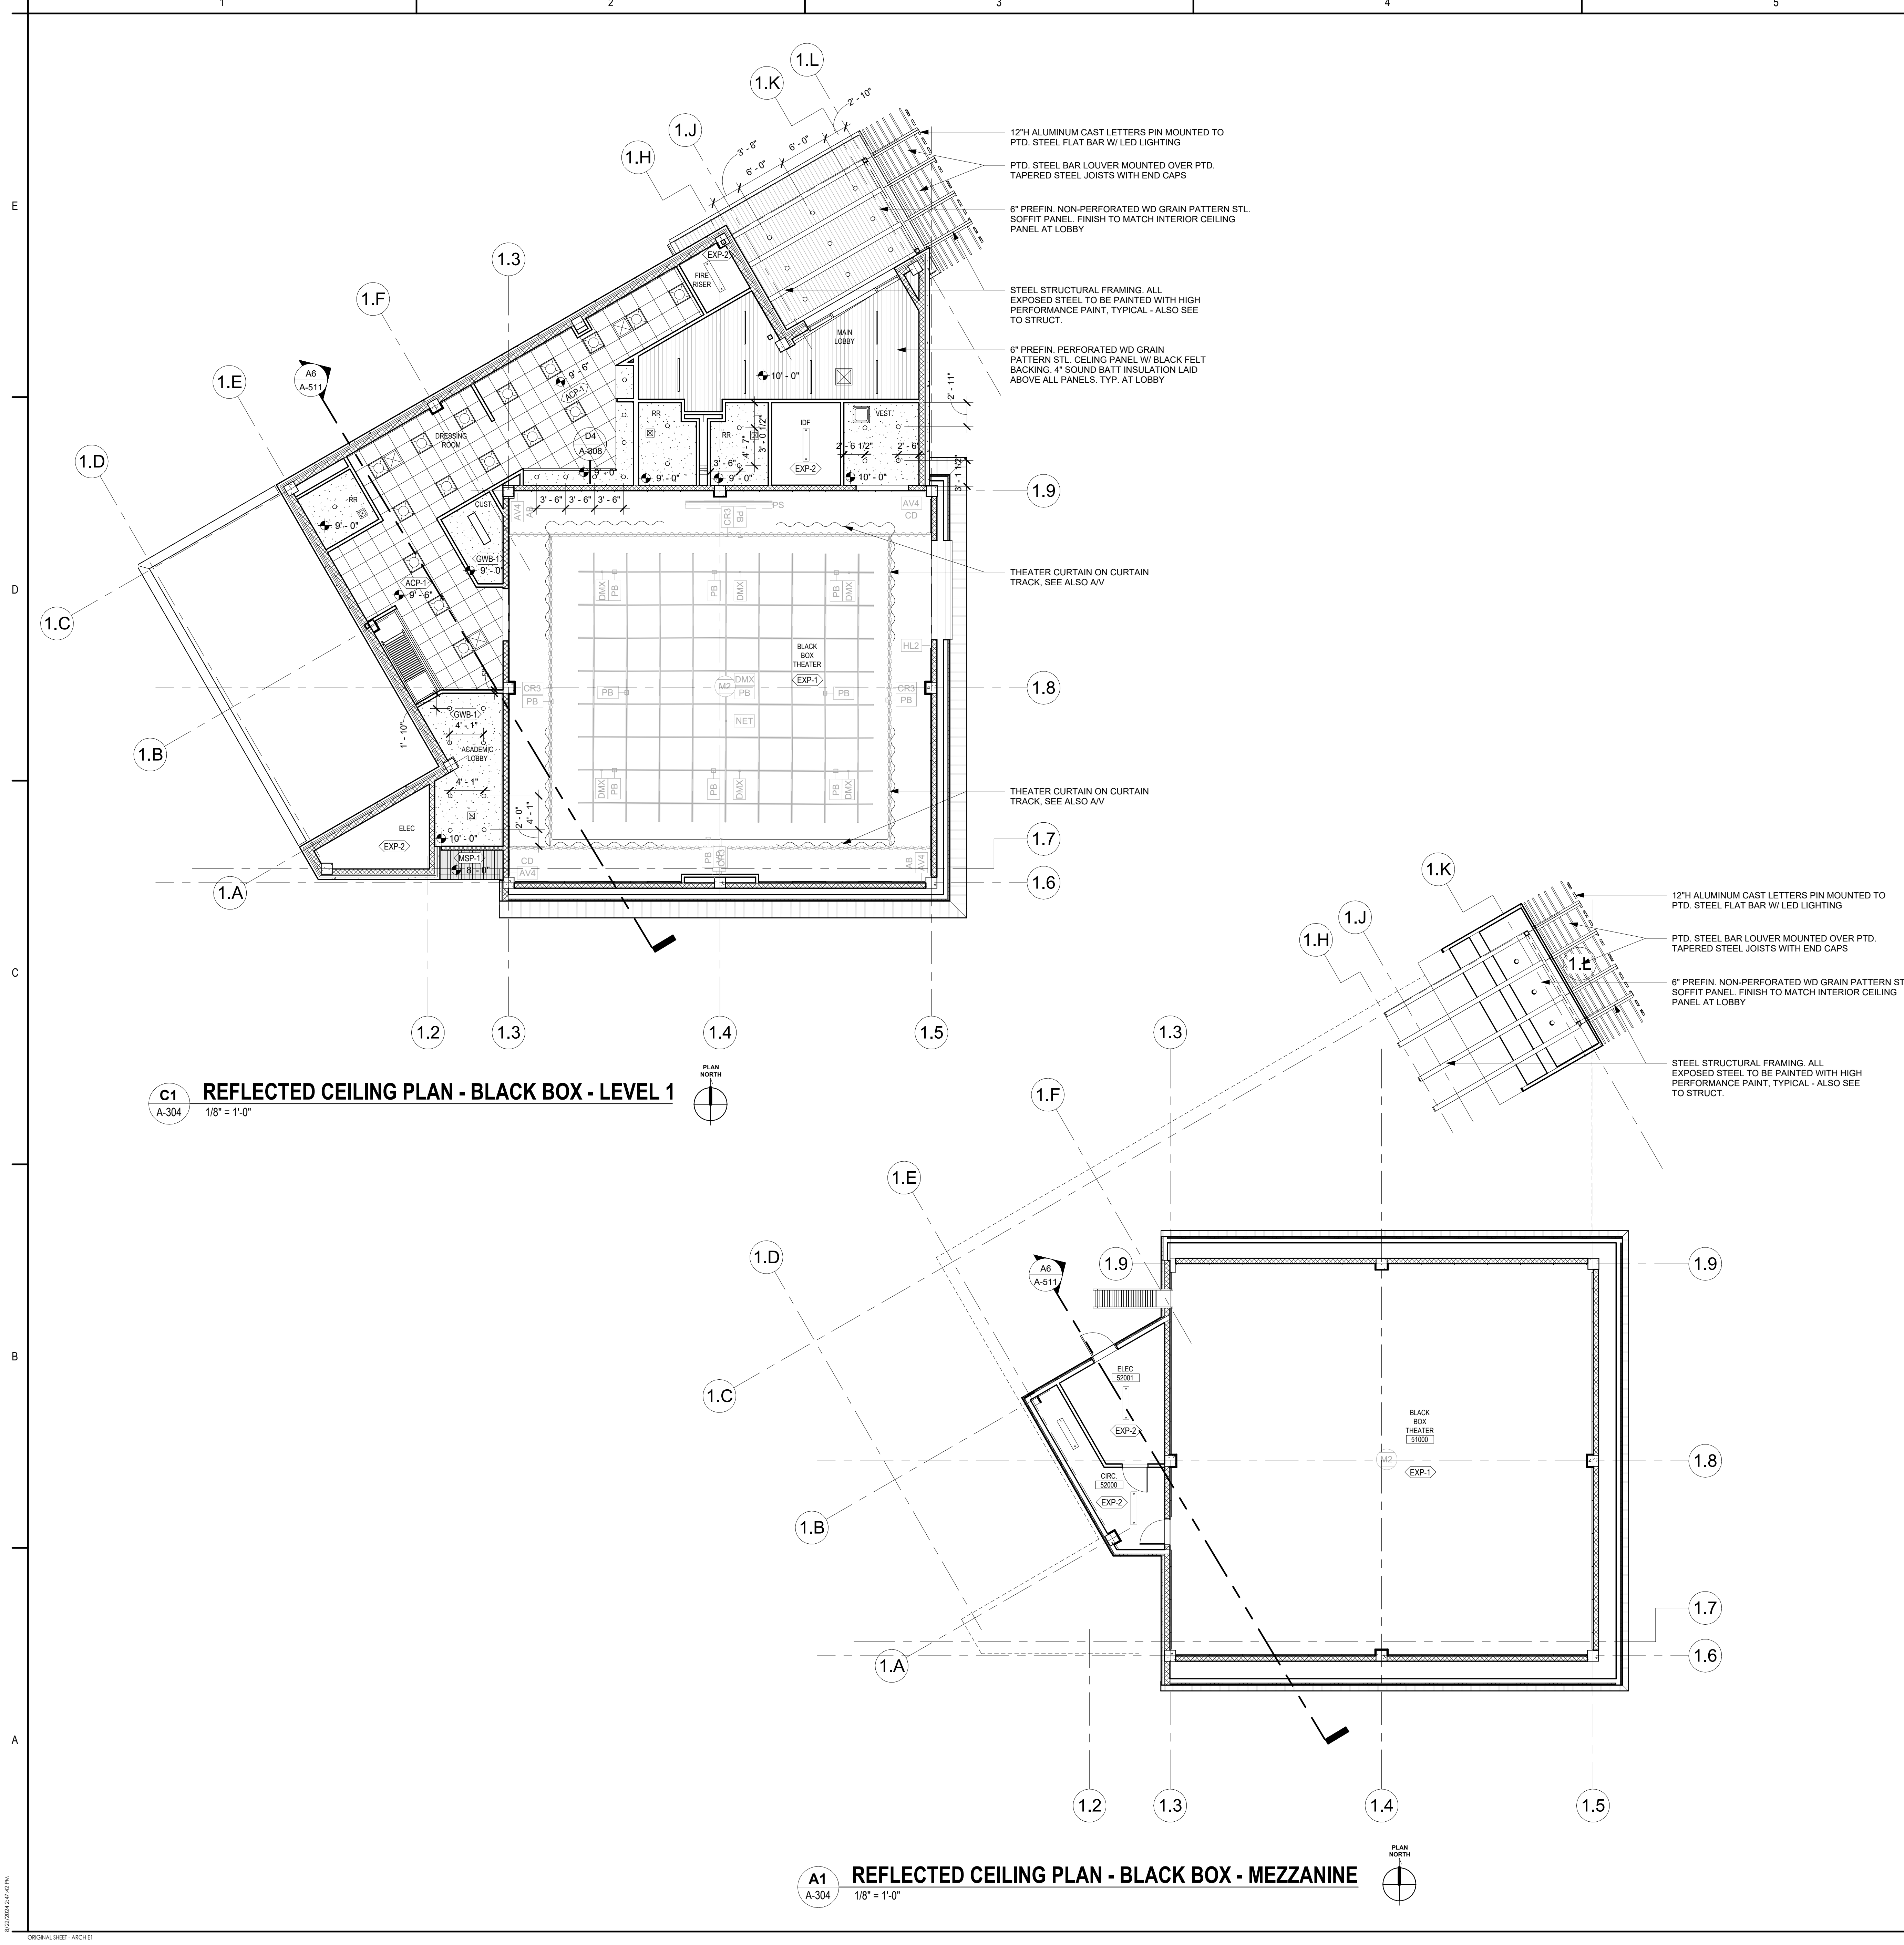

RCP GENERAL NOTES

- SEE FINISH SCHEDULE FOR CEILING TYPES U.N.O.
- REFER TO LIFE SAFETY PLANS FOR RATED WALLS.
- CEILING GRIDS CENTERED IN ROOM U.N.O.
- ALL FIXTURES/DEVICES MAY NOT BE INDICATED COORDINATE WITH MEP, AV, & TELECOM DRAWINGS, AND PROVIDE ADDITIONAL FIXTURES, DEVICES AS REQUIRED.
- REFER TO MECHANICAL FOR AIR DEVICES TYPICAL.
- REFER TO ELECTRICAL FOR CEILING SPEAKER PLACEMENT.
- REFER TO ELECTRICAL FOR LIGHTING AND POWER.
- LIGHTING LAYOUT AT MECHANICAL ROOMS TO BE COORDINATED WITH M.E.P.
- ALL CEILINGS TO BE 9'-0" A.F.F. U.N.O. - COORDINATE ANY DISCREPANCIES WITH CEILING HEIGHT AND MEP WORK WITH ARCHITECT BEFORE INSTALLATION OF ANY OVERHEAD ITEMS.
- PROVIDE AND COORDINATE ACCESS DOORS WITH MEP. FINAL LOCATION TO BE VERIFIED WITH ARCHITECT.

NON RENOVATED AREA

EXISTING TO REMAIN


NEW WORK AREA

NEW WORK

RCP LEGEND

OPEN TO STRUCTURE (ALL PAINTED)	24" X 24" LAY-IN CEILING
GYPSUM BOARD CEILING	24" X 96" LAY-IN CEILING
ALUM. METALWORKS SOFFIT W/ WOOD APPEARANCE / UNPERFORABLE	KYNAR FINISHED GALVALUME STL SOFFIT
ALUM. METALWORKS SOFFIT W/ WOOD APPEARANCE / MICROPERFORATED	PLASTIC LAMINATE CEILING
PENDANT LIGHT FIXTURE (36" DIA APPROX.)	PENDANT LIGHT FIXTURE (60" DIA APPROX.)
RECESSED DOWN LIGHT FIXTURE	RECESSED DOWN LIGHT FIXTURE - DIMMING
RECESSED LED FIXTURE 24" X 24"	RECESSED LED FIXTURE 24" X 48"
RECESSED ROUND ARCHITECTURAL FIXTURE 48"X48"	RECESSED LED STRIP CORNER FIXTURE (REF. TO RCP FOR RUN LENGTHS) PROVIDE FINISH TRIM TO MATCH HOUSING WHERE REQUIRED.
RECESSED LINEAR LED FIXTURE 2"W (REF. TO RCP FOR RUN LENGTHS) PROVIDE FINISH TRIM TO MATCH HOUSING WHERE REQUIRED.	WALL MOUNTED LED SCONCE FIXTURE (EXTERIOR)
WALL MOUNTED LINEAR FIXTURE - RESTROOM (REF. TO RCP FOR RUN LENGTHS) PROVIDE FINISH TRIM TO MATCH HOUSING WHERE REQUIRED.	PENDANT UTILITY FIXTURE
RECESSED 12"X48" LINEAR FIXTURE	RETURN/EXHAUST DIFFUSER 24" X 24"
LINEAR SUPPLY DIFFUSER	PARTITIONS TO STRUCTURE
SUPPLY DIFFUSER 24" X 24"	CEILING MOUNTED PROJECTOR MOUNT, OFC1
CEILING ACCESS PANEL	FINAL LOCATION OF MOUNT TO BE COORDINATED WITH OWNER.
RECESSED DROP DOWN PROJECTION SCREEN	

KEYNOTE LEGEND

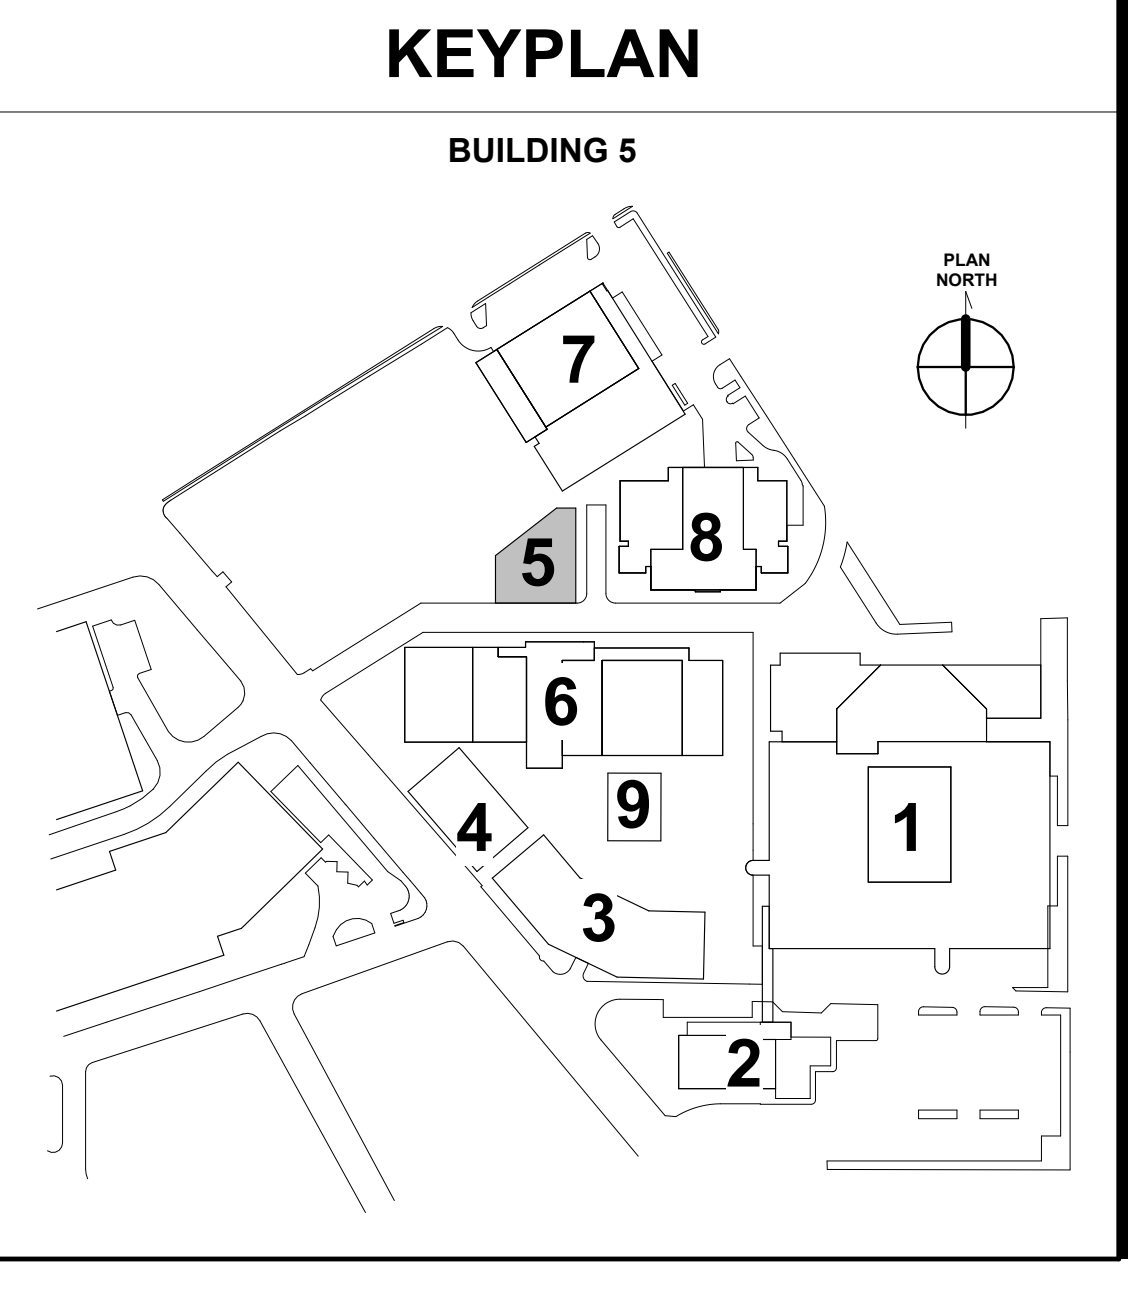

Permit/Seal

06.24.24

Consultant

Client/Project

SAN ANTONIO INDEPENDENT SCHOOL DISTRICT

BOND 2020 FOX TECH CAMPUS ADDITIONS & RENOVATIONS

637 N. MAIN AVE. SAN ANTONIO, TEXAS 78205

DATE **06/24/24** CONSTRUCTION DOCUMENTS

PROJECT NO. **A202108.00** DRAWN BY **RL** CHECKED BY **RH**

ISSUE / REVISIONS

#	DESCRIPTION	DATE
1	PERMIT SET	08/23/24


PERMIT SET

Sheet Name


REFLECTED CEILING PLAN - BLACK BOX - LEVELS 1 & 2

Drawing No.


A-304

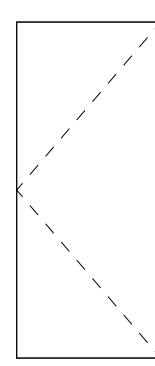


F
FLUSH

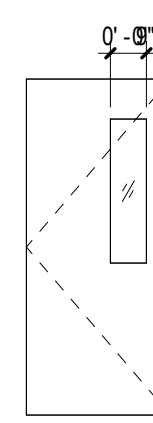


NL
NARROW LITE

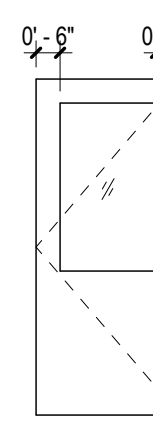

HL
HALF LITE

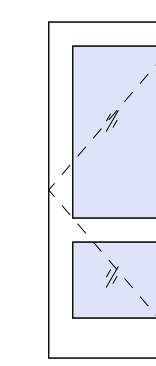


FLD
FULL GLASS
DIVIDED LITE

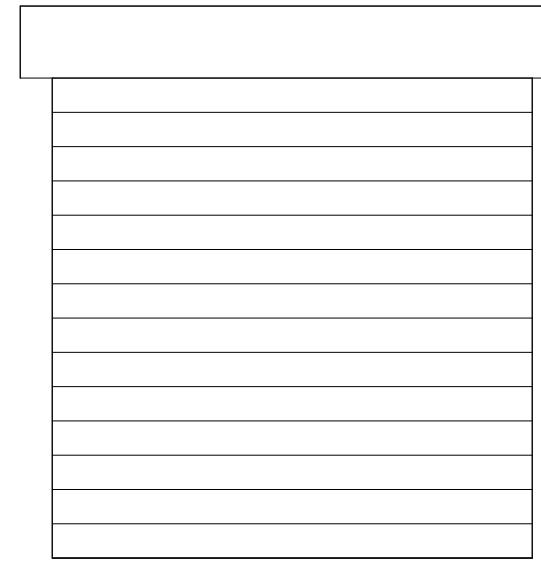

OH
OVERHEAD STEEL
COILING GRILLE DOOR

DOOR PANEL TYPES

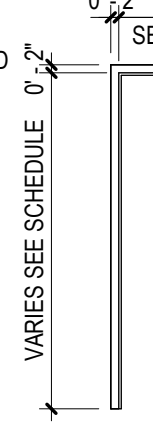

AT STUD
VARIES SEE SCHEDULE








AT MASONRY
VARIES SEE SCHEDULE

DOOR FRAME TYPES

DOOR SCHEDULE - BLACK BOX																			
No.	Room Name	Rm. No.	Clear Dim.		No. of Panels	Panel Widths		Thickness	Type	Mat'l	Mat'l	Frame			Opening		Comments		
			Width	Height		Panel 1 Width	Panel 2 Width					Finish	Details			Fire Label		Glaz	
													Head	Jamb	Sill				
LEVEL 1																			
5V-1000	MAIN LOBBY	5V-1000	6'-0"	8'-0"	2	3'-0"	3'-0"	1 3/4"	FLD		ALUM	ALUM	E1 / A-410	D1 / A-410	-	-	GL-4	CARD KEY ACCESS - REFER TO SECURITV DWGS	
5V-1001	VEST	5V-1001	6'-0"	7'-0"	2	3'-0"	3'-0"	1 3/4"	NL	S.C. WOOD	HM	PT	D1 / A-409	D1 / A-409	A4 / A825	-	-	SFTY	
5V-1100	ACADEMIC LOBBY	5V-1100	6'-0"	7'-0"	2	3'-0"	3'-0"	1 3/4"	F	HM	HM	PT	E4 / A-411	D4 / A-411	-	-	-	CARD KEY ACCESS - REFER TO SECURITV DWGS	
51000	BLACK BOX THEATER	51000	6'-0"	7'-0"	2	3'-0"	3'-0"	1 3/4"	F	S.C. WOOD	HM	PT	E1 / A-409	E1 / A-409	A4 / A825	-	-		
51000.1	BLACK BOX THEATER	51000	6'-0"	7'-0"	2	3'-0"	3'-0"	1 3/4"	F	S.C. WOOD	HM	PT	E1 / A-409	E1 / A-409	A4 / A825	-	-		
51000.OH	BLACK BOX THEATER	51000	12'-0"	10'-0"	-	-	-	2"	STL PT	STL		PT	E1 / A-411	E2 / A-411	A4 / A-825	-	-	OVERHEAD DOOR	
51001	IDF	51001	3'-0"	7'-0"	1	3'-0"	0'-0"	1 3/4"	F	S.C. WOOD	HM	PT	D1 / A-409	D1 / A-409	A4 / A825	-	-		
51002	RR	51002	3'-0"	7'-0"	1	3'-0"	0'-0"	1 3/4"	F	S.C. WOOD	HM	PT	D1 / A-409	D1 / A-409	A4 / A825	-	-		
51003	RR	51003	3'-0"	7'-0"	1	3'-0"	0'-0"	1 3/4"	F	S.C. WOOD	HM	PT	D1 / A-409	D1 / A-409	A4 / A825	-	-		
51004	DRESSING ROOM	51004	6'-0"	7'-0"	2	3'-0"	3'-0"	1 3/4"	F	S.C. WOOD	HM	PT	D1 / A-409	D1 / A-409	A4 / A825	-	-		
51004.1	DRESSING ROOM	51004	3'-0"	7'-0"	1	3'-0"	0'-0"	1 3/4"	F	S.C. WOOD	HM	PT	D1 / A-409	D1 / A-409	A4 / A825	-	-		
51004A	RR	51004A	3'-0"	7'-0"	1	3'-0"	0'-0"	1 3/4"	F	S.C. WOOD	HM	PT	D1 / A-409	D1 / A-409	A4 / A825	-	-		
51004B	CUST	51004B	3'-0"	7'-0"	1	3'-0"	0'-0"	1 3/4"	F	S.C. WOOD	HM	PT	D1 / A-409	D1 / A-409	A4 / A825	-	-		
51004C	STAIR	51004C	3'-0"	7'-0"	1	3'-0"	0'-0"	1 3/4"	G							-	-	METAL MESH PARTITION, REF DETAILS A4-A6, B4 AND B6 ON SHEET A-402	
51005	FIRE RISER	51005	3'-0"	7'-0"	1	3'-0"	0'-0"	1 3/4"	F	HM	HM	PT	E5 / A-411	D5 / A-411	-	-	-		
51101	ELEC	51101	3'-0"	7'-0"	1	3'-0"	0'-0"	1 3/4"	F	S.C. WOOD	HM	PT	E1 / A-409	E1 / A-409	A4 / A825	-	-		
51102	MEC	51102	6'-0"	7'-0"	2	4'-0"	4'-0"	1 3/4"	F	HM	HM	PT	E1 / A-409	E1 / A-409	A4 / A825	-	-	MECH YARD SCREEN GATE	
MEZZANINE																			
52000	BLACK BOX THEATER	51000	3'-0"	7'-0"	1	3'-0"	0'-0"	1 3/4"	F	S.C. WOOD	HM	PT	E1 / A-409	E1 / A-409	A4 / A825	-	-		
52001	ELEC	52001	3'-0"	7'-0"	1	3'-0"	0'-0"	1 3/4"	F	S.C. WOOD	HM	PT	D1 / A-409	D1 / A-409	A4 / A825	-	-		
52001A	ELEC	52001	3'-0"	7'-0"	1	3'-0"	0'-0"	1 3/4"	F		HM	PT	E4 / A-411	D4 / A-411	-	-	-	3, 5	
Grand total: 20																			


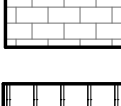


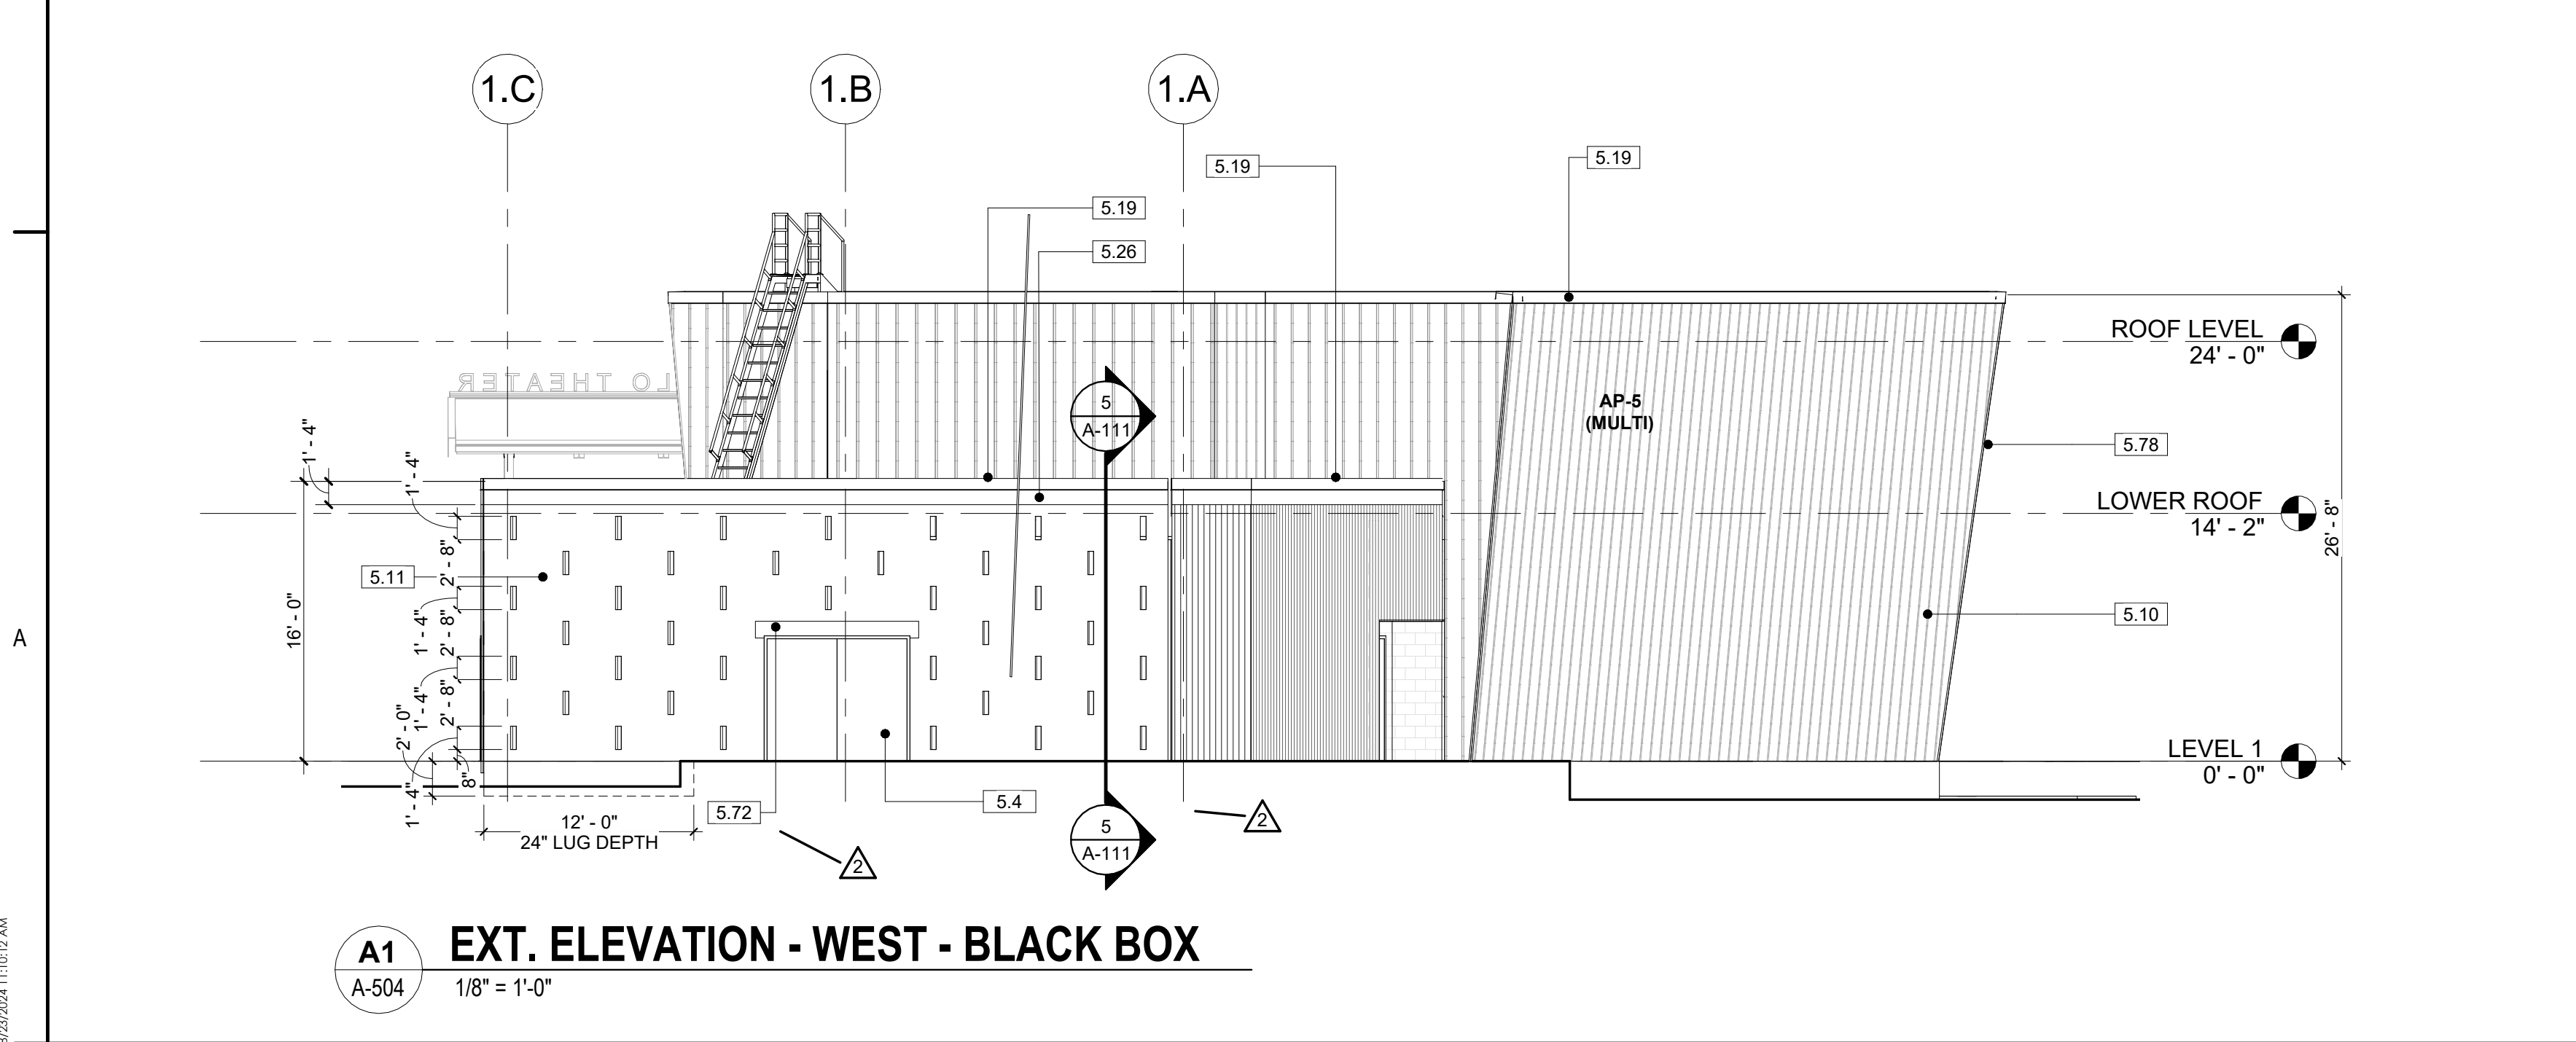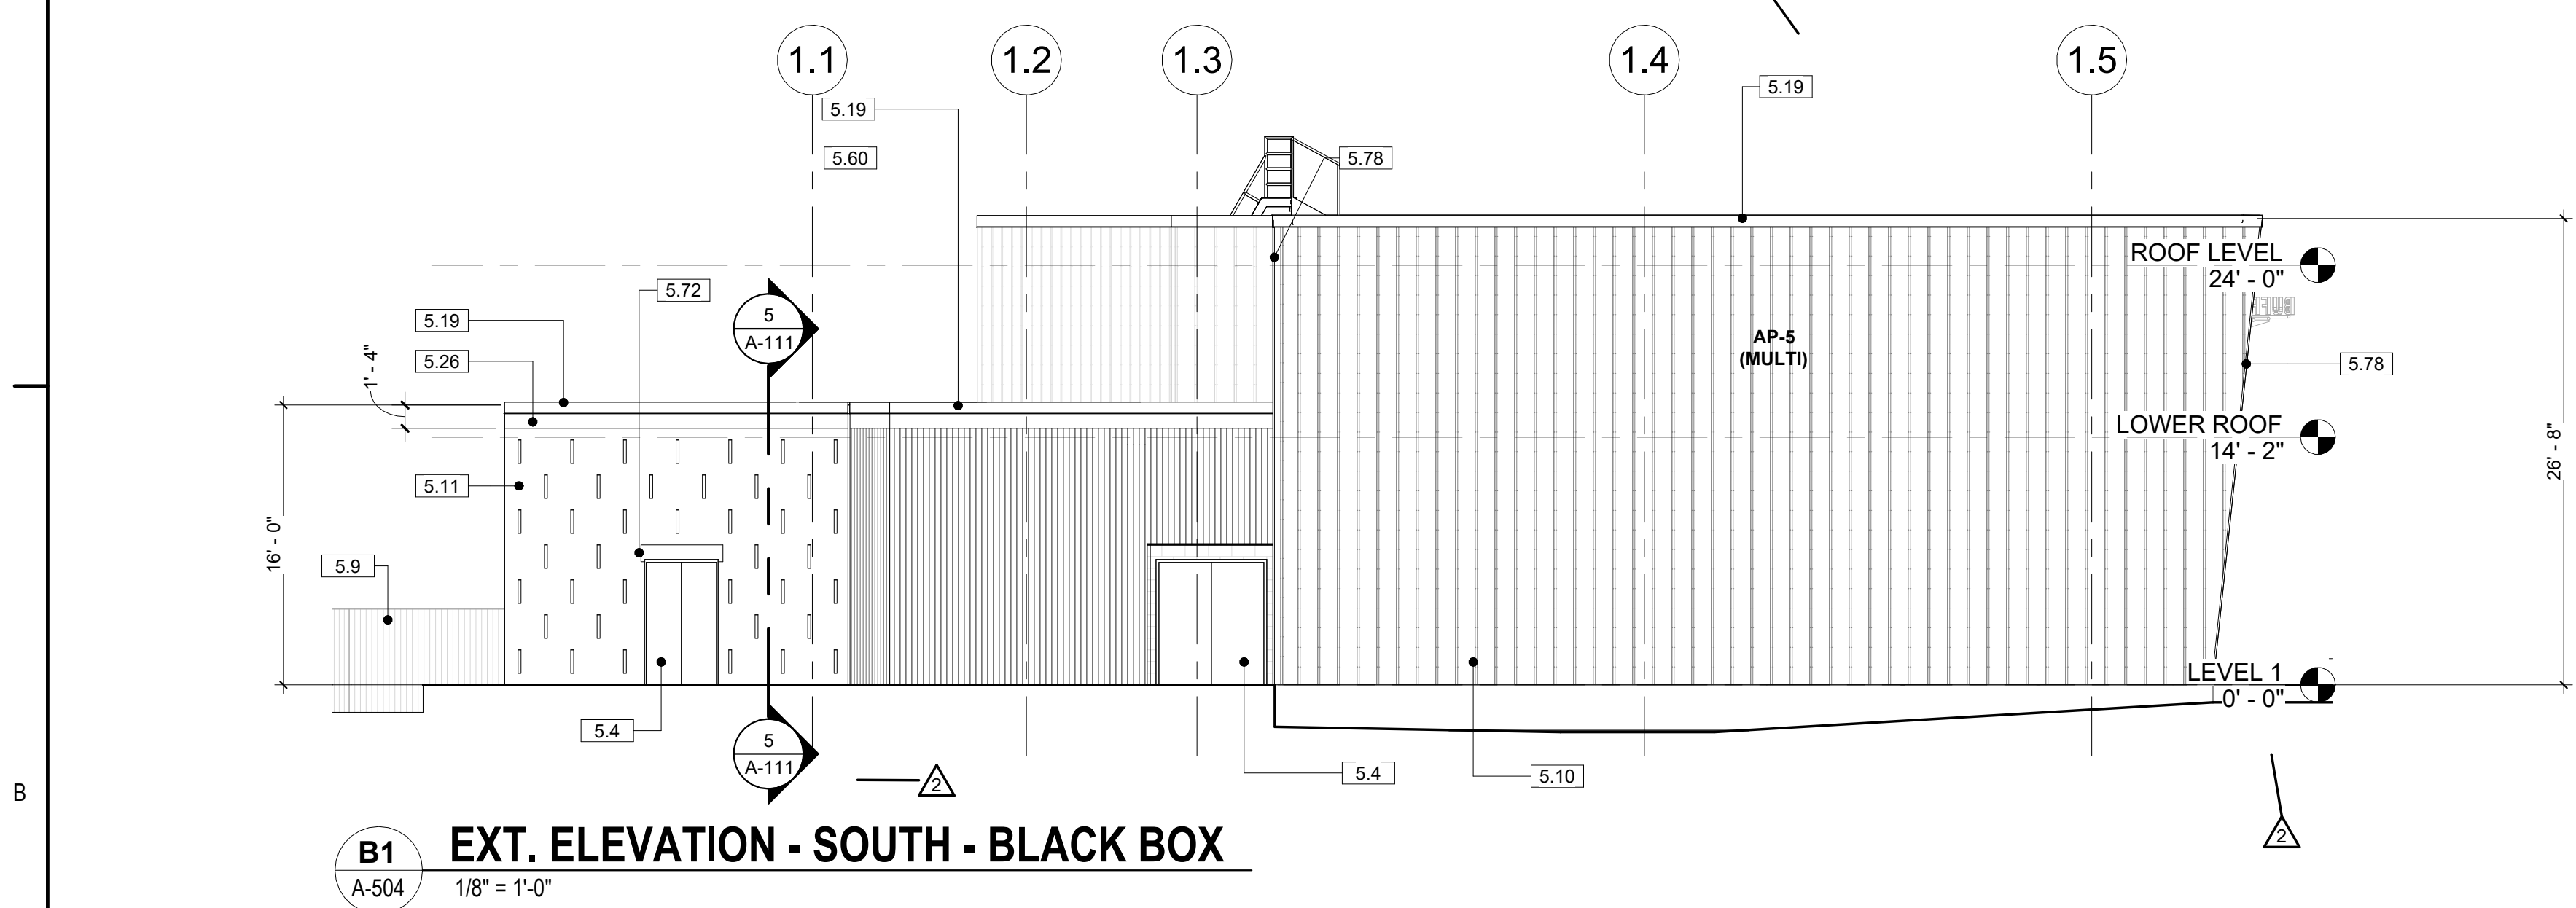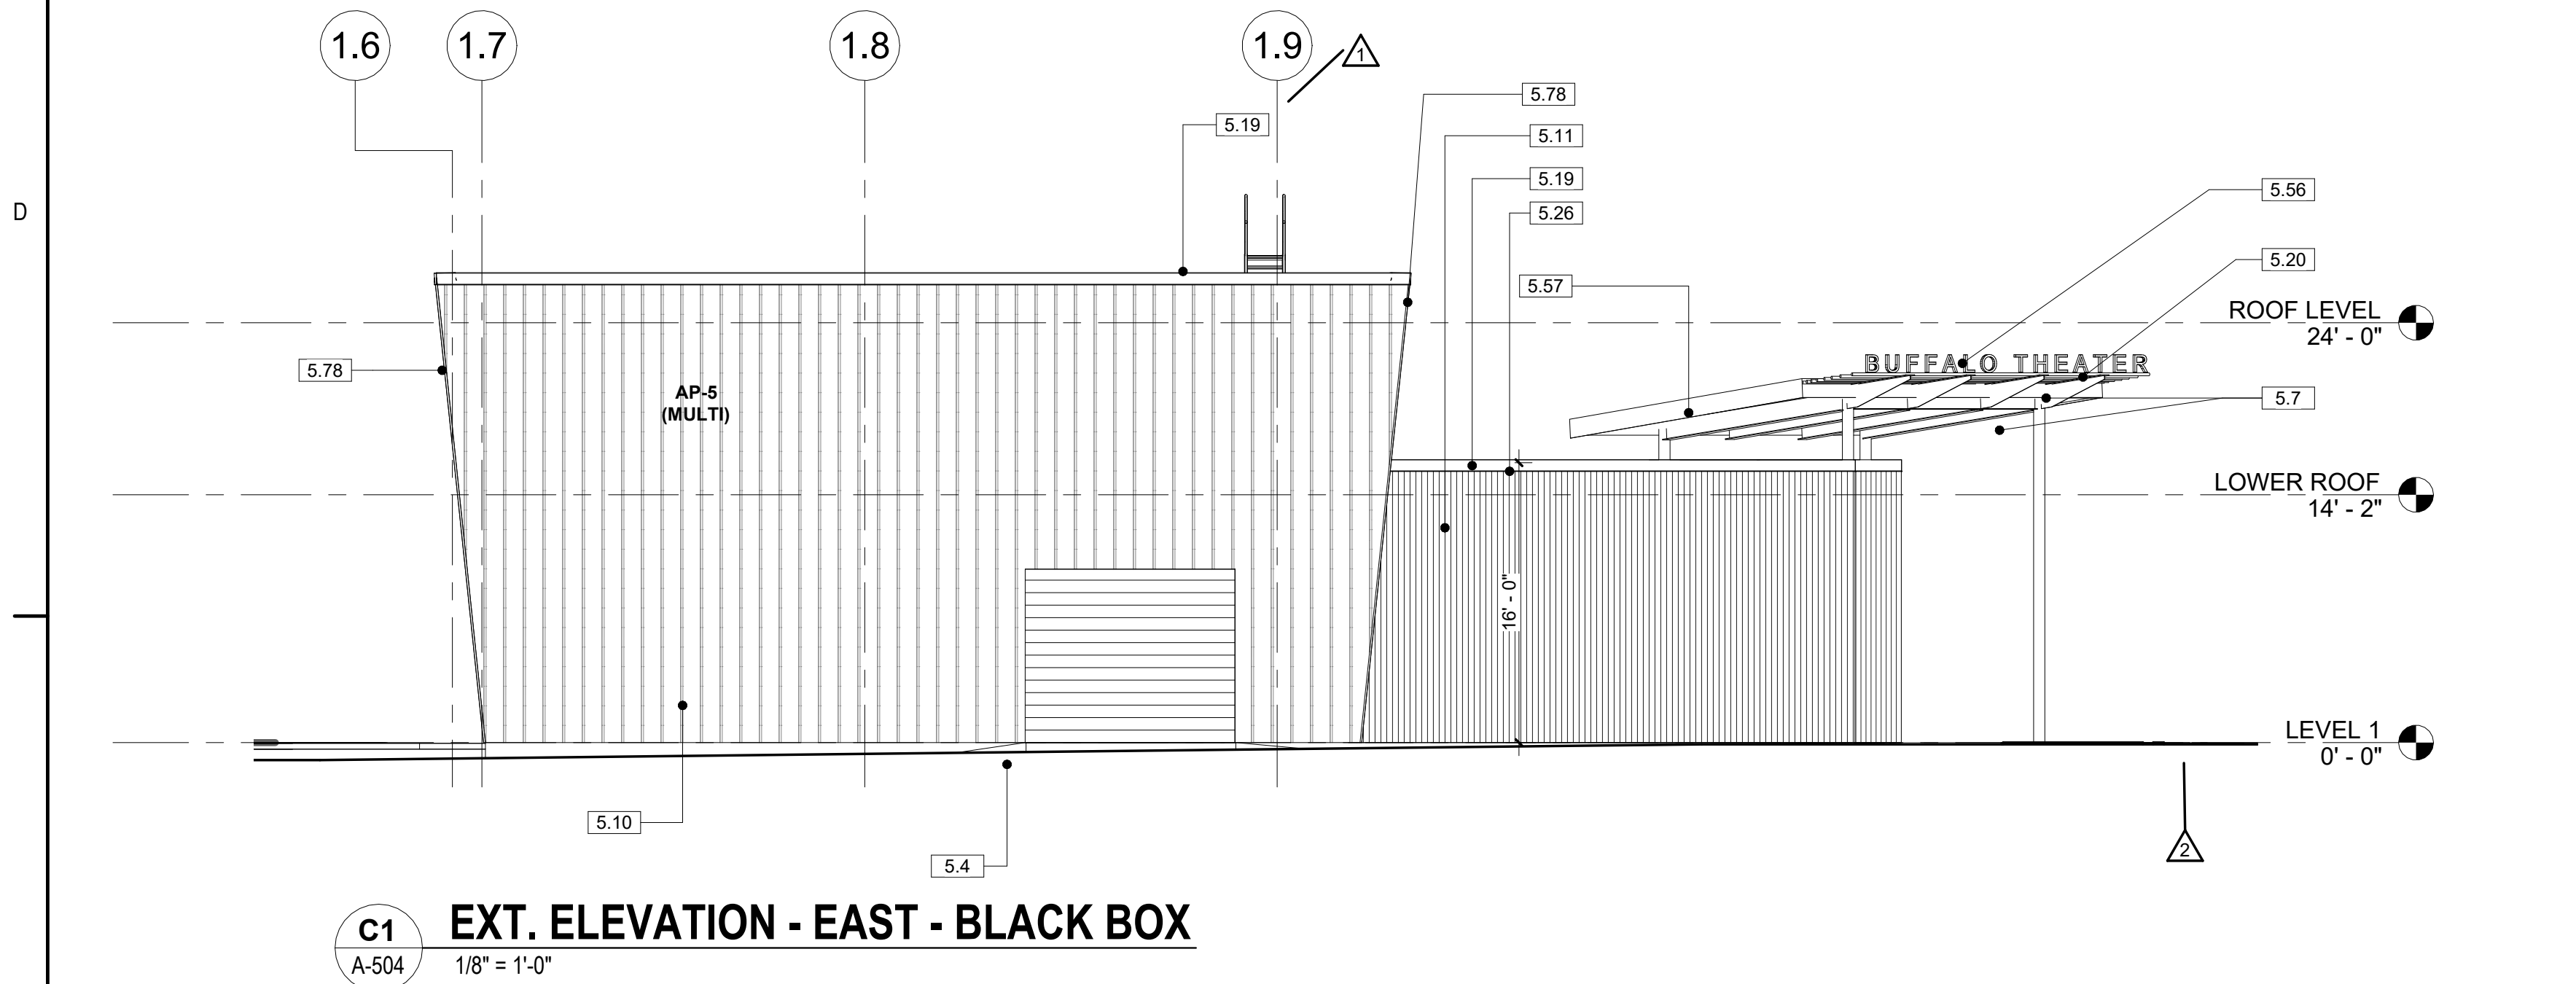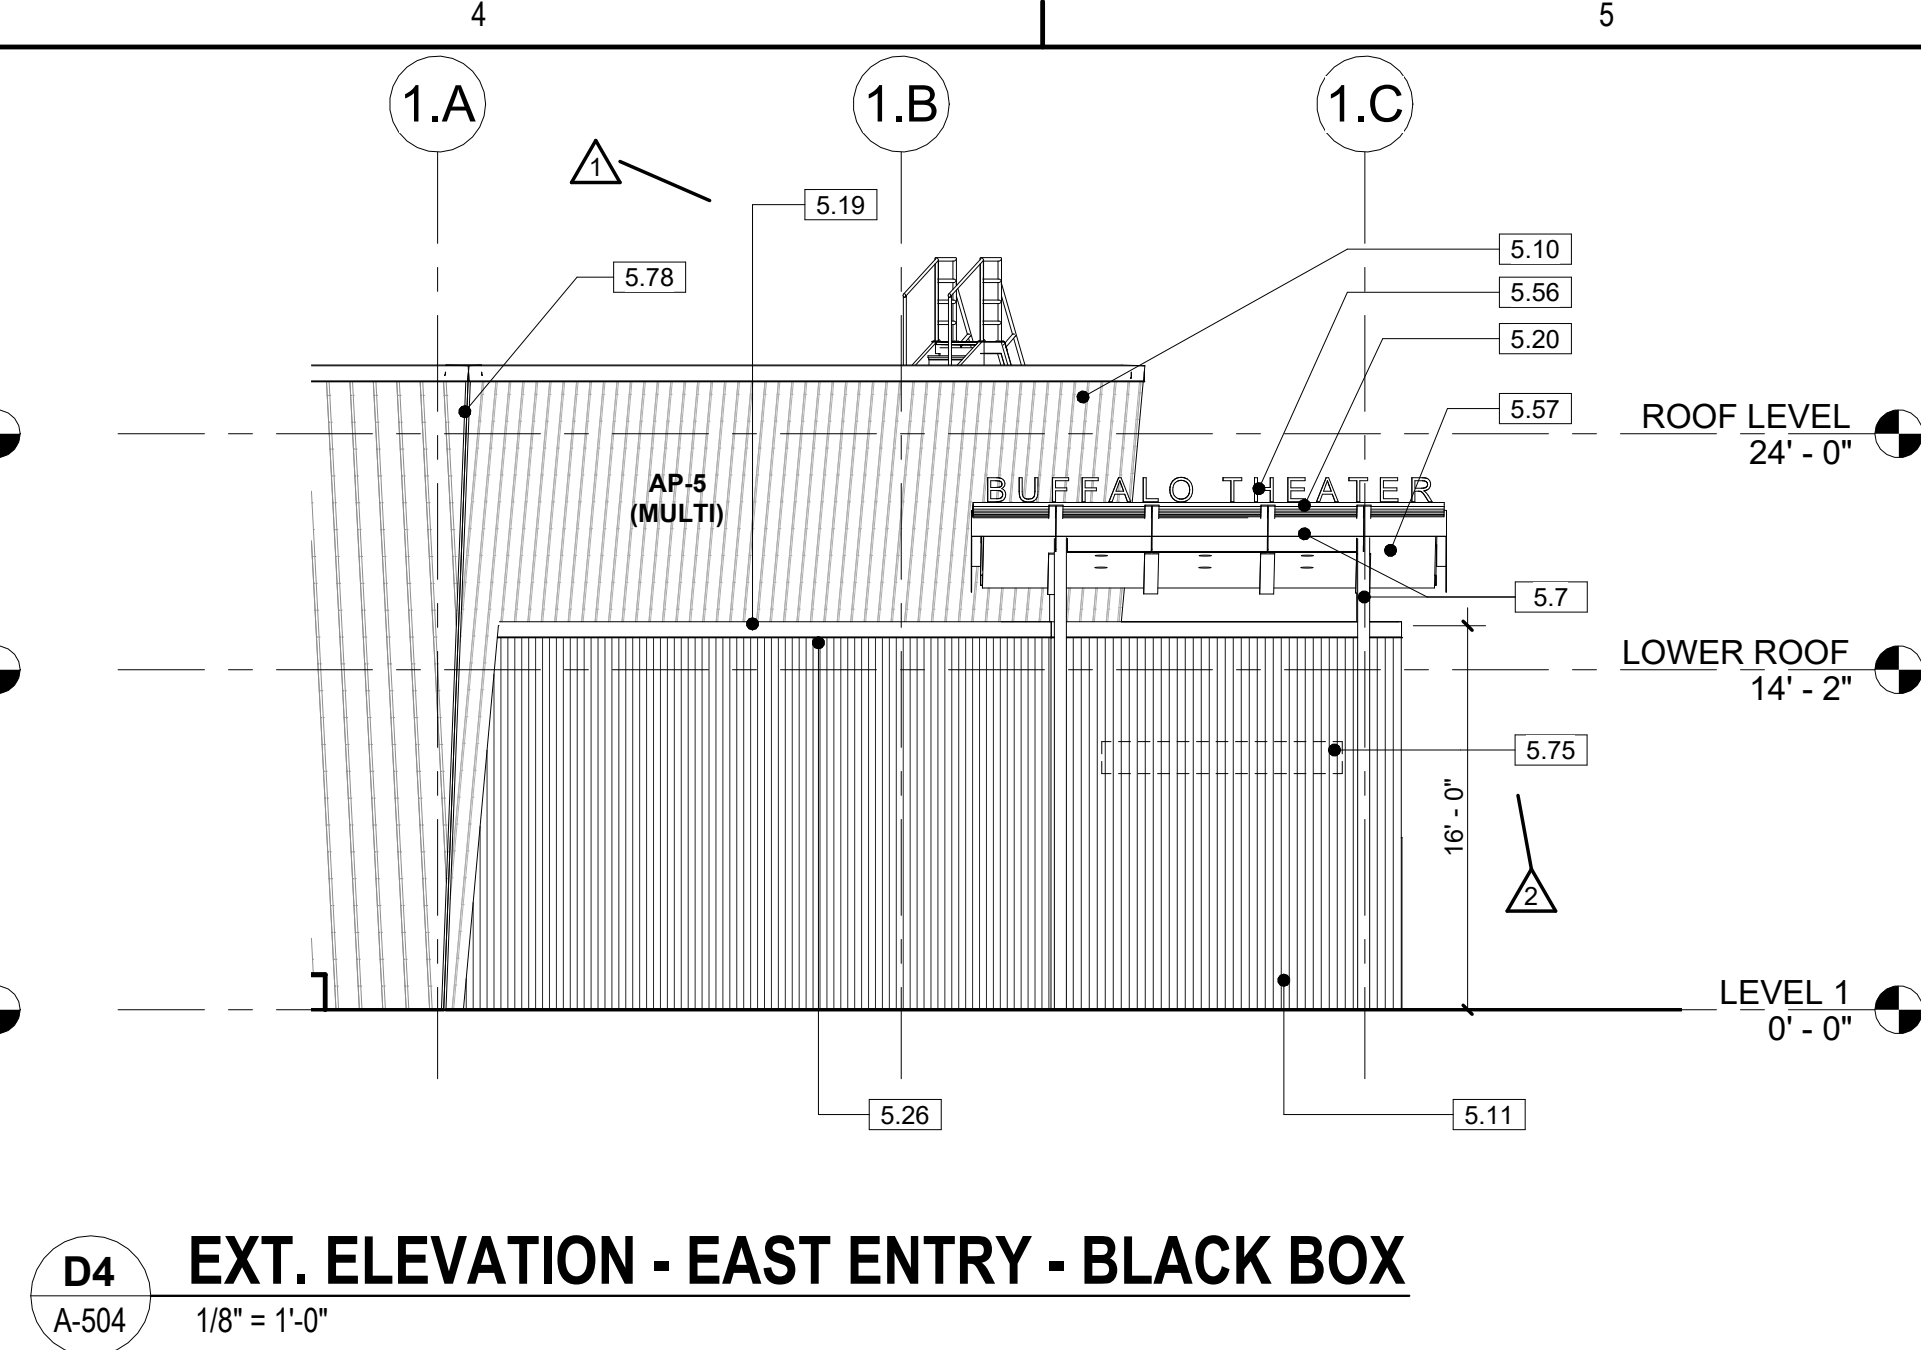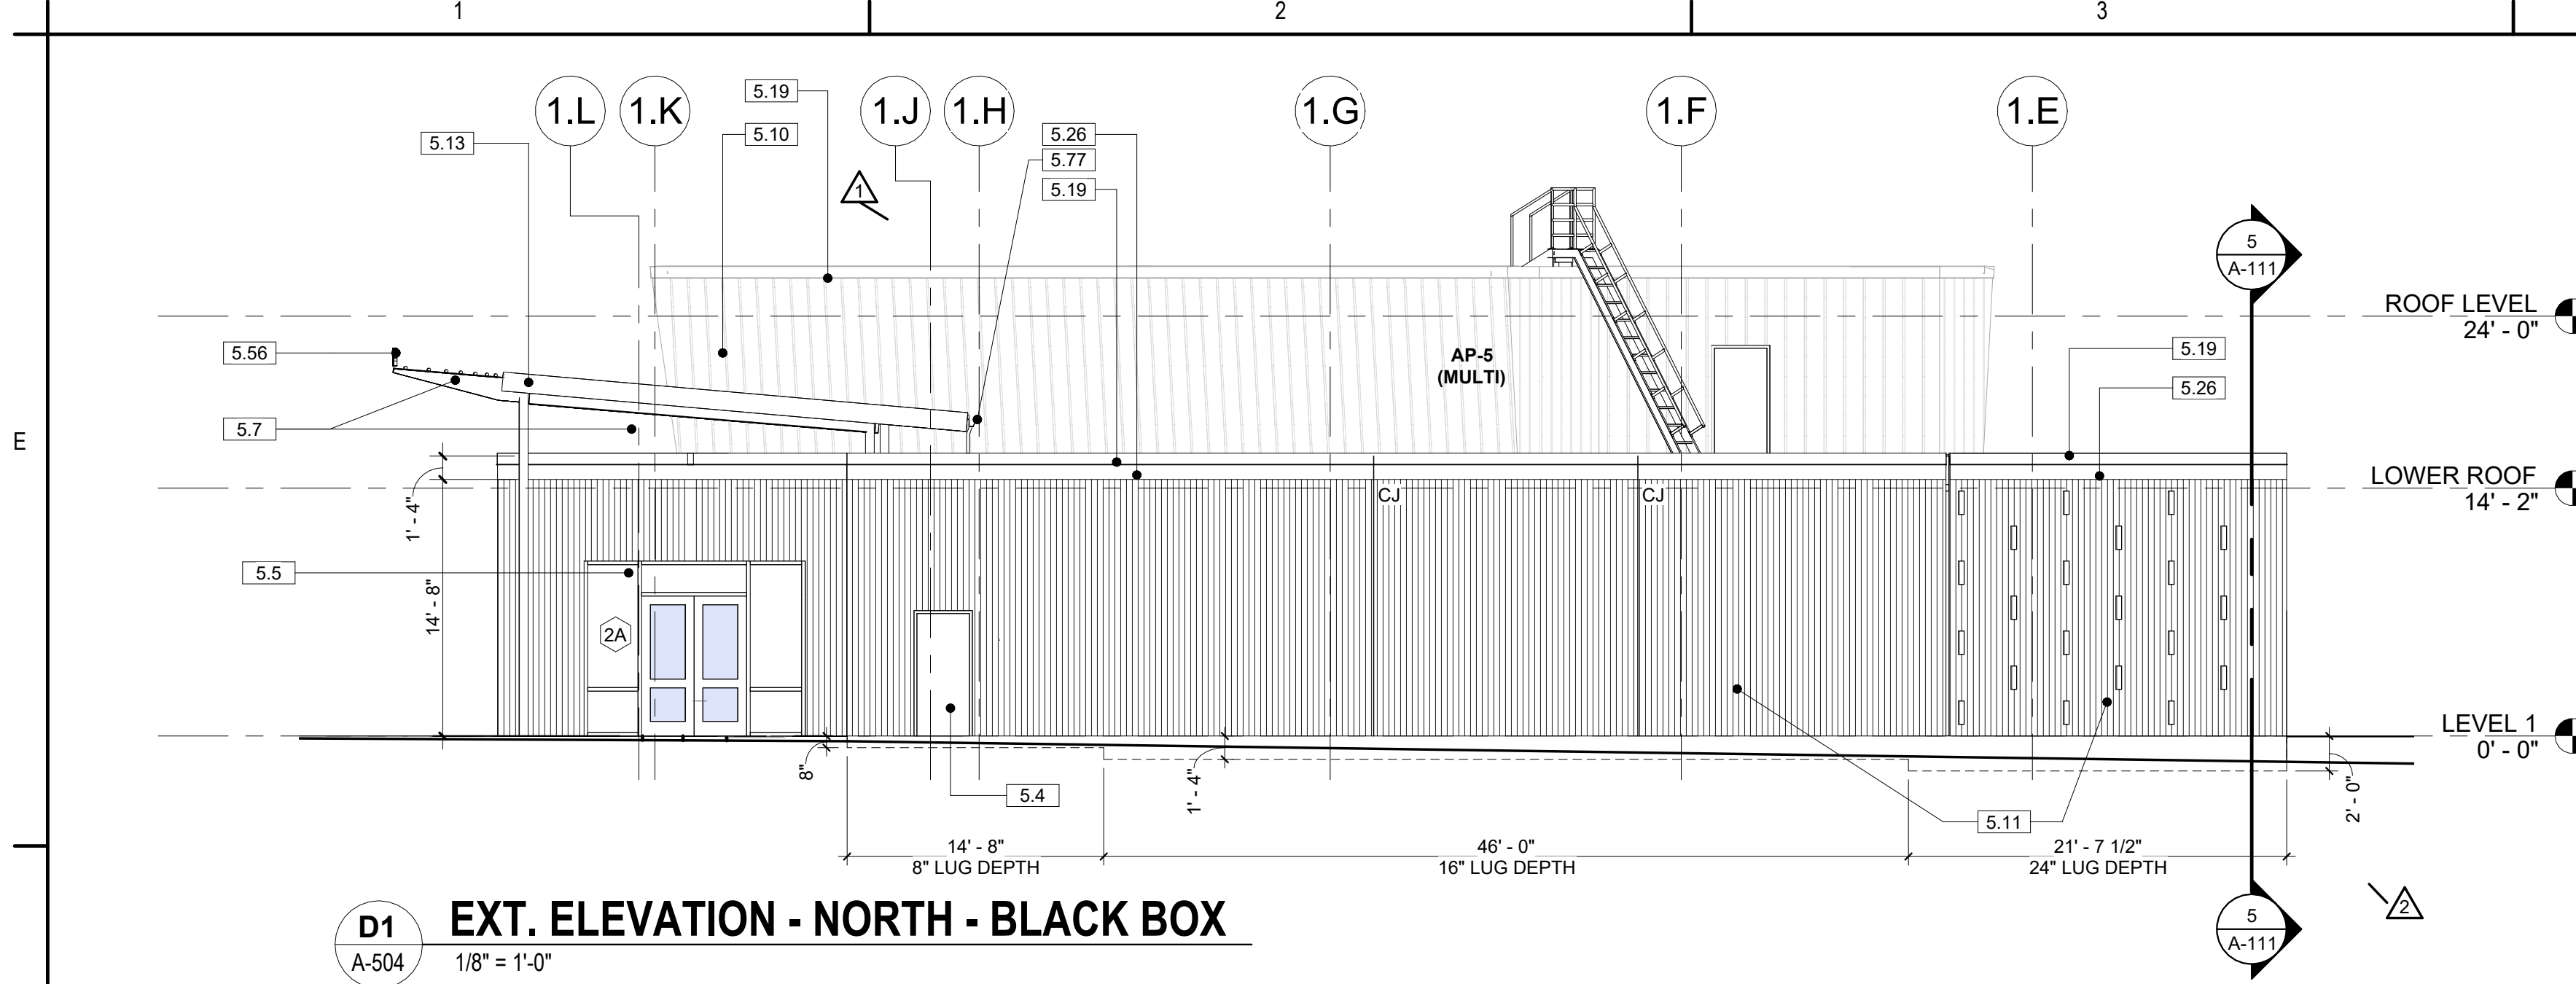


DOOR SCHEDULE - ATHLETICS																			
Mark	Room Name	Rm. No.	Clear Dim.		No. of Panels	Door		Thickness	Type	Mat'l	Mat'l	Finish	Frame			Opening		Comments	
						Panel 1 Width	Panel 2 Width						Head	Jamb	Sill	Fire Label	Glaz		
			Width	Height															Panel 1 Width
LEVEL 1																			
6C-102	CIRCULATION	6C-102	6'-0"	7'-0"	2	3'-0"	3'-0"	1 3/4"	FLD	S.C. WOOD	HM	PT	E1 / A-409	E1 / A-409	A825	-	GL-4		
6C-103	CIRC.	6C-103	3'-0"	7'-0"	1	3'-0"	0'-0"	1 3/4"	NL	S.C. WOOD	HM	PT	D3 / A-409	D3 / A-409	A825	-	GL-4		
6C-104	CIRC.	6C-104	3'-0"	7'-0"	1	3'-0"	0'-0"	1 3/4"	NL	S.C. WOOD	HM	PT	D3 / A-409	D3 / A-409	A825	-	GL-4		
6C-105	SECONDARY GYMNASIUM	61025	3'-0"	7'-0"	1	3'-0"	0'-0"	1 3/4"	NL	S.C. WOOD	HM	PT	C3 / A-409	C3 / A-409	A825	-	GL-4		
6C-106	SECONDARY GYMNASIUM	61025	3'-0"	7'-0"	1	3'-0"	0'-0"	1 3/4"	NL	S.C. WOOD	HM	PT	C3 / A-409	C3 / A-409	A825	-	GL-4		
6C-106.1	HALL	6C-106	3'-0"	7'-0"	1	3'-0"	0'-0"	1 3/4"	F	S.C. WOOD	HM	PT	E1 / A-409	E1 / A-409	A825	-	-	OPENING SOUND WARNING	
6V-1000	MAIN LOBBY	6V-1000	6'-0"	8'-0"	2	3'-0"	3'-0"	1 3/4"	FLD	ALUM	AL	ALUM	D5 / A-607	A2 / A-611	-	-	GL-4	CARD KEY ACCESS - REFER TO SECURITY DWGS	
6V-1100	LOBBY	6V-1100	6'-0"	8'-0"	2	3'-0"	3'-0"	1 3/4"	FLD	ALUM	AL	ALUM	C2 / A-410	B2 / A-410	-	-	GL-4		
6V-1200	LOBBY	6V-1200	6'-0"	8'-0"	2	3'-0"	3'-0"	1 3/4"	FLD	ALUM	AL	ALUM	D11 / A-605	E1 / A-612	-	-	GL-4		
6V-1300	VEST.	6V-1300	6'-0"	8'-0"	2	3'-0"	3'-0"	1 3/4"	FLD	ALUM	AL	ALUM	E2 / A-408	A2 / A-612	-	-	GL-4	CARD KEY ACCESS - REFER TO SECURITY DWGS	
61002	CORRIDOR	6C-100	3'-0"	7'-0"	1	3'-0"	0'-0"	1 3/4"	F	S.C. WOOD	HM	PT	E1 / A-409	E1 / A-409	A825	-	-		
61002.1	CORRIDOR	6C-100	8'-0"	4'-6"	-	-	-	2"	SST	-	-	-	B4 / A-411	A1 / A-411	-	-	-	OVERHEAD COUNTER DOOR / SST CONCESSION DOOR	
61004	IDF	61004	3'-0"	7'-0"	1	3'-0"	0'-0"	1 3/4"	F	S.C. WOOD	HM	PT	E1 / A-409	E1 / A-409	A825	20 MIN	-		
61005	ELEC	61005	3'-0"	7'-0"	1	3'-0"	0'-0"	1 3/4"	F	S.C. WOOD	HM	PT	E1 / A-409	E1 / A-409	A825	60 MIN	-		
61006	MECH	61006	3'-0"	7'-0"	1	3'-0"	0'-0"	1 3/4"	F	S.C. WOOD	HM	PT	E1 / A-409	E1 / A-409	A825	60 MIN	-		
61007	MEETING ROOM	61007	3'-0"	7'-0"	1	3'-0"	0'-0"	1 3/4"	NL	S.C. WOOD	HM	PT	E1 / A-409	E1 / A-409	A825	-	GL-4		
61008	ATHL COORD	61008	3'-0"	7'-0"	1	3'-0"	0'-0"	1 3/4"	F	S.C. WOOD	HM	PT	E1 / A-409	E1 / A-409	A825	-	-		
61008A	RR	61008A	3'-0"	7'-0"	1	3'-0"	0'-0"	1 3/4"	F	S.C. WOOD	HM	PT	E1 / A-409	E1 / A-409	A825	-	-		
61009	WEIGHT ROOM	61009	6'-0"	7'-0"	2	3'-0"	3'-0"	1 3/4"	FLD	S.C. WOOD	HM	PT	E1 / A-409	E1 / A-409	A825	-	GL-4		
61009.1	WEIGHT ROOM	61009	6'-0"	7'-0"	2	3'-0"	3'-0"	1 3/4"	F	HM	HM	PT	C3 / A-409	C3 / A-409	A825	-	-		
61010	PRIMARY GYMNASIUM	61010	6'-0"	7'-0"	2	3'-0"	3'-0"	1 3/4"	FLD	S.C. WOOD	HM	PT	D3 / A-409	D3 / A-409	A825	-	GL-4		
61010.1	PRIMARY GYMNASIUM	61010	6'-0"	7'-0"	2	3'-0"	3'-0"	1 3/4"	FLD	S.C. WOOD	HM	PT	D3 / A-409	D3 / A-409	A825	-	GL-4		
61010.2	WEIGHT ROOM	61009	3'-0"	7'-0"	1	3'-0"	0'-0"	1 3/4"	NL	S.C. WOOD	HM	PT	D3 / A-409	D3 / A-409	A825	-	GL-4		
61010.3	PRIMARY GYMNASIUM	61010	6'-0"	7'-0"	2	3'-0"	3'-0"	1 3/4"	F	HM	HM	PT	C3 / A-409	C3 / A-409	A825	-	-		
61010.4	PRIMARY GYMNASIUM	61010	6'-0"	7'-0"	2	3'-0"	3'-0"	1 3/4"	F	HM	HM	PT	C3 / A-409	C3 / A-409	A825	-	-		
61010A	PRIMARY GYMNASIUM	61010	6'-0"	7'-0"	2	3'-0"	3'-0"	1 3/4"	FLD	S.C. WOOD	HM	PT	D3 / A-409	D3 / A-409	A825	-	GL-4		
61011	CIRC.	6C-103	3'-0"	7'-0"	1	3'-0"	0'-0"	1 3/4"	F	S.C. WOOD	HM	PT	E1 / A-409	E1 / A-409	A825	-	-		
61011A	TLT/ SHWR	61011A	3'-0"	7'-0"	1	3'-0"	0'-0"	1 3/4"	F	S.C. WOOD	HM	PT	E1 / A-409	E1 / A-409	A825	-	-		
61012	GIRLS PE LOCKERS/DRESS	61012	3'-0"	7'-0"	1	3'-0"	0'-0"	1 3/4"	F	S.C. WOOD	HM	PT	E4 / A-411	D4 / A-411	-	-	-	OPENING SOUND WARNING	
61013A	STO	61013A	3'-0"	7'-0"	1	3'-0"	0'-0"	1 3/4"	F	S.C. WOOD	HM	PT	E1 / A-409	E1 / A-409	A825	-	-		
61014	GIRLS ATHLETICS LOCKERS/DRESS	61014	3'-0"	7'-0"	-	-	-	2"	-	-	-	-	-	-	-	-	-	METAL MESH PARTITION, REF DETAILS A4, A6, B4, AND B6 ON SHEET A-402	
61015	CIRC.	6C-104	3'-0"	7'-0"	1	3'-0"	0'-0"	1 3/4"	F	S.C. WOOD	HM	PT	E1 / A-409	E1 / A-409	A825	-	-		
61015A	TLT/ SHWR	61015A	3'-0"	7'-0"	1	3'-0"	0'-0"	1 3/4"	F	S.C. WOOD	HM	PT	E1 / A-409	E1 / A-409	A825	-	-		
61016	BOYS PE LOCKERS/DRESS	61016	3'-0"	7'-0"	1	3'-0"	0'-0"	1 3/4"	F	S.C. WOOD	HM	PT	E1 / A-409	E1 / A-409	A825	-	-	OPENING SOUND WARNING	
61017	BOYS ATHLETICS LOCKERS/DRESS	61017	3'-0"	7'-0"	-	-	-	2"	-	-	-	-	-	-	-	-	-	METAL MESH PARTITION, REF DETAILS A4, A6, B4, AND B6 ON SHEET A-402	
61019	CORRIDOR	6C-101	3'-0"	7'-0"	1	3'-0"	0'-0"	1 3/4"	F	S.C. WOOD	HM	PT	E1 / A-409	E1 / A-409	A825	-	-		
61022	UNISEX	61022	3'-0"	7'-0"	1	3'-0"	0'-0"	1 3/4"	F	S.C. WOOD	HM	PT	C3 / A-409	C3 / A-409	A825	-	-		
61023	LOBBY	6V-1200	4'-0"	7'-0"	1	4'-0"	0'-0"	1 3/4"	NL	S.C. WOOD	HM	PT	C3 / A-409	C3 / A-409	A825	-	GL-4		
61023A	TRAINING ROOM	61023	3'-0"	7'-0"	1	3'-0"	0'-0"	1 3/4"	F	S.C. WOOD	HM	PT	E1 / A-409	E1 / A-409	A825	-	-		
61023B	TRAINING ROOM	61023	3'-0"	7'-0"	1	3'-0"	0'-0"	1 3/4"	F	S.C. WOOD	HM	PT	E1 / A-409	E1 / A-409	A825	-	-		
61024	CUST	61024	3'-0"	7'-0"	1	3'-0"	0'-0"	1 3/4"	F	S.C. WOOD	HM	PT	C3 / A-409	C3 / A-409	A825	-	-		
61025	SECONDARY GYMNASIUM	61025	3'-0"	7'-0"	1	3'-0"	0'-0"	1 3/4"	FLD	S.C. WOOD	HM	PT	C3 / A-409	C3 / A-409	A825	-	GL-4		
61025.1	SECONDARY GYMNASIUM	61025	6'-0"	7'-0"	2	3'-0"	3'-0"	1 3/4"	FLD	S.C. WOOD	HM	PT	C3 / A-409	C3 / A-409	A825	-	GL-4		
61025.2	SECONDARY GYMNASIUM	61025	6'-0"	7'-0"	2	3'-0"	3'-0"	1 3/4"	F	HM	HM	PT	C3 / A-409	C3 / A-409	A825	-	-		
61025A	SECONDARY GYMNASIUM	61025	5'-0"	9'-2"	2	2'-6"	2'-6"	1 3/4"	F	S.C. WOOD	HM	PT	C3 / A-409	C3 / A-409	A825	-	-		
61025B	PE STO	61025B	6'-0"	7'-0"	2	3'-0"	3'-0"	1 3/4"	F	S.C. WOOD	HM	PT	C3 / A-409	C3 / A-409	A825	-	-		
61026	HALL	6C-105	3'-0"	7'-0"	1	3'-0"	0'-0"	1 3/4"	F	S.C. WOOD	HM	PT	E1 / A-409	E1 / A-409	A825	-	-		
61026A	COACH OFFICE	61026	3'-0"	7'-0"	1	3'-0"	0'-0"	1 3/4"	F	S.C. WOOD	HM	PT	E1 / A-409	E1 / A-409	A825	-	-		
61027	BOYS PE LOCKER ROOM	61027	3'-0"	7'-0"	1	3'-0"	0'-0"	1 3/4"	F	S.C. WOOD	HM	PT	E1 / A-409	E1 / A-409	A825	-	-		
61027.1	BOYS PE LOCKER ROOM	61027	3'-0"	7'-0"	1	3'-0"	0'-0"	1 3/4"	F	S.C. WOOD	HM	PT	E1 / A-409	E1 / A-409	A825	-	-	OPENING SOUND WARNING	
61028	BOYS ATHLETICS LOCKER ROOM	61028	3'-0"	7'-0"	-	-	-	2"	-	-	-	-	-	-	-	-	-	METAL MESH PARTITION, REF DETAILS A4, A6, B4, AND B6 ON SHEET A-402	
61030	HALL	6C-106	3'-0"	7'-0"	1	3'-0"	0'-0"	1 3/4"	F	S.C. WOOD	HM	PT	E1 / A-409	E1 / A-409	A825	-	-		
61030A	COACH OFFICE	61030	3'-0"	7'-0"	1	3'-0"	0'-0"	1 3/4"	F	S.C. WOOD	HM	PT	E1 / A-409	E1 / A-409	A825	-	-		
61031	GIRLS PE LOCKER ROOM	61031	3'-0"	7'-0"	1	3'-0"	0'-0"	1 3/4"	F	S.C. WOOD	HM	PT	E1 / A-409	E1 / A-409	A825	-	-		
61031.1	GIRLS PE LOCKER ROOM	61031	3'-0"	7'-0"	1	3'-0"	0'-0"	1 3/4"	F	S.C. WOOD	HM	PT	C3 / A-409	C3 / A-409	A825	-	-	OPENING SOUND WARNING	
61033	GIRLS ATHLETICS LOCKER ROOM	61033	3'-0"	7'-0"	-	-	-	2"	-	-	-	-	-	-	-	-	-	METAL MESH PARTITION, REF DETAILS A4, A6, B4, AND B6 ON SHEET A-402	
61034	MECH	61034	6'-0"	7'-0"	2	3'-0"	3'-0"	1 3/4"	F	S.C. WOOD	HM	PT	C3 / A-409	C3 / A-409	A825	60 MIN	-		
61035	STO	61035	6'-0"	5'-8"	2	3'-0"	3'-0"	1 3/4"	F	S.C. WOOD	HM	PT	E1 / A-409	E1 / A-409	A825	-	-		
61036	HALL	6C-107	3'-6"	7'-0"	1	3'-6"	0'-0"	1 3/4"	F	S.C. WOOD	HM	PT	E1 / A-409	E1 / A-409	A825	-	GL-4		
61036A	MECH	61036	3'-0"	7'-0"	2	3'-0"	3'-0"	1 3/4"	F	HM	HM	PT	E4 / A-411	D4 / A-411	-	-	-		
61037	ELE	61037	3'-0"	7'-0"	1	3'-0"	0'-0"	1 3/4"	F	S.C. WOOD	HM	PT	E1 / A-409	E1 / A-409	A825	60 MIN	-		
61038	IDF	61038	7'-0"	7'-0"	1	3'-0"	0'-0"	1 3/4"	F	S.C. WOOD	HM	PT	E1 / A-409	E1 / A-409	A825	20 MIN	-		
61039	FIRE RISER ROOM	61039	3'-0"	7'-0"	-	-	-	1 3/4"	F	HM	HM	PT	E4 / A-411	D4 / A-411	-	-	-		
Grand total: 63																			



KEYNOTE LEGEND

5.4	NEW DOOR AS SCHEDULED
5.5	NEW ALUMINUM STOREFRONT SYSTEM
5.7	STEEL STRUCTURAL FRAMING: ALL EXPOSED STEEL TO BE PAINTED WITH HIGH PERFORMANCE PAINT, TYPICAL - ALSO SEE TO STRUCT.
5.9	NEW 6" H ORNAMENTAL FENCE AND GATE
5.10	NEW KYNAR PRE-FINISHED GALVALUME STEEL REVEAL WALL PANEL SYSTEM (MULTI-COLOR)
5.11	NEW 8x16x4 RIBBED CONCRETE MASONRY VENEER UNITS (4 RIBS PER BLOCK)
5.13	NEW CANTILEVERED PREFINISHED ALUMINUM ENTRY CANOPY (BASIS OF DESIGN: AVADEKI)
5.19	PREFINISHED METAL PARAPET CAP. CONT.
5.20	PTD. 4" DIA. STEEL BAR LOUVER MOUNTED OVER PTD. TAPERED STEEL JOISTS WITH END CAPS
5.26	NEW 8x16x4 CONCRETE MASONRY VENEER UNITS. SMOOTH FACE WITH COLOR TO MATCH NEW RIBBED BLOCK
5.56	12" H ALUMINUM CAST LETTERS PIN MOUNTED TO PTD. STEEL FLAT BAR W/ LED LIGHTING
5.57	NEW PREFINISHED METAL CANOPY WITH KYNAR FINISHED GALVALUME STEEL SOFFIT
5.60	WALL MOUNTED ROOF ACCESS STEEL LADDER
5.72	NEW 8x16x4 CONCRETE MASONRY VENEER UNIT HEADER. SMOOTH FACE WITH COLOR TO MATCH NEW RIBBED BLOCK
5.75	BUILDING IDENTIFICATION: 12" WALL MTD. ALUMINUM LETTERS
5.77	PREFINISHED METAL GUTTER & DOWNSPOUT. PROVIDE SPLASH BLOCK AS NECESSARY TO PROTECT NEW ROOFING. SEE ALSO ROOFING
5.78	METAL PANEL TRIM PER METAL PANEL MFR. STANDARD DETAILS. STANDARD MFR. CHANNEL WITH ENDS LAPPED OVER CONTINUOUS CAULK PER MFR.

EXTERIOR ELEVATION LEGEND

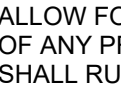	RIBBED CONCRETE MASONRY VENEER UNIT MFR: BEST BLOCK 4x8x16 4-RIB SMOOTH FACED RIBBED BLOCK (#9 CREAM)	
	GLAZED BRICK MFR: ACME-BELDEN (REFER TO ELEV. FOR COLORS)	COLOR 1: OLIVE GLAZE COLOR 2: WRANGLER GLAZE COLOR 3: MANGO GLAZE
	HS-12 - KYNAR PREFINISHED GALVALUME STEEL EMBOSSED MFR: BERRIDGE (AP-1) ZINC GRAY	
	HS-12 - KYNAR PREFINISHED GALVALUME STEEL EMBOSSED MFR: BERRIDGE (AP-2) TERRA-COTTA	
	HS-12 - KYNAR PREFINISHED GALVALUME STEEL EMBOSSED MFR: BERRIDGE (AP-3) PATINA GREEN	
	HS-12 - KYNAR PREFINISHED GALVALUME STEEL EMBOSSED MFR: BERRIDGE (AP-4) BRISTOL BLUE	
	HS-12 - KYNAR PREFINISHED GALVALUME STEEL EMBOSSED MFR: BERRIDGE (AP-5) MULTICOLOR: ZINC GRAY, CITY SCAP & CHARCOAL GRAY	

ELEVATION GENERAL NOTES

1. REVEAL METAL WALL PANEL SYSTEM COLORS.
PERFORMING ARTS:
ALLOW FOR A MIX OF PANEL COLORS IN THE INDICATED THREE INDICATED COLORS, OF ANY PROPORTION AND PATTERN AS SELECTED BY ARCHITECT. EACH COLOR SHALL RUN FULL HEIGHT OF PANEL RUN.
BLACK BOX:
PROVIDE FOR A SINGLE COLOR TO BE SELECTED BY ARCHITECT FROM THE THREE INDICATED COLORS.
ATHLETICS GYMNASIUM:
PROVIDE FOR A SINGLE COLOR TO BE SELECTED BY ARCHITECT FROM THE THREE INDICATED COLORS.
2. VERTICAL METAL WALL PANEL TO BE FULL CONTINUOUS FULL HEIGHT OF RUN WHERE POSSIBLE.
3. NOT ALL MEP EQUIPMENT AND DEVICES SHOWN. REFER TO MEP DRAWINGS FOR ADDITIONAL INFORMATION.
4. ALL EXPANSION AND CONTROL JOINTS IN MASONRY TO HAVE SEALANT AND BACKER RODS.
5. PROVIDE MANUFACTURER'S STANDARD MATCHING TRIM AND DETAILS AT ALL METAL PANEL CORNERS, SILLS AND EDGE CONDITIONS.



Permit/Seal



06.24.24

Consultant



Client/Project
SAN ANTONIO INDEPENDENT SCHOOL DISTRICT

**BOND 2020 FOX TECH CAMPUS
ADDITIONS & RENOVATIONS**

637 N. MAIN AVE.
SAN ANTONIO, TEXAS 78205

DATE	06/24/24	CONSTRUCTION	DOCUMENTS
PROJECT NO.	A202108.00	DRAWN BY	RL
		CHECKED BY	RH

#	DESCRIPTION	DATE
1	PERMIT SET	08/23/24
2	ADDENDUM #01	07/17/24
3	ADDENDA #02	07/26/24

PERMIT SET

Sheet Name
**EXTERIOR ELEVATIONS-
BLACK BOX**

Drawing No.
A-504



BOND 2020
SCHOOL RENOVATIONS • TECHNOLOGY

**BOND 2020 FOX TECH CAMPUS
ADDITIONS & RENOVATIONS**

24 CONSTRUCTION DOCUMENTS

T NO. 08.00 DRAWN BY EG CHECKED BY RH


REVISIONS

DESCRIPTION	DATE
PERMIT SET	08/23/2017
ADDENDA #02	07/26/2017


ERMIT SET

Sheet Name
BUILDING SECTIONS -
BLACK BOX


Drawing No.
A-511

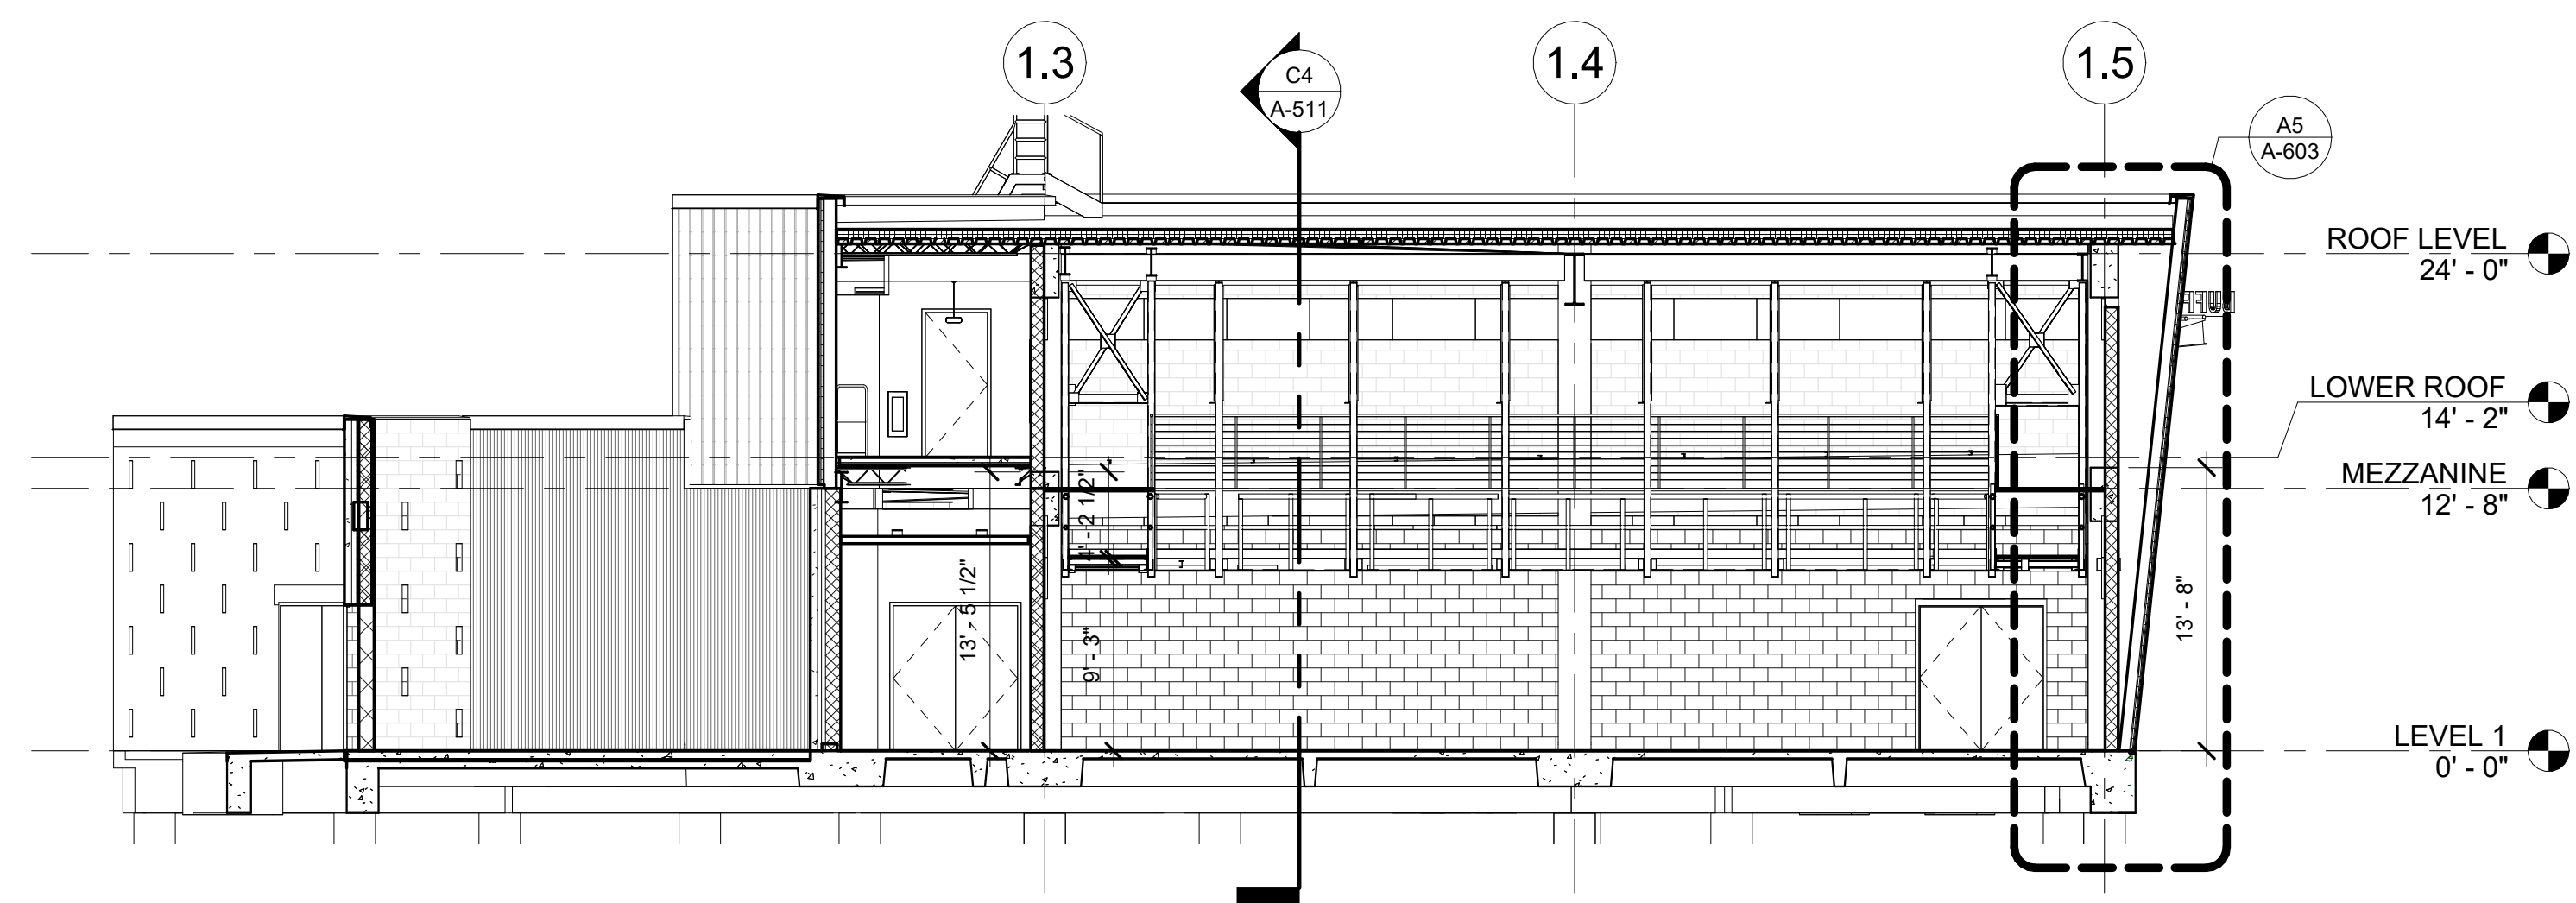


D1 BUILDING SECTION
A-511 1/8" = 1'-0"

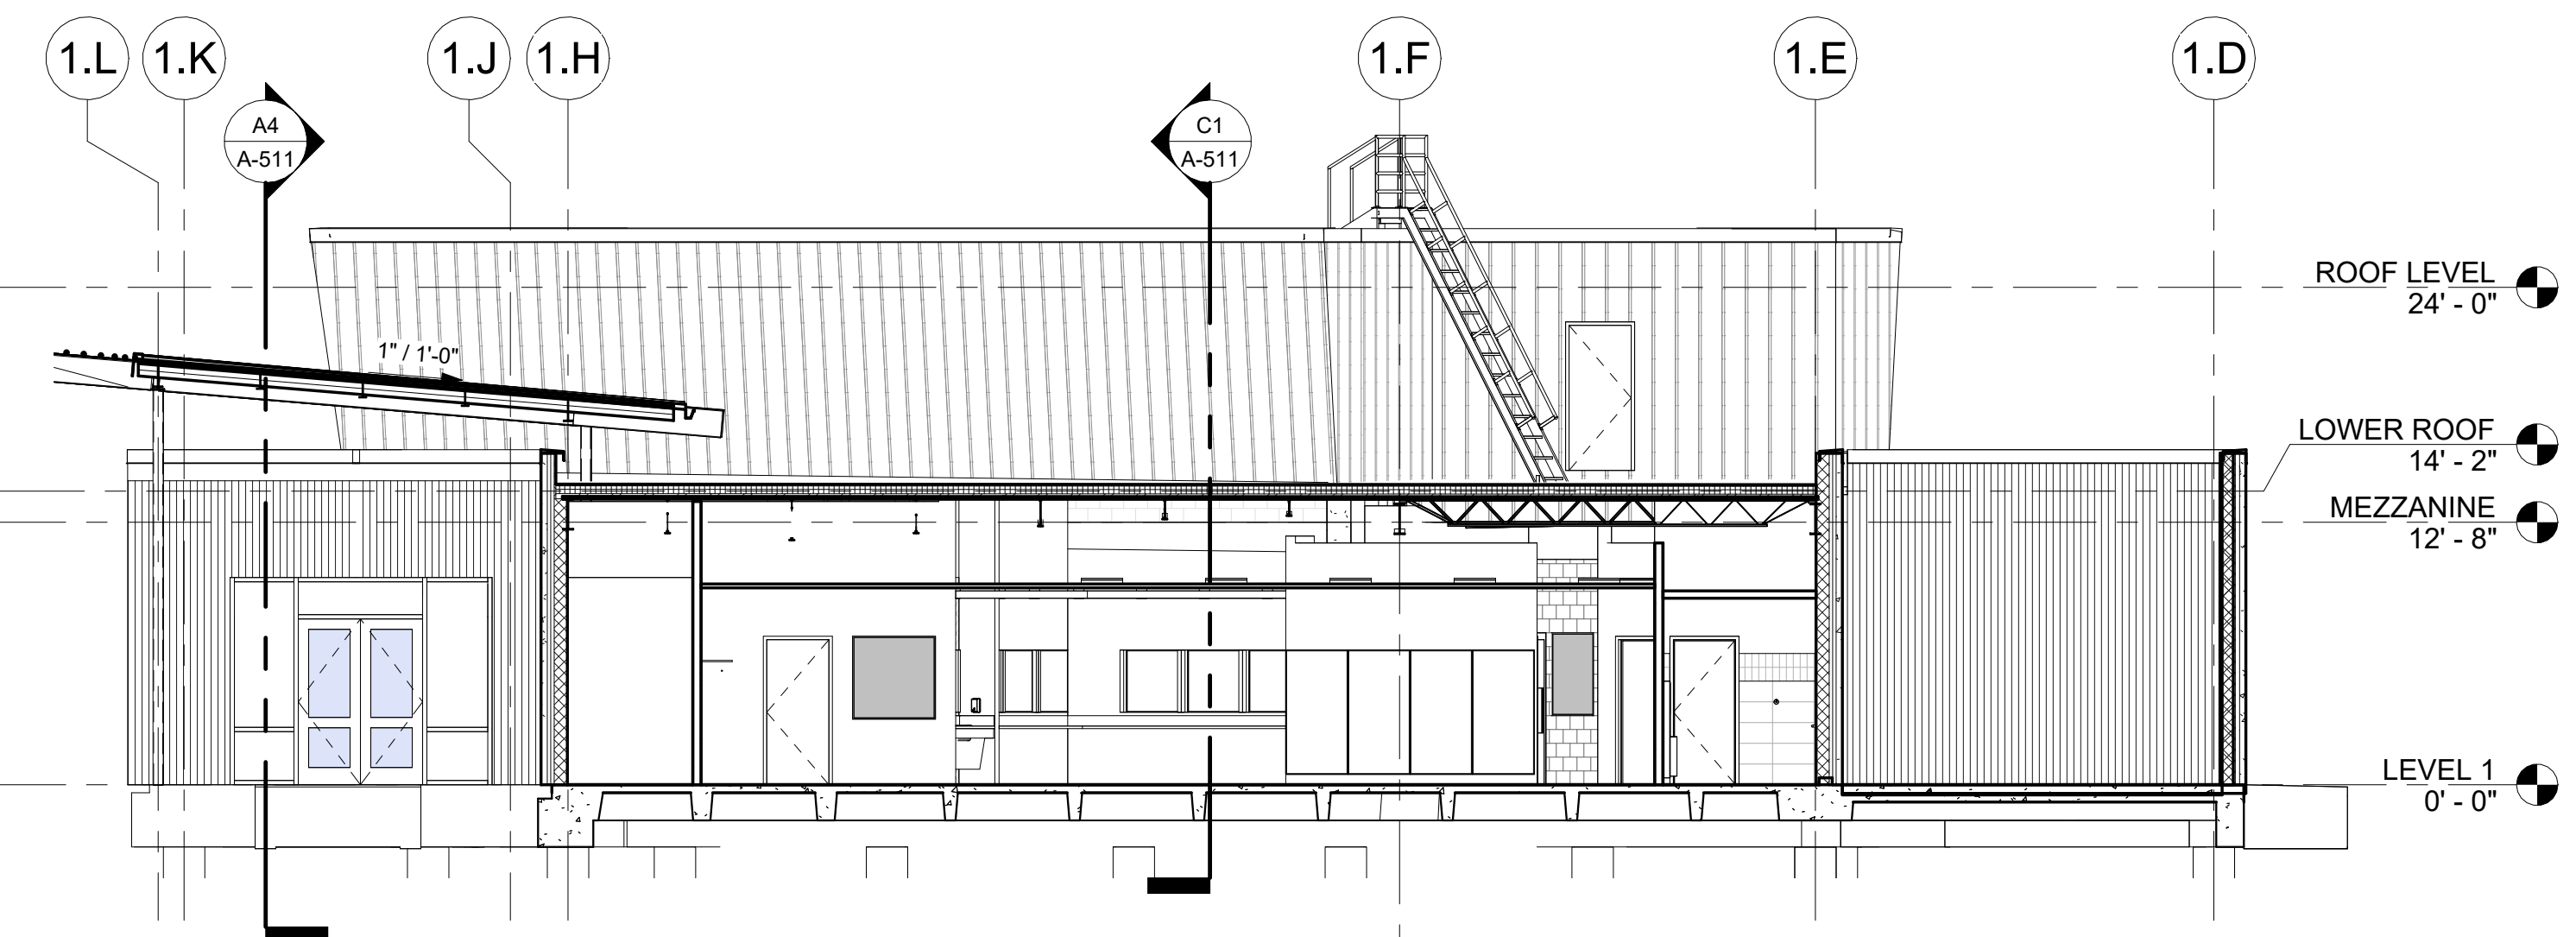


D4 BUILDING SECTION
A-511 1/8" = 1'-0"

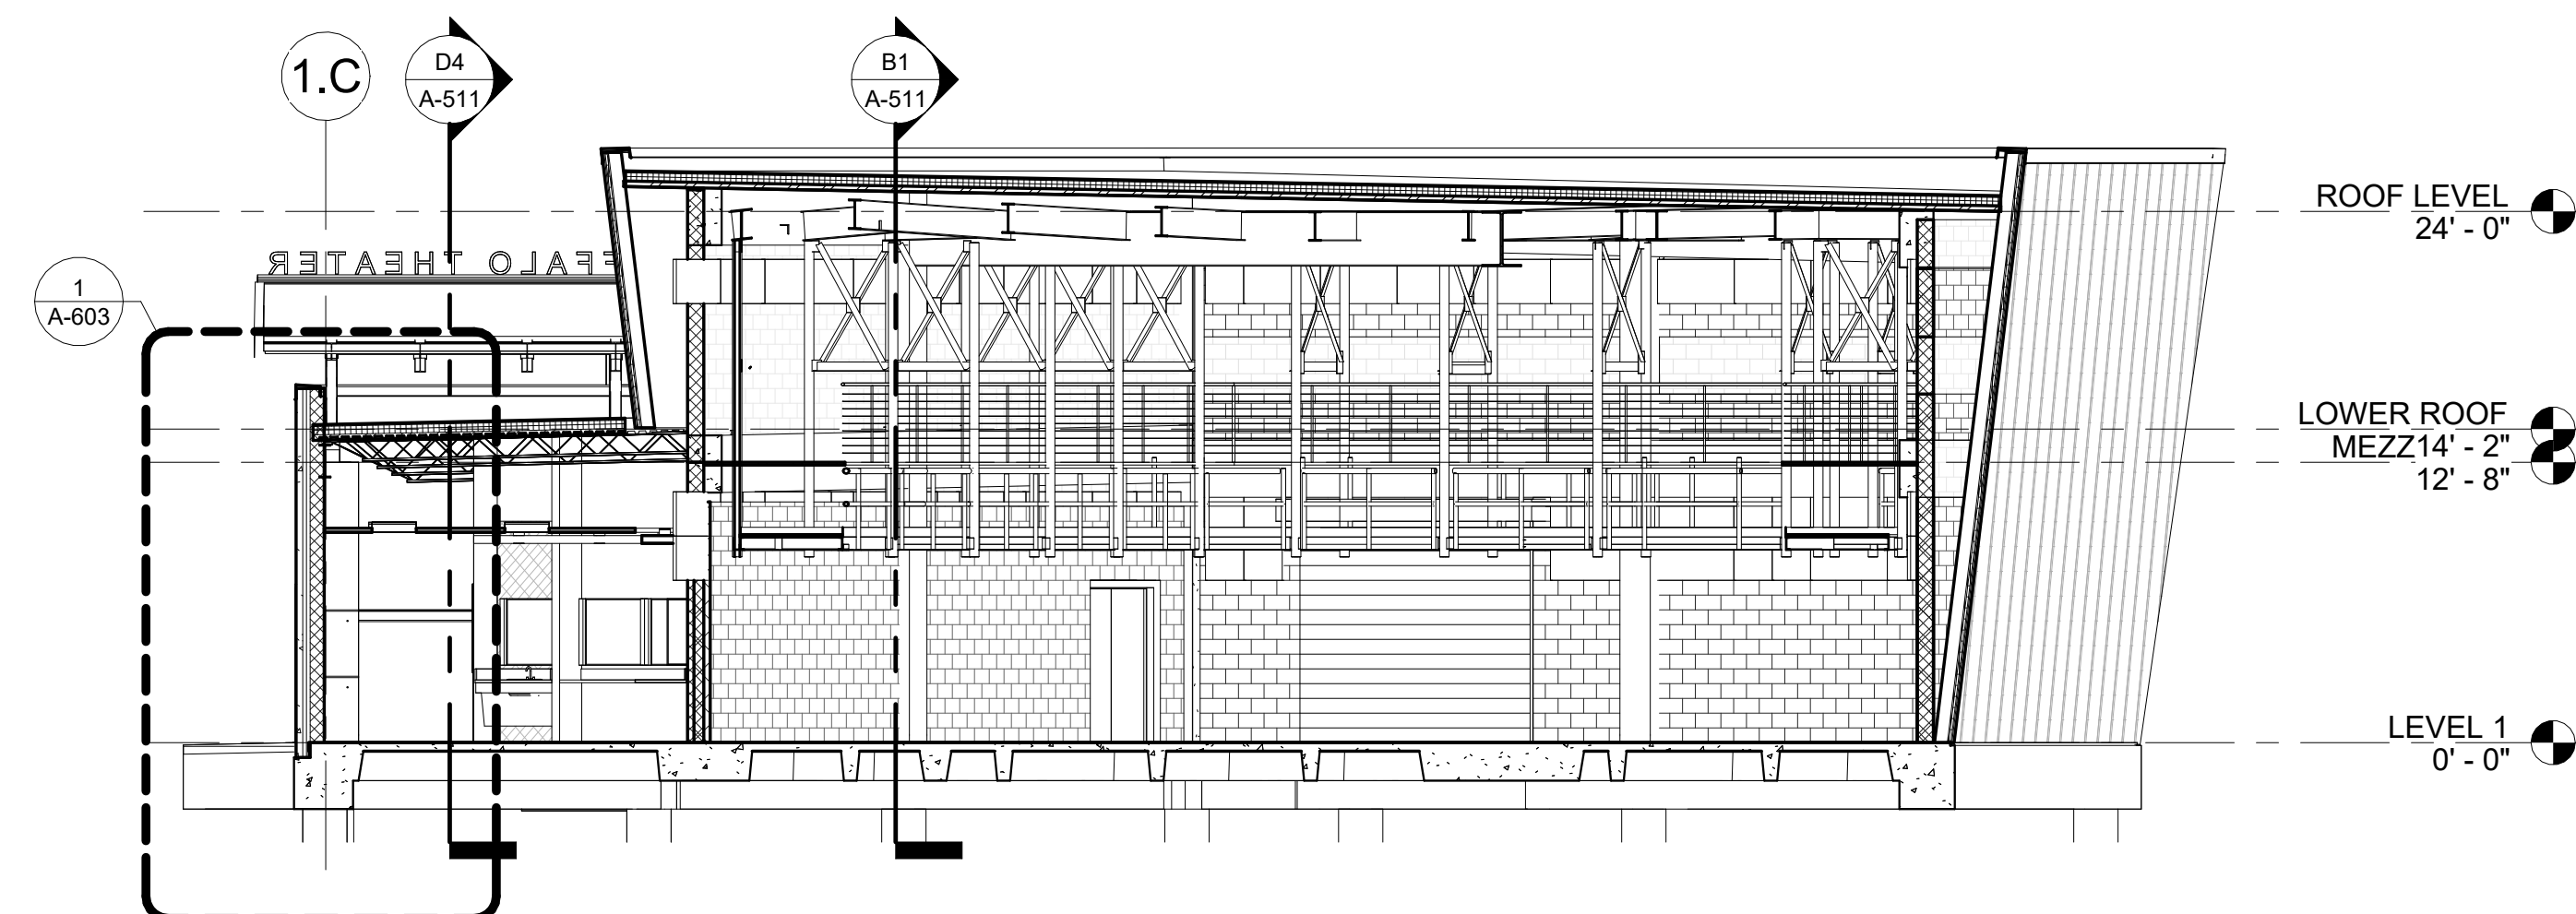


BUILDING SECTION @ 1.C - BLACK BOX

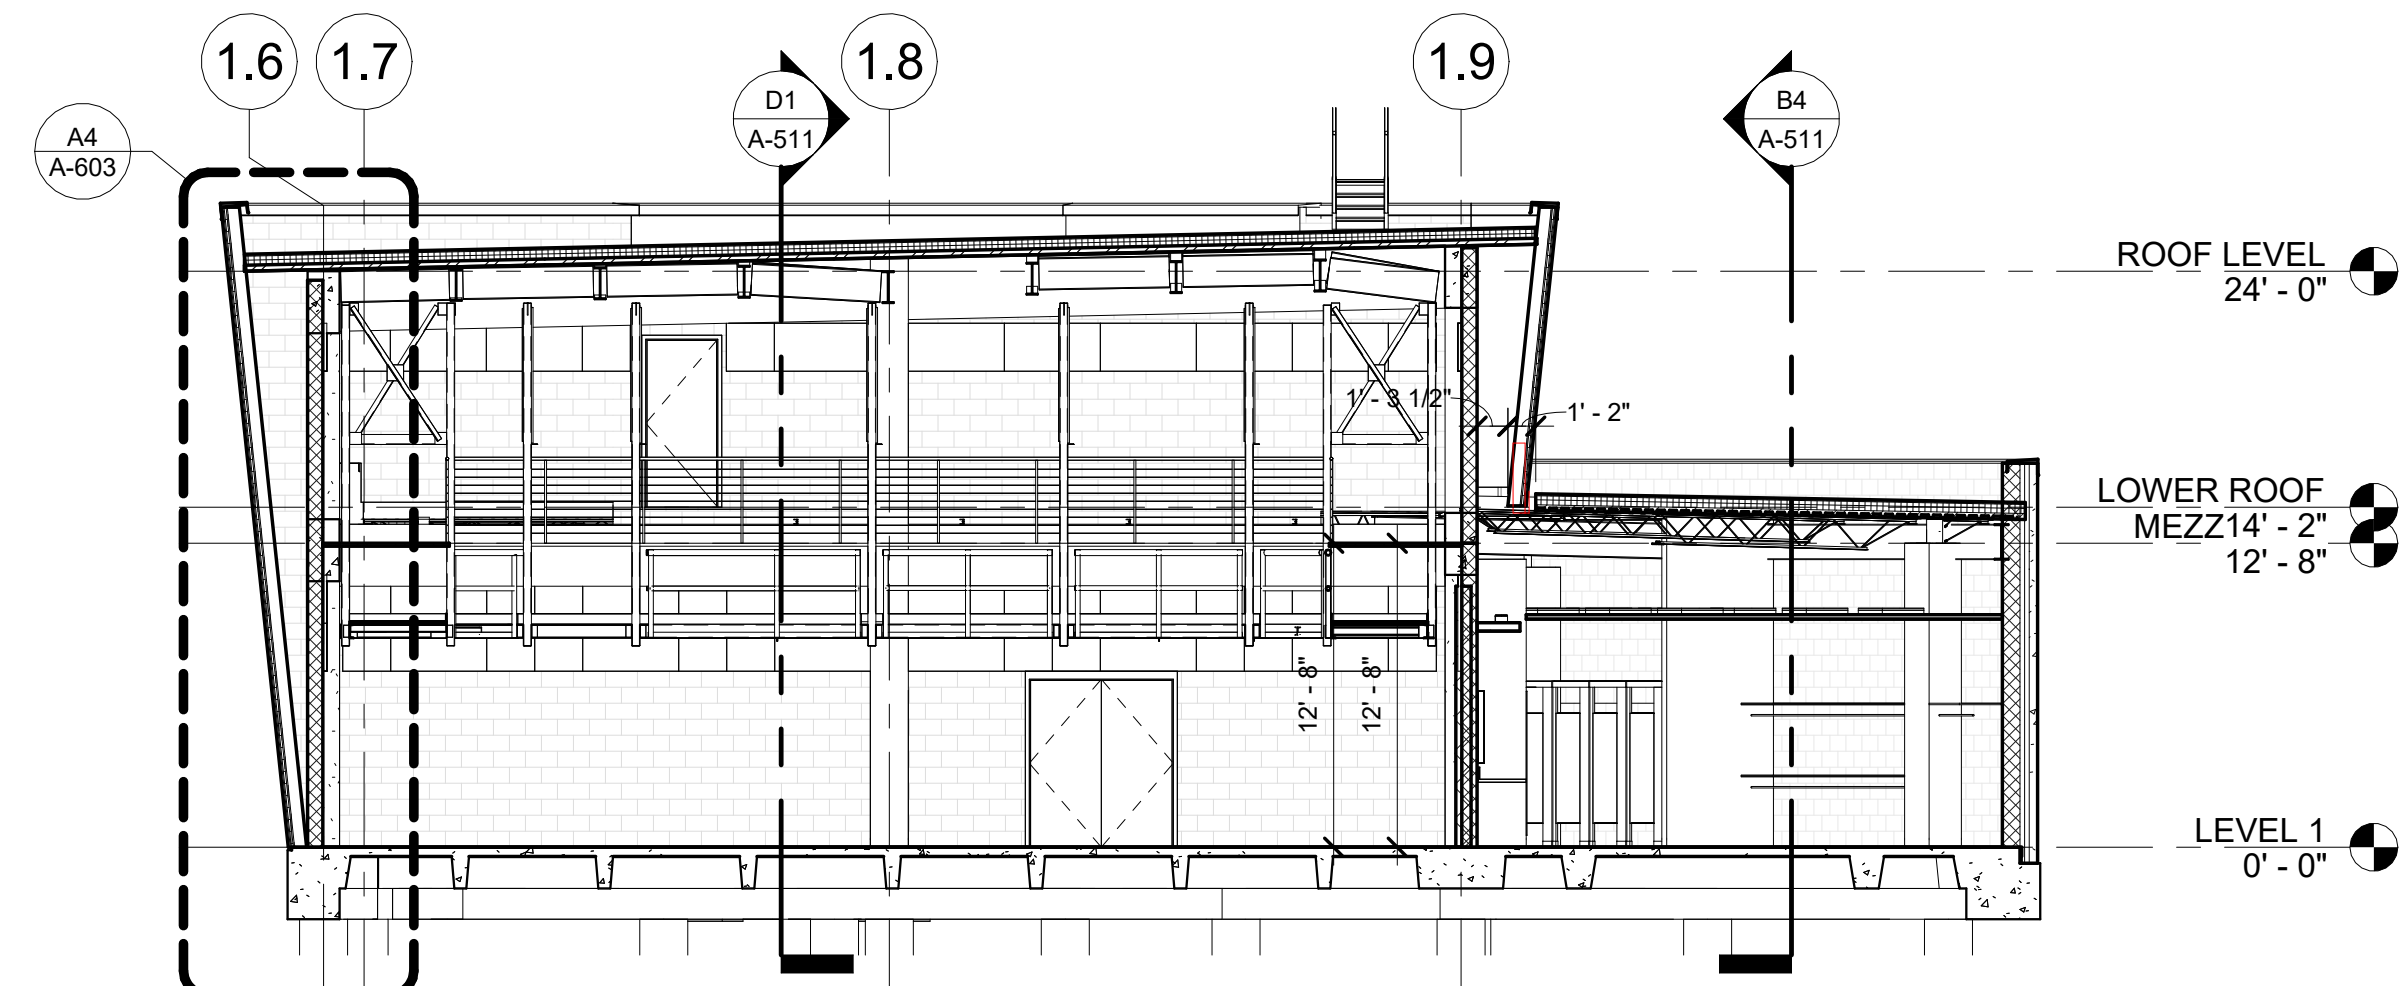


C4 **BUILDING SECTION**
A-511 1/8" = 1'-0"

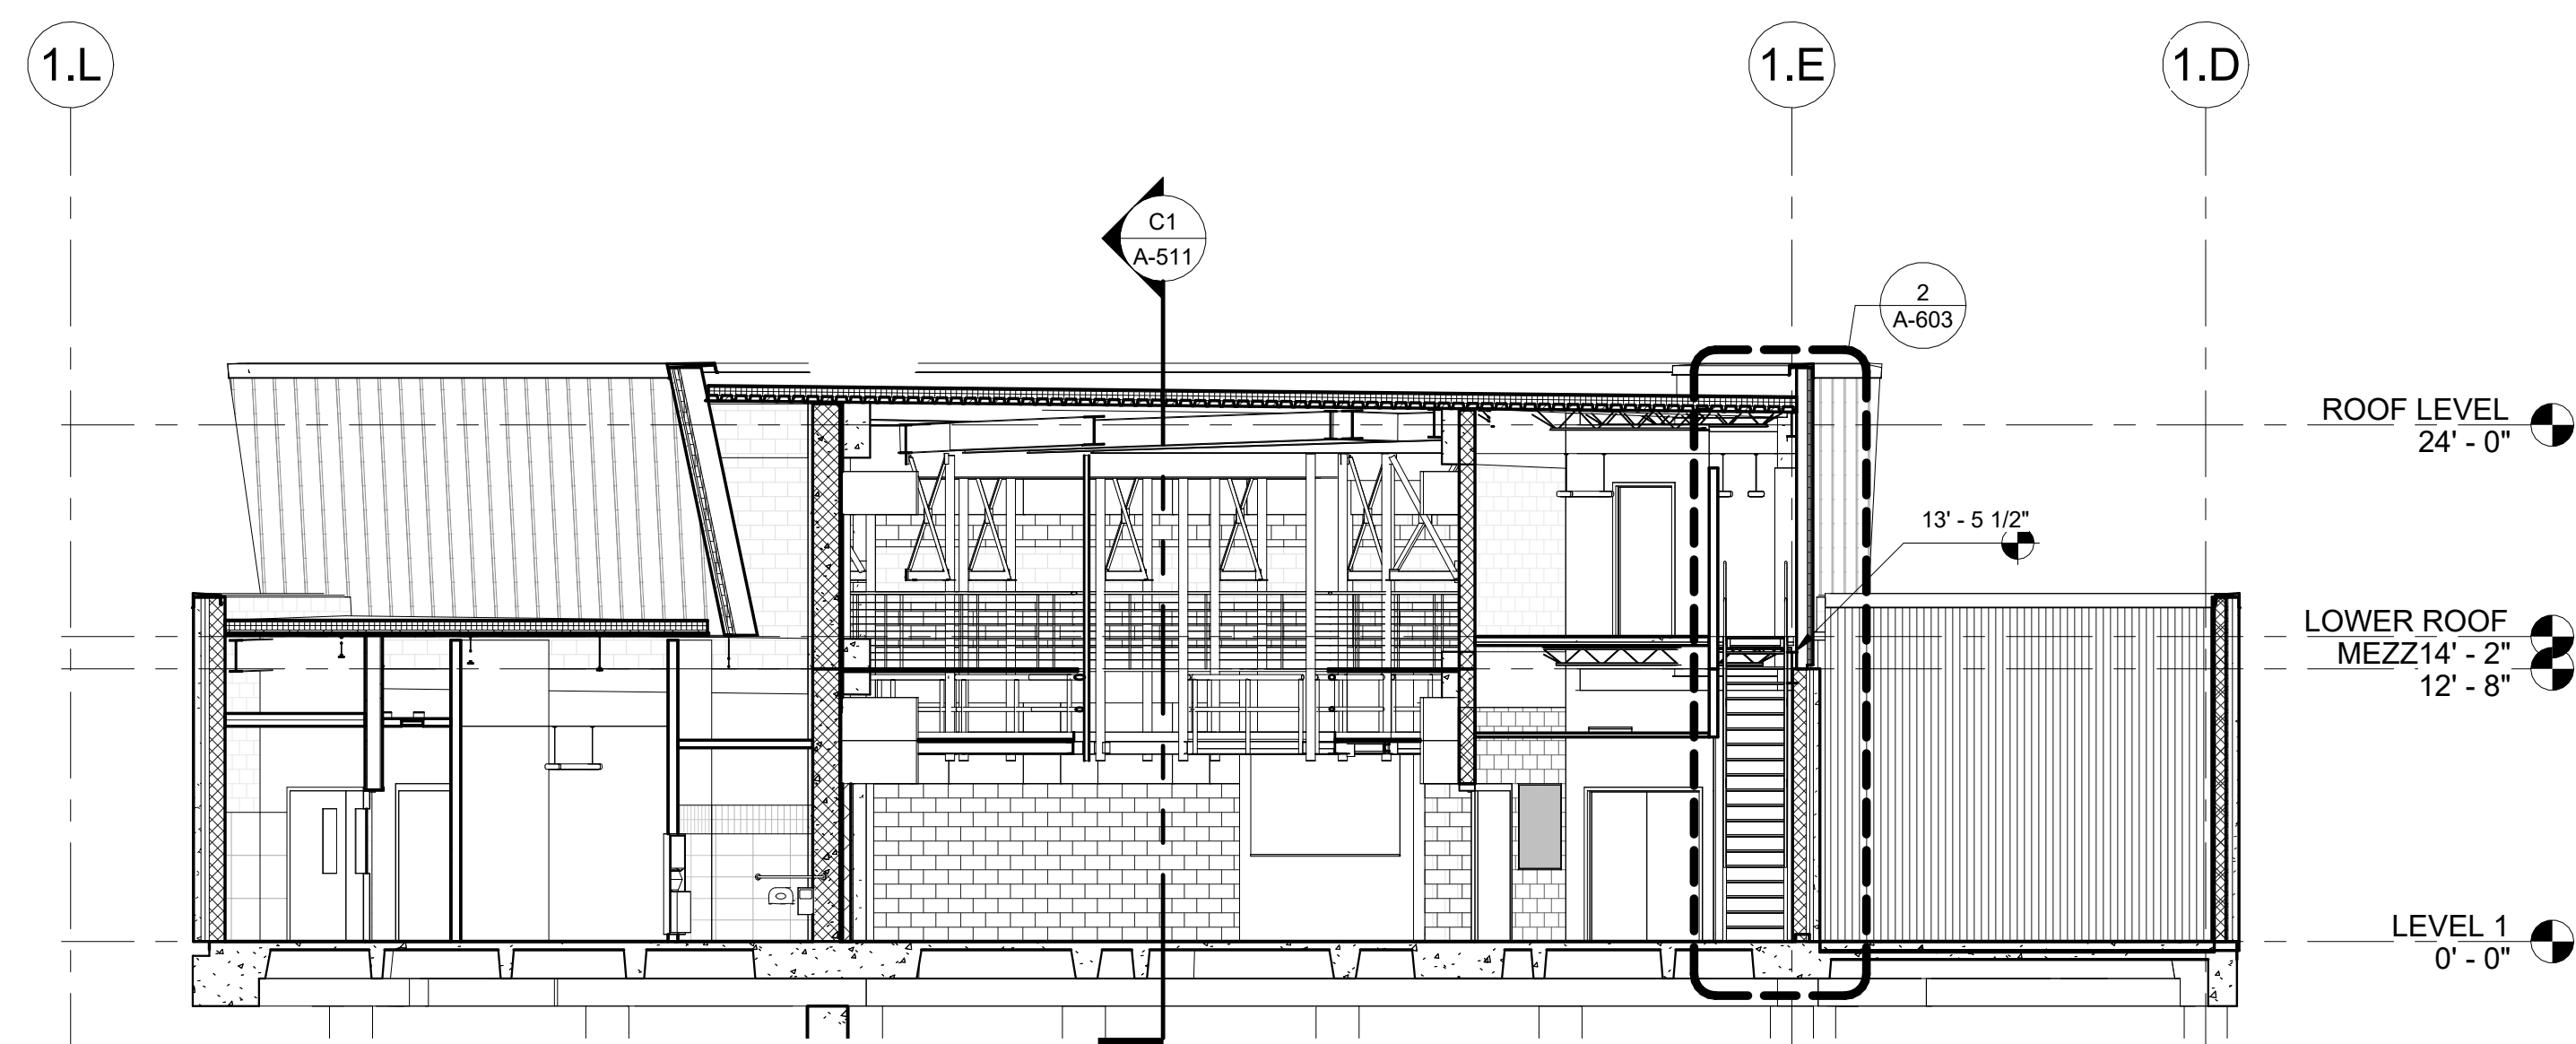


B1
A-511

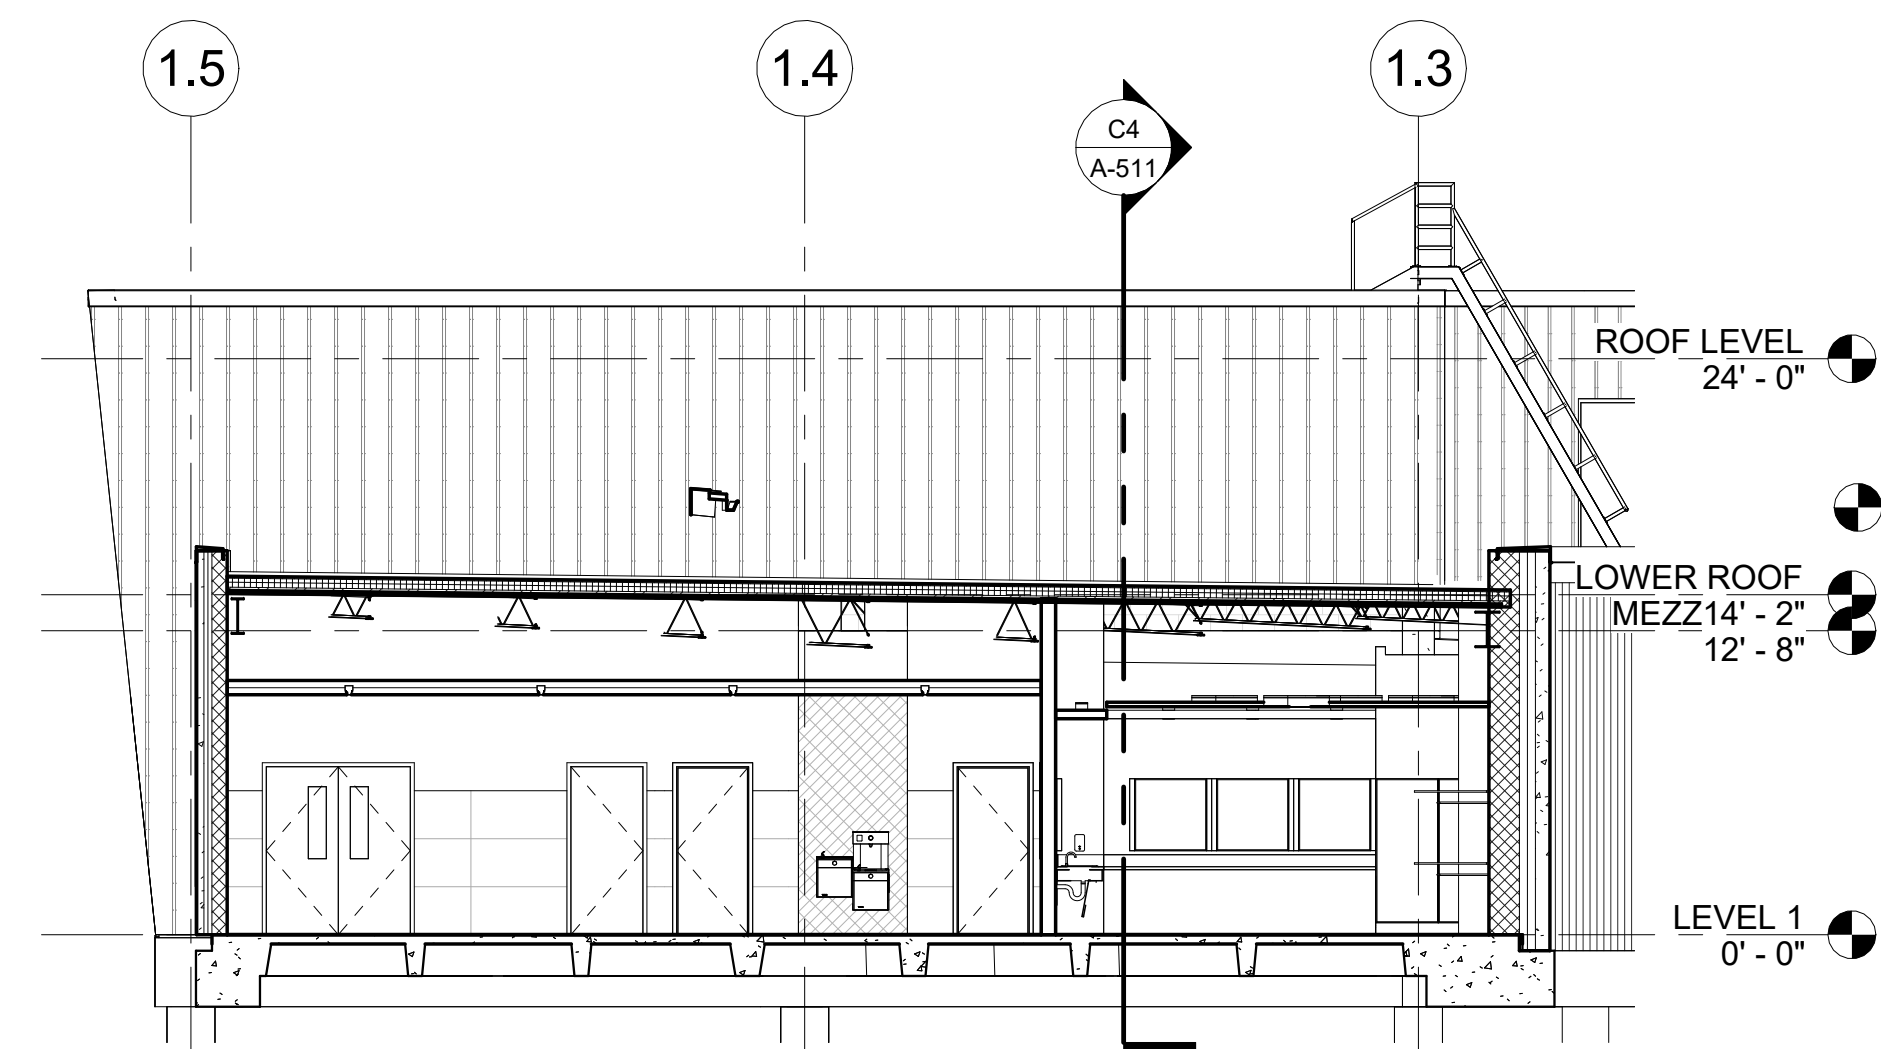


B4
A-511

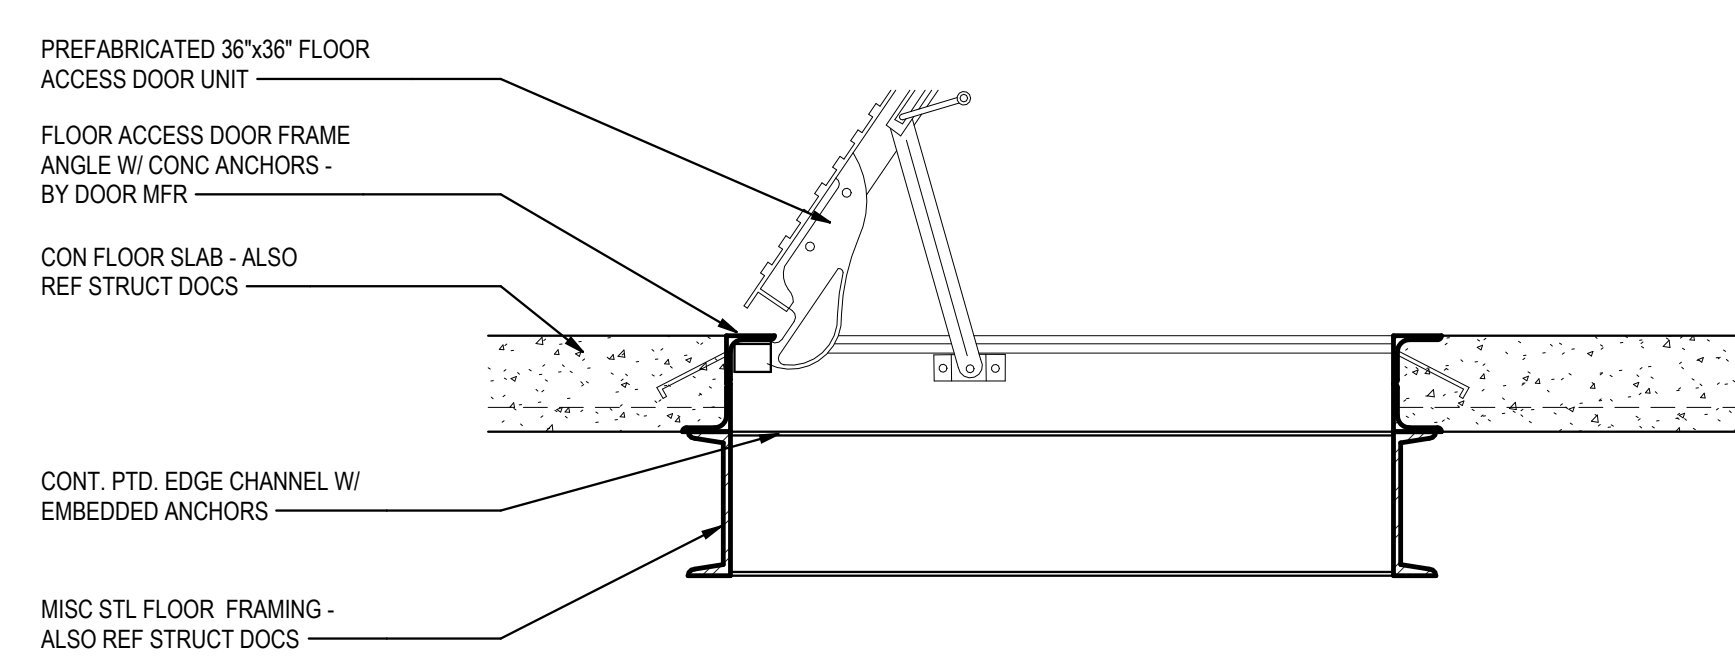

FLOOR ACCESSHATCH - CONCRETE

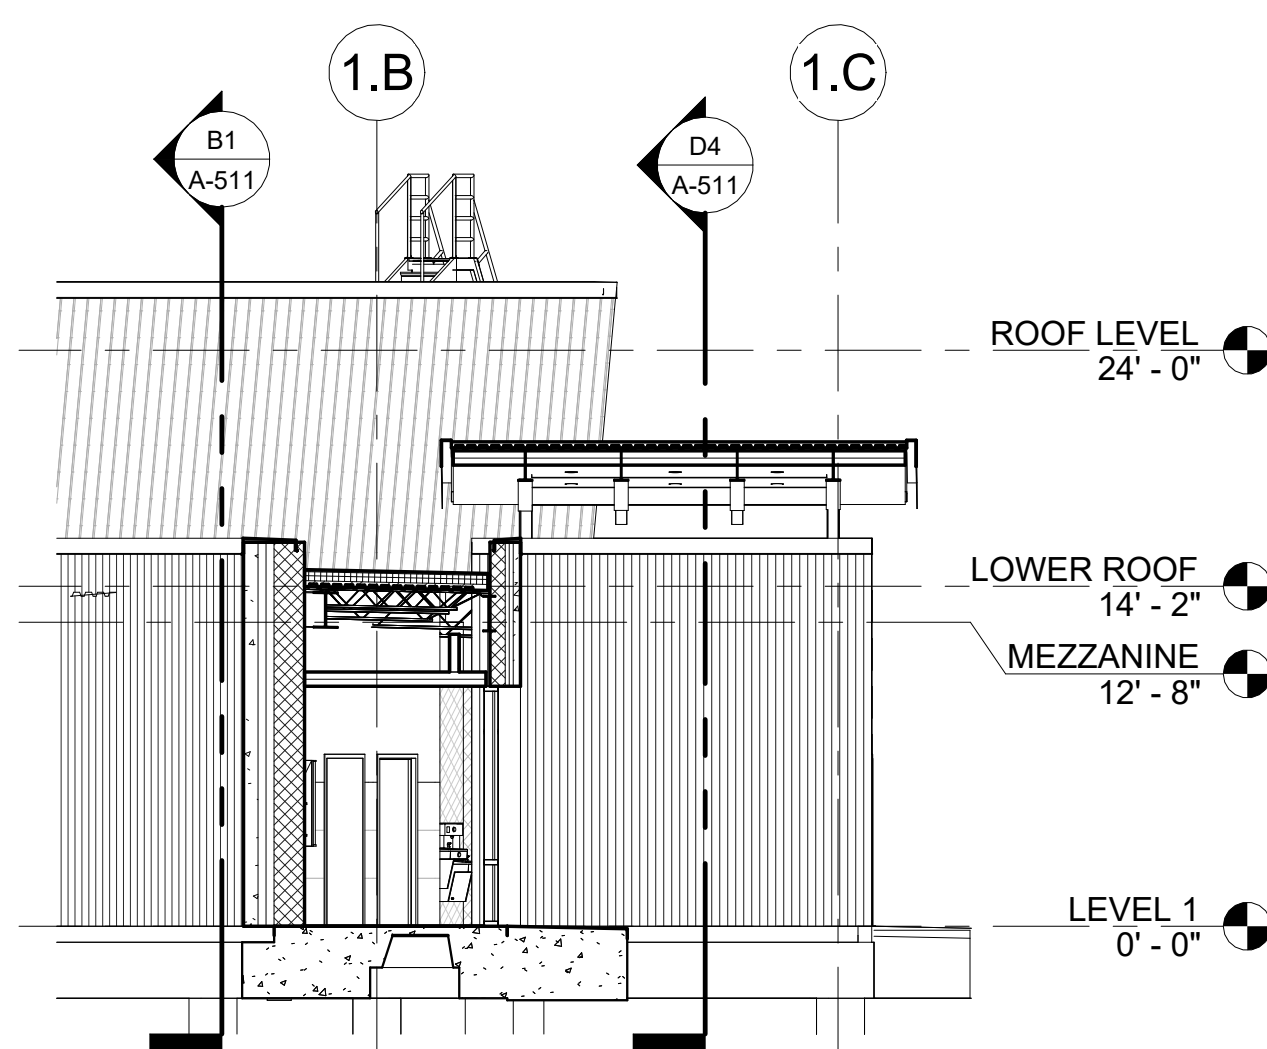


A4 **BUILDING SECTION**
A-511 1/8" = 1'-0"

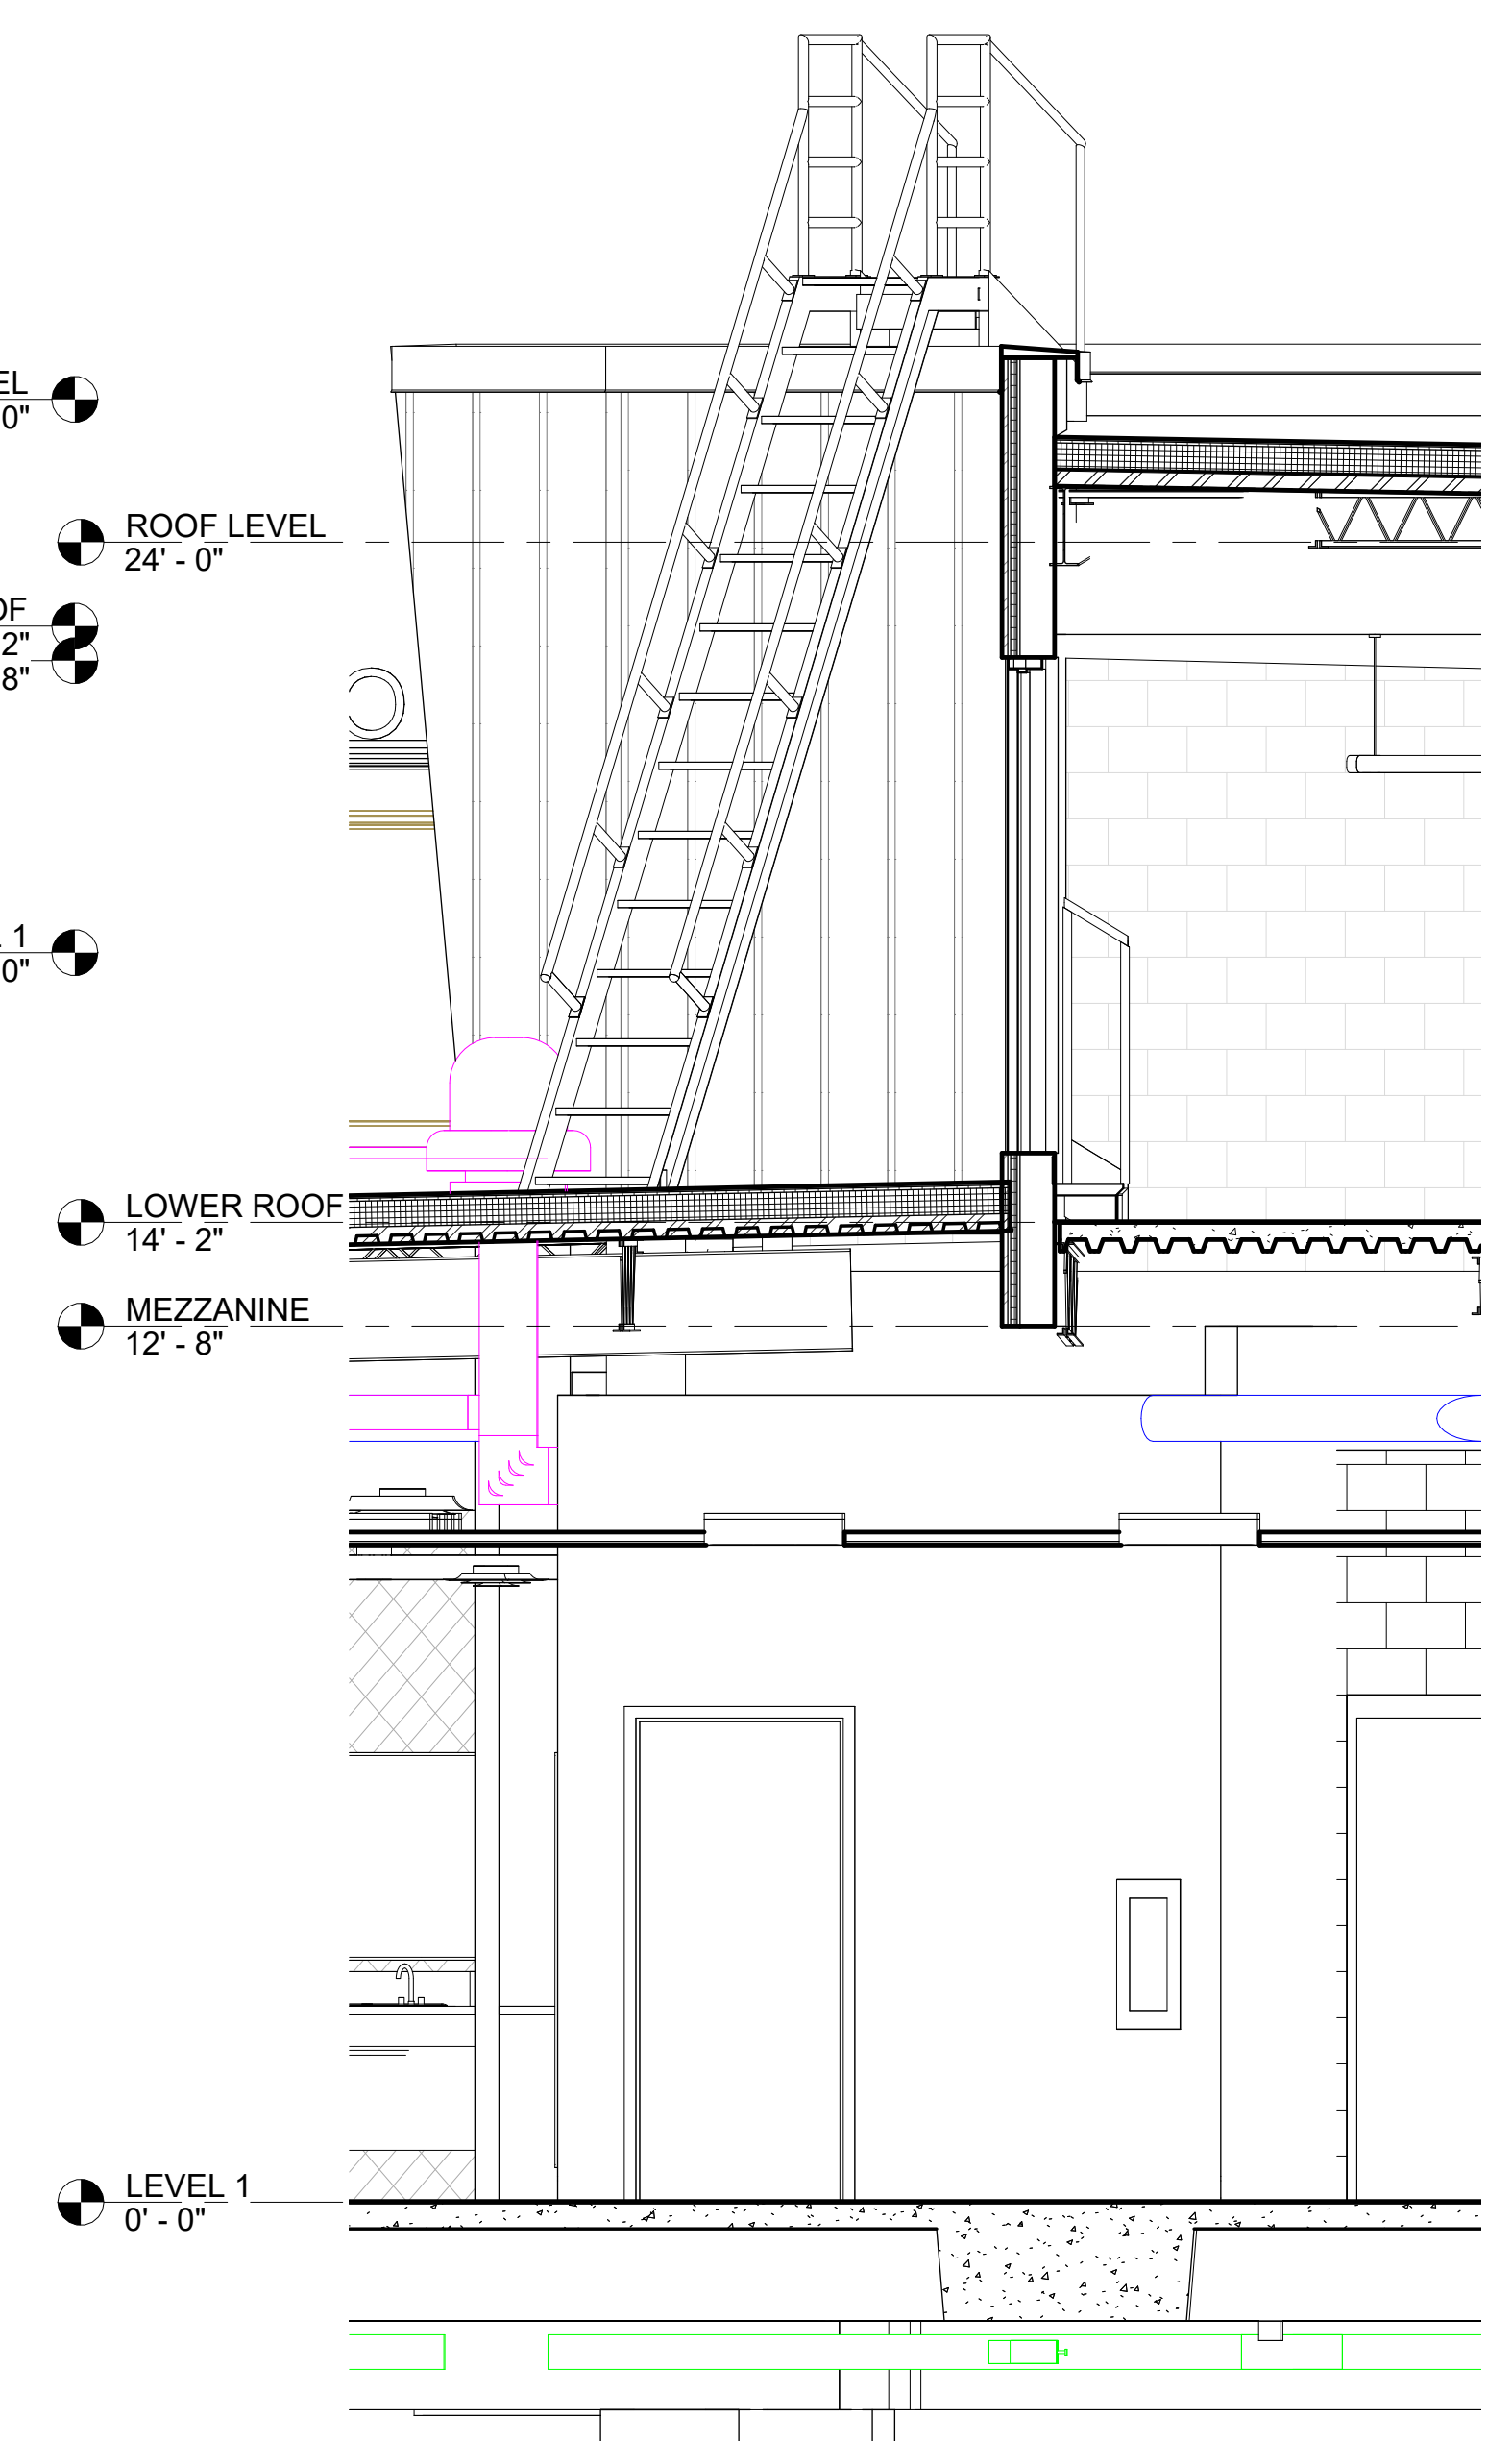


A6 WALL SECTION - MEZZ TO ROOF

8/22/2024 2:30:27 PM


ORIGINAL SHEET - ARCHITECT

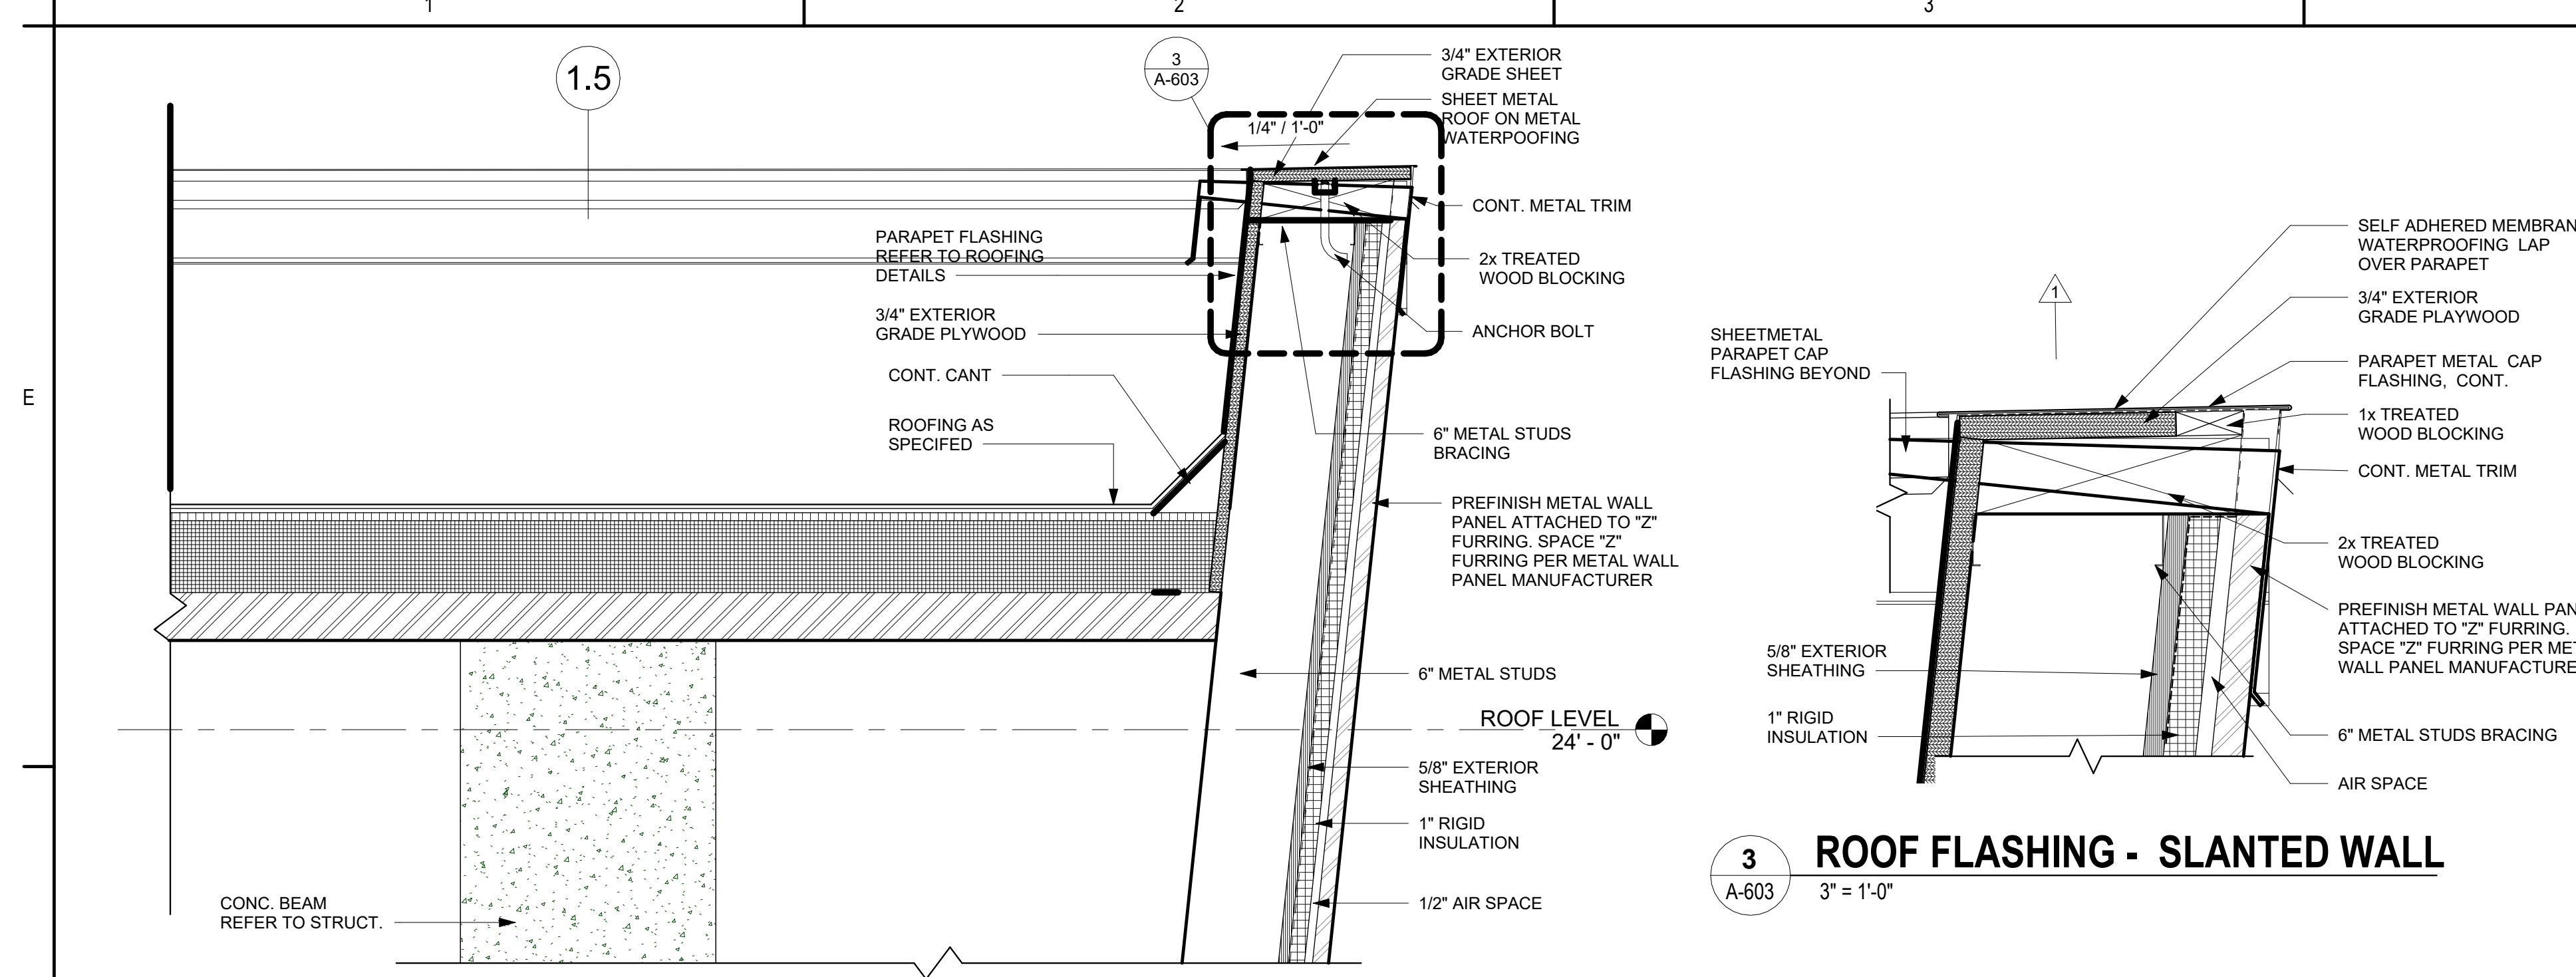


3 ROOF FLASHING - SLANTED WALL
A-603 3\"/>

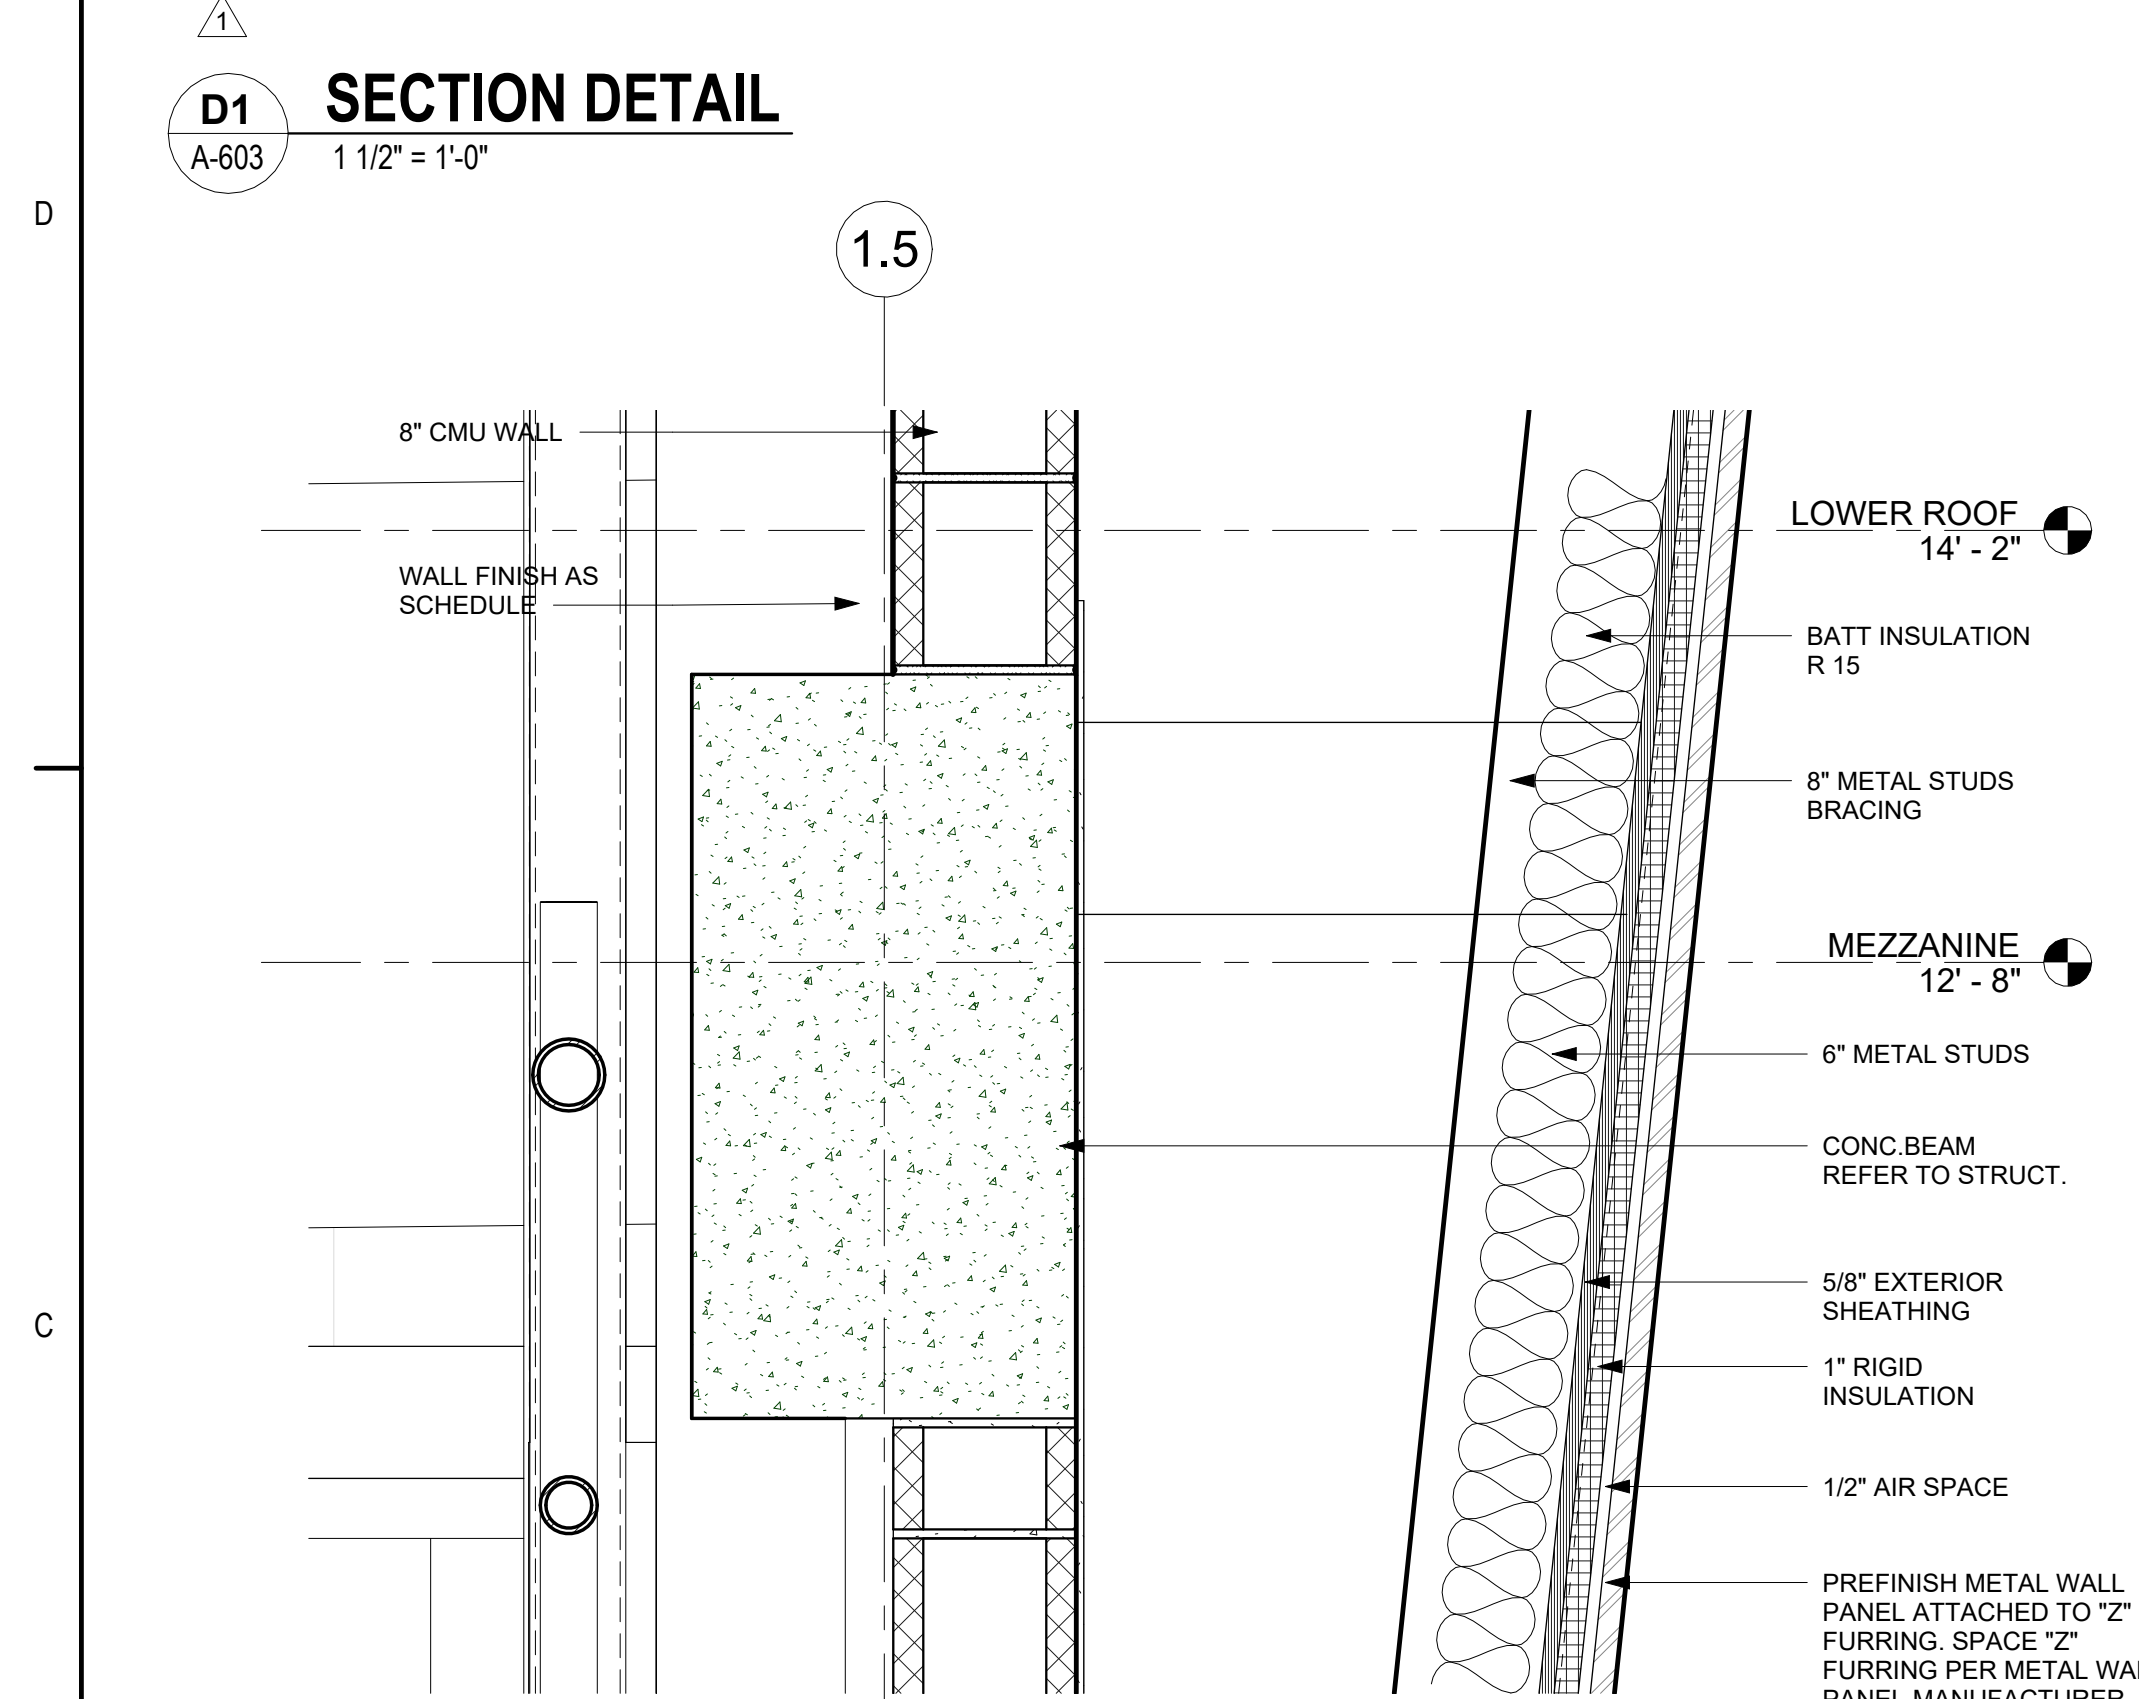


D1 SECTION DETAIL
A-603 1 1/2\"/>

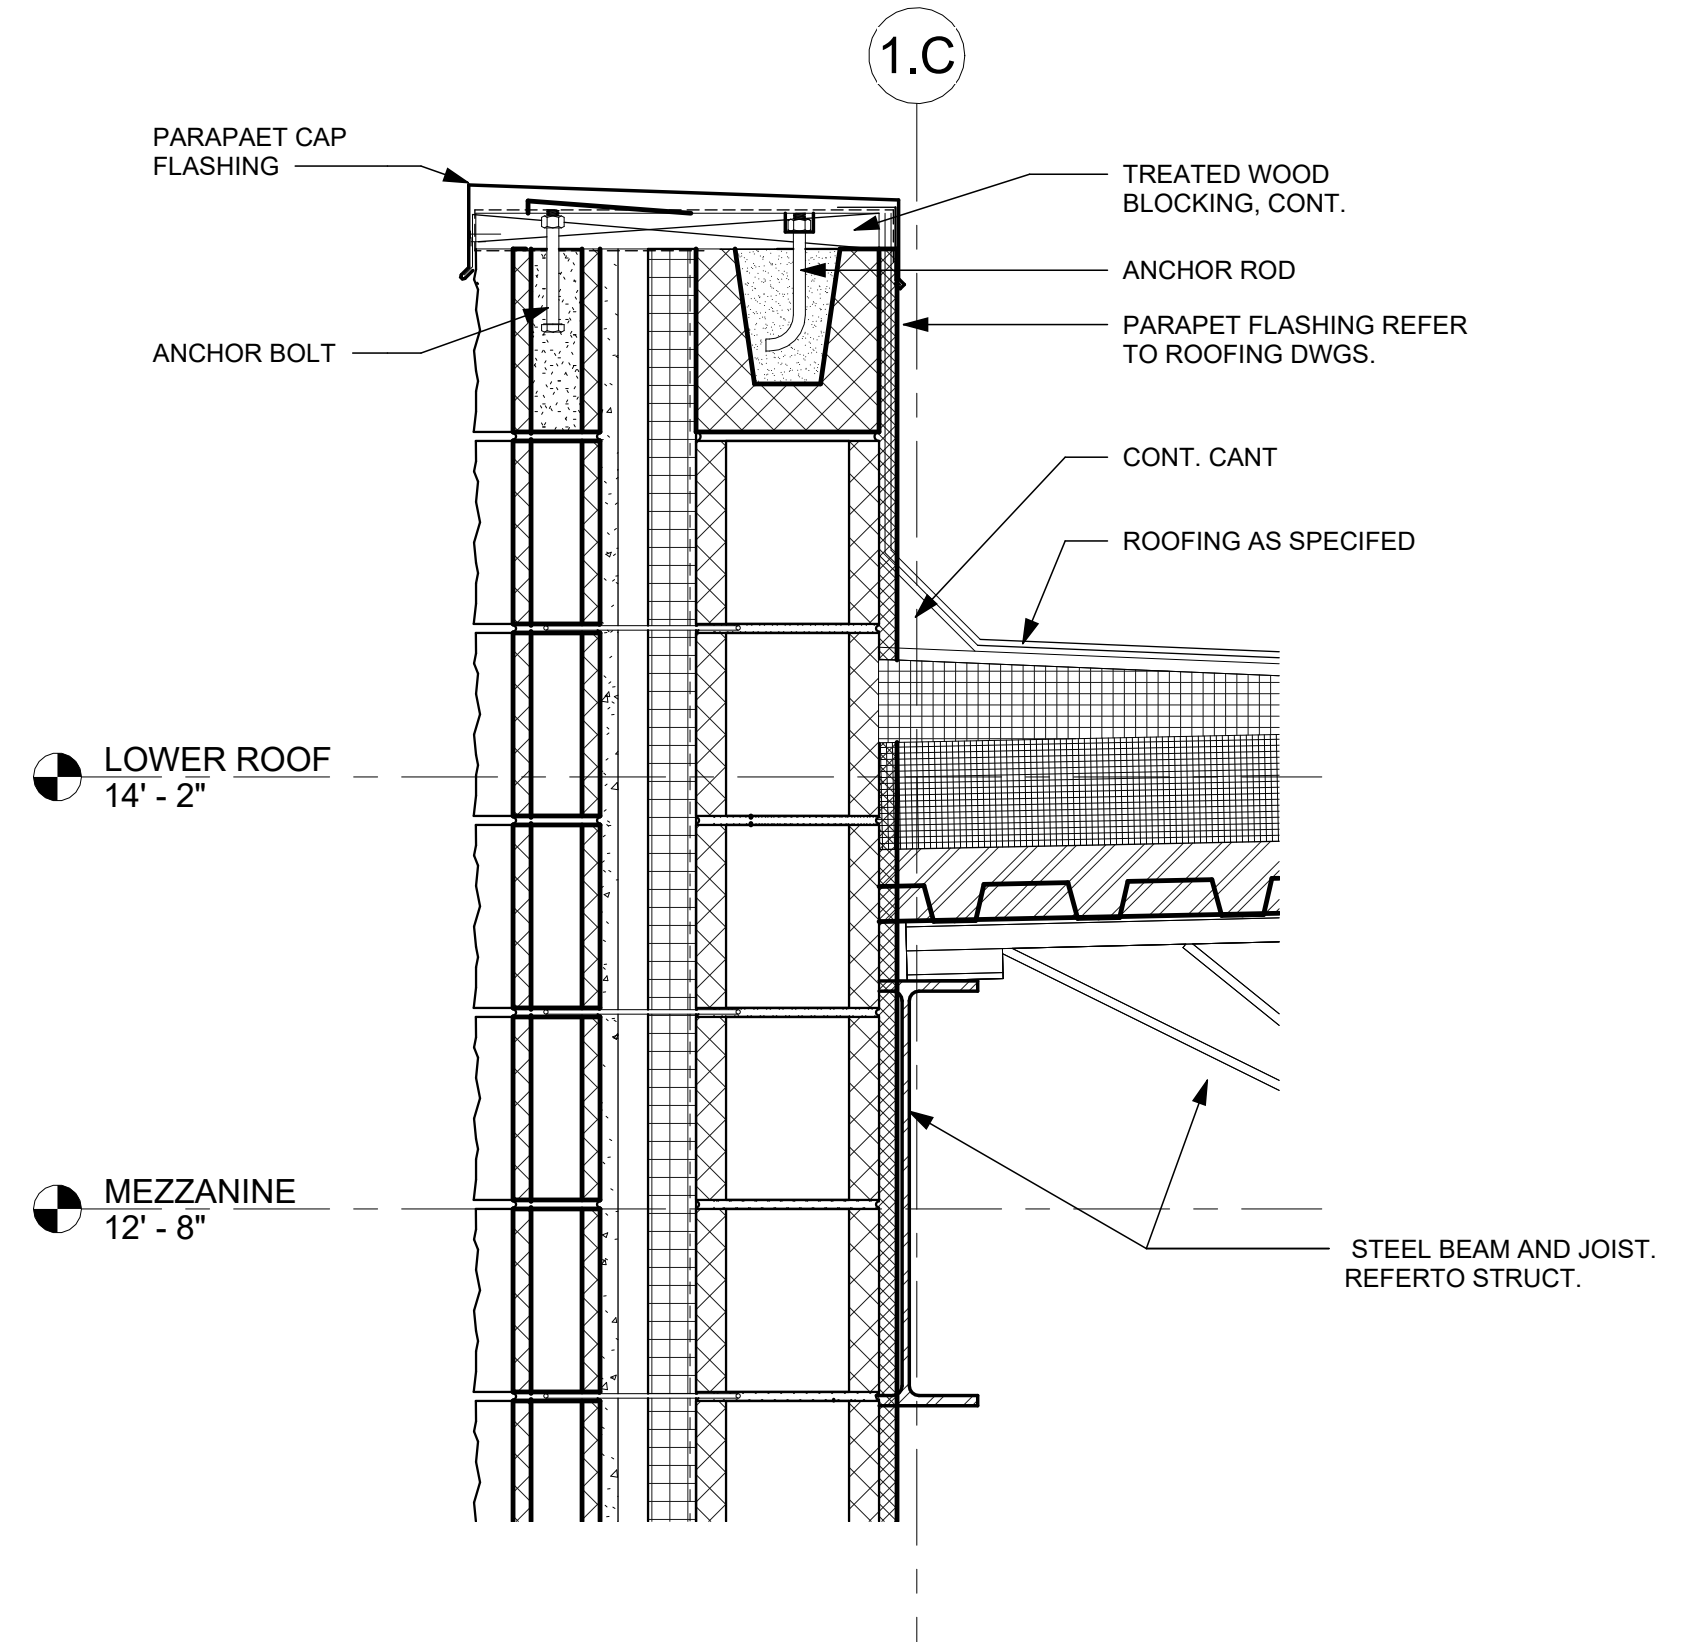


C3 SECTION DETAIL
A-603 1 1/2\"/>

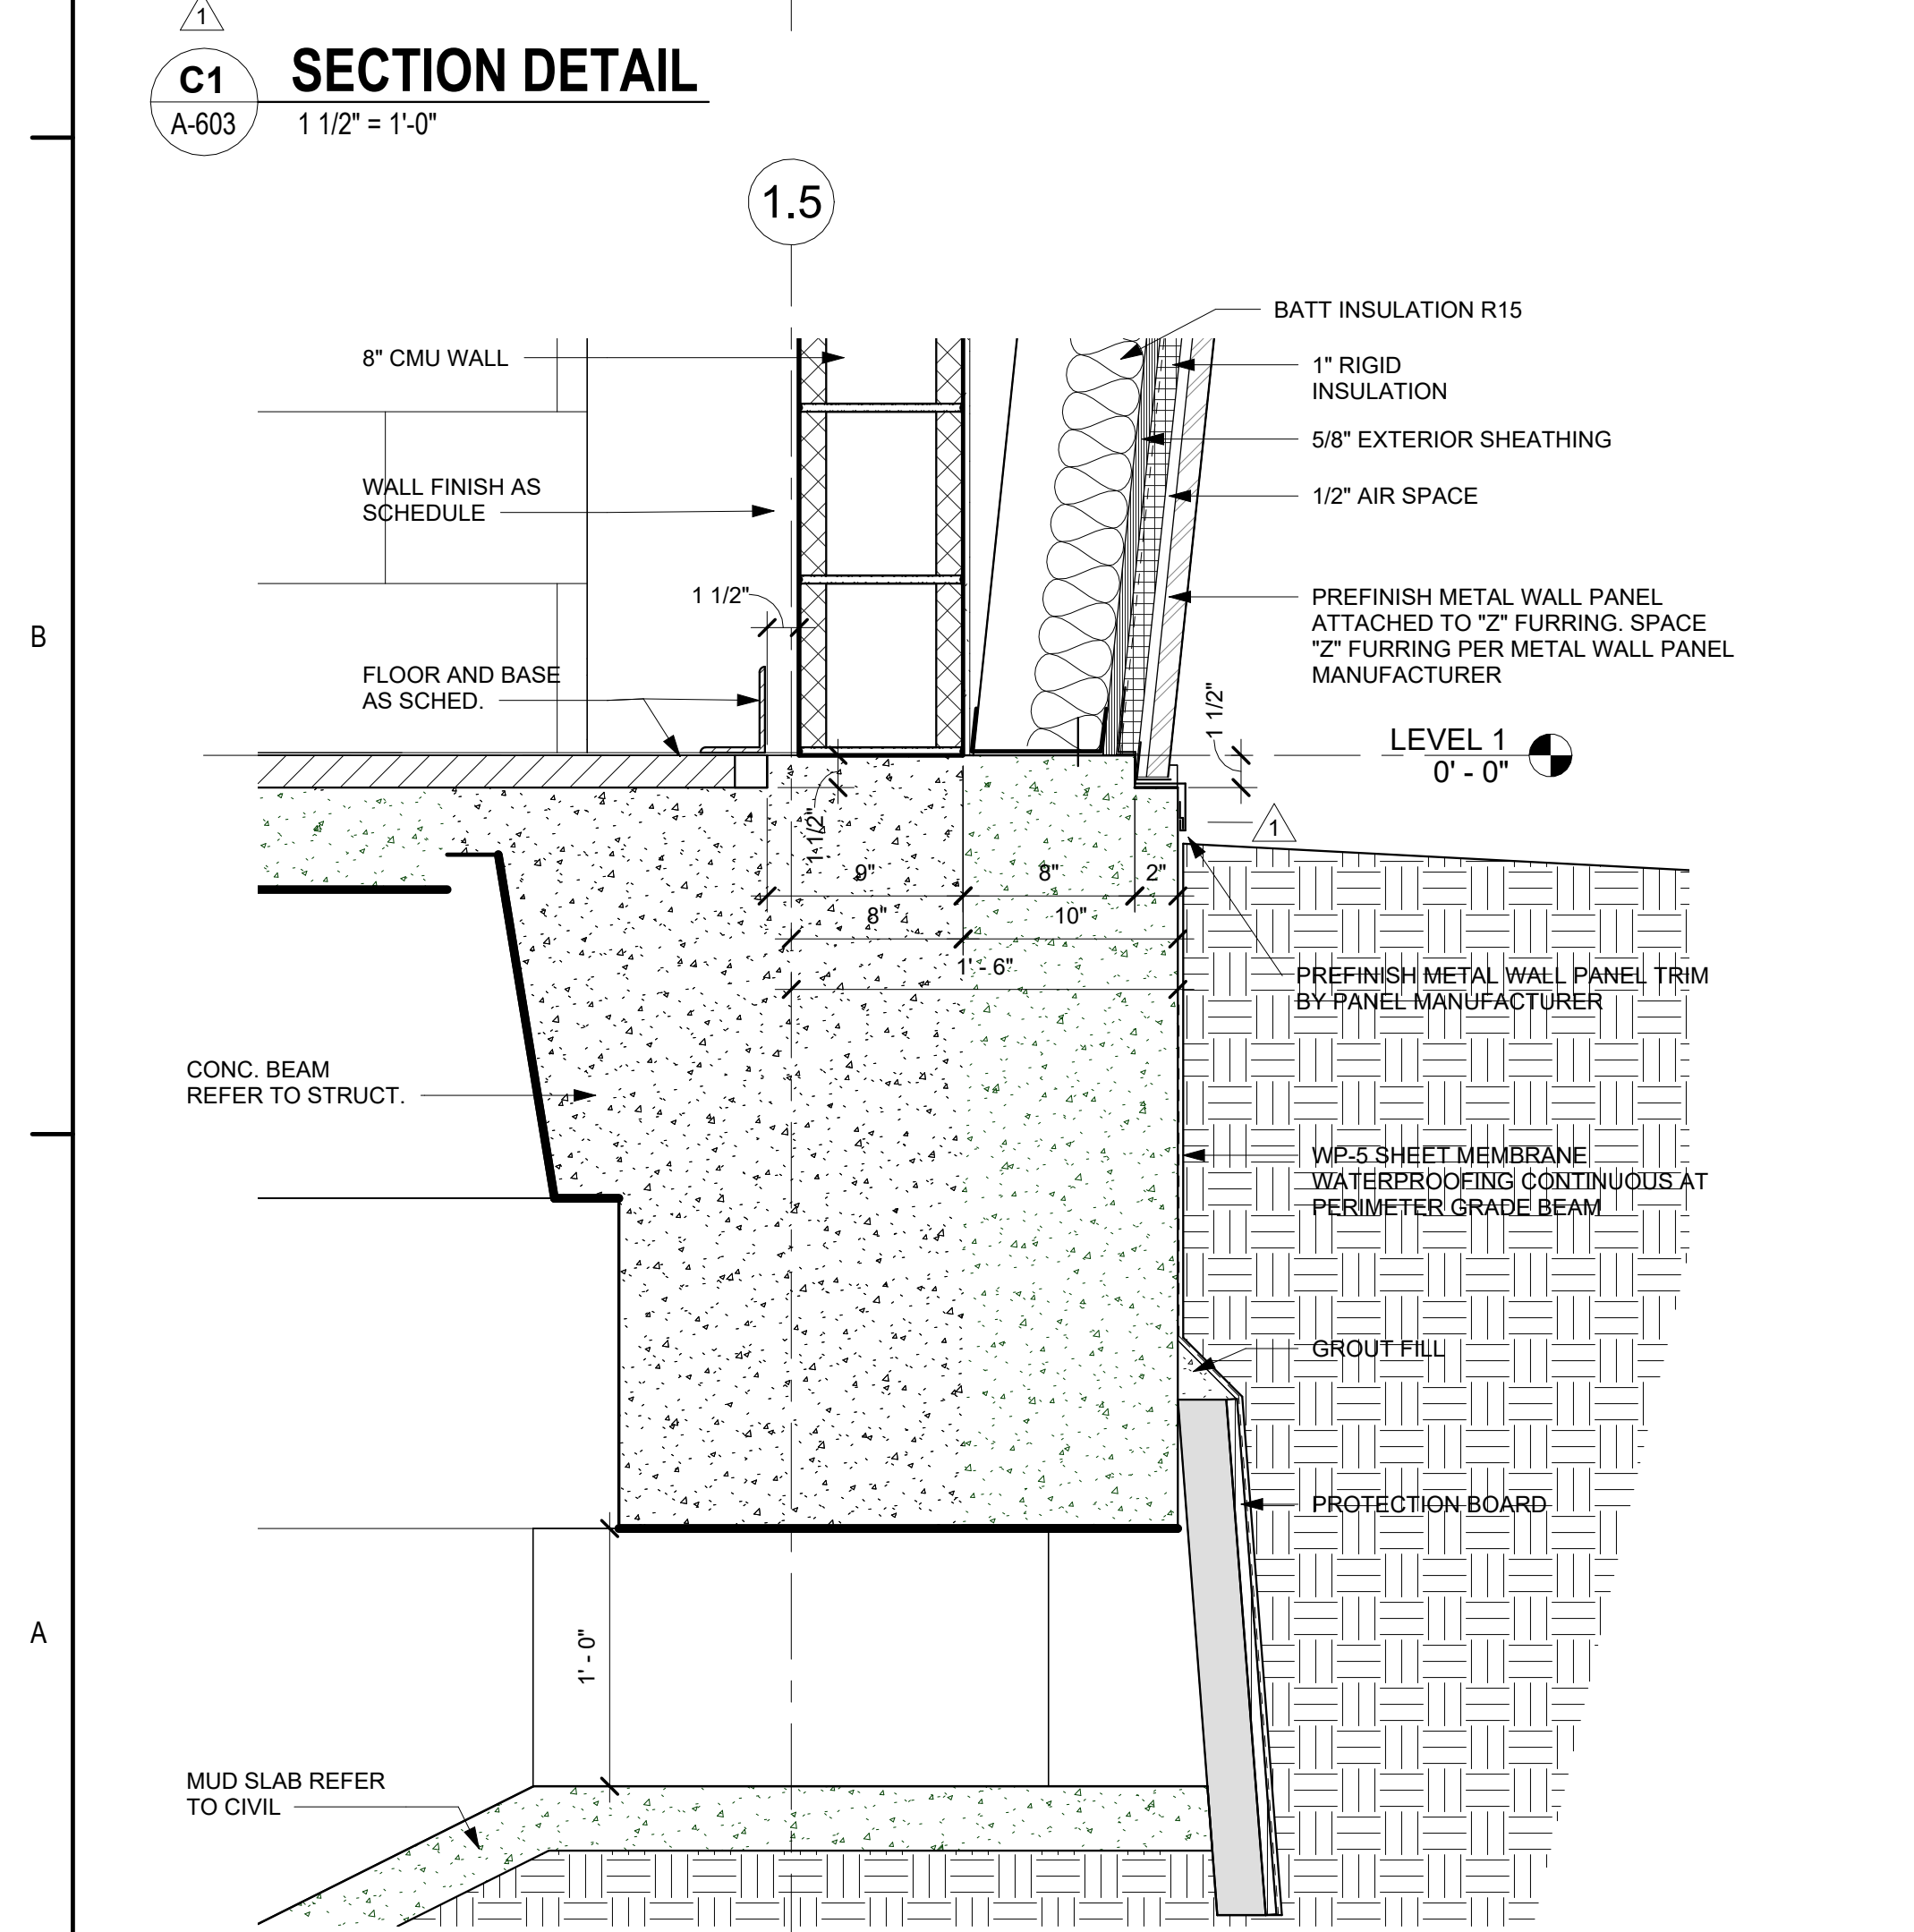


C1 SECTION DETAIL
A-603 1 1/2\"/>

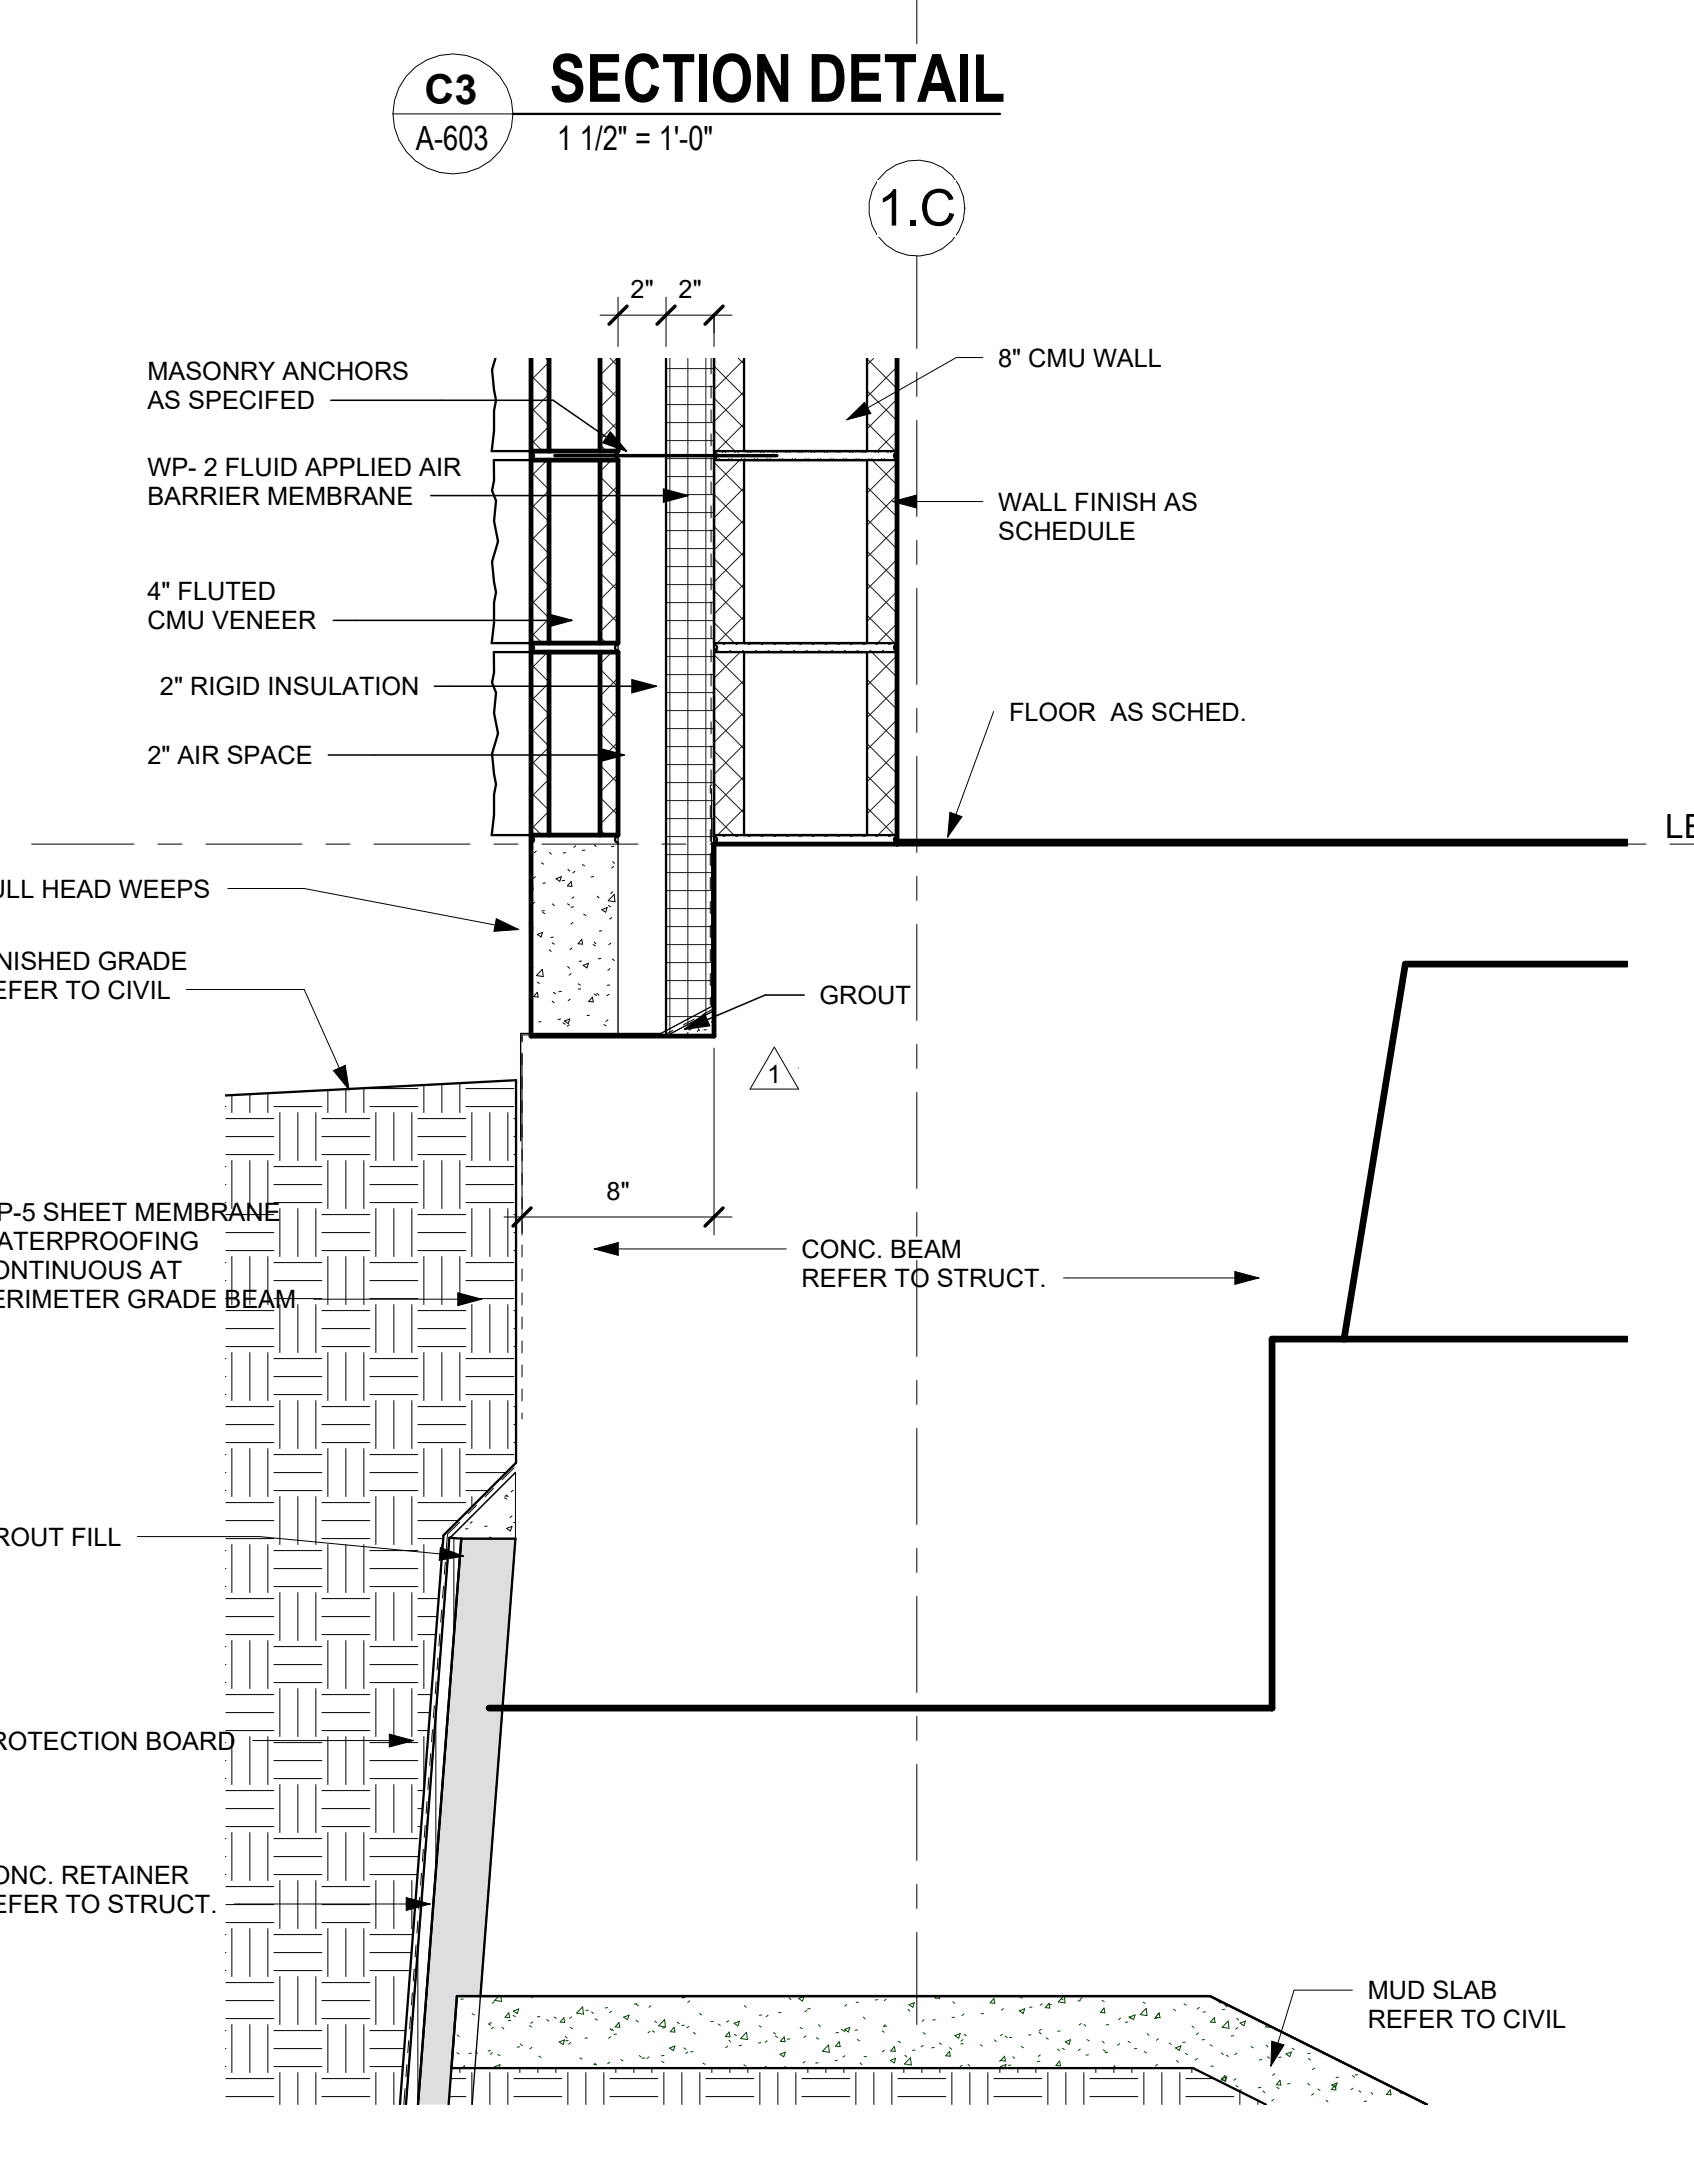


A3 SECTION DETAIL
A-603 1 1/2\"/>

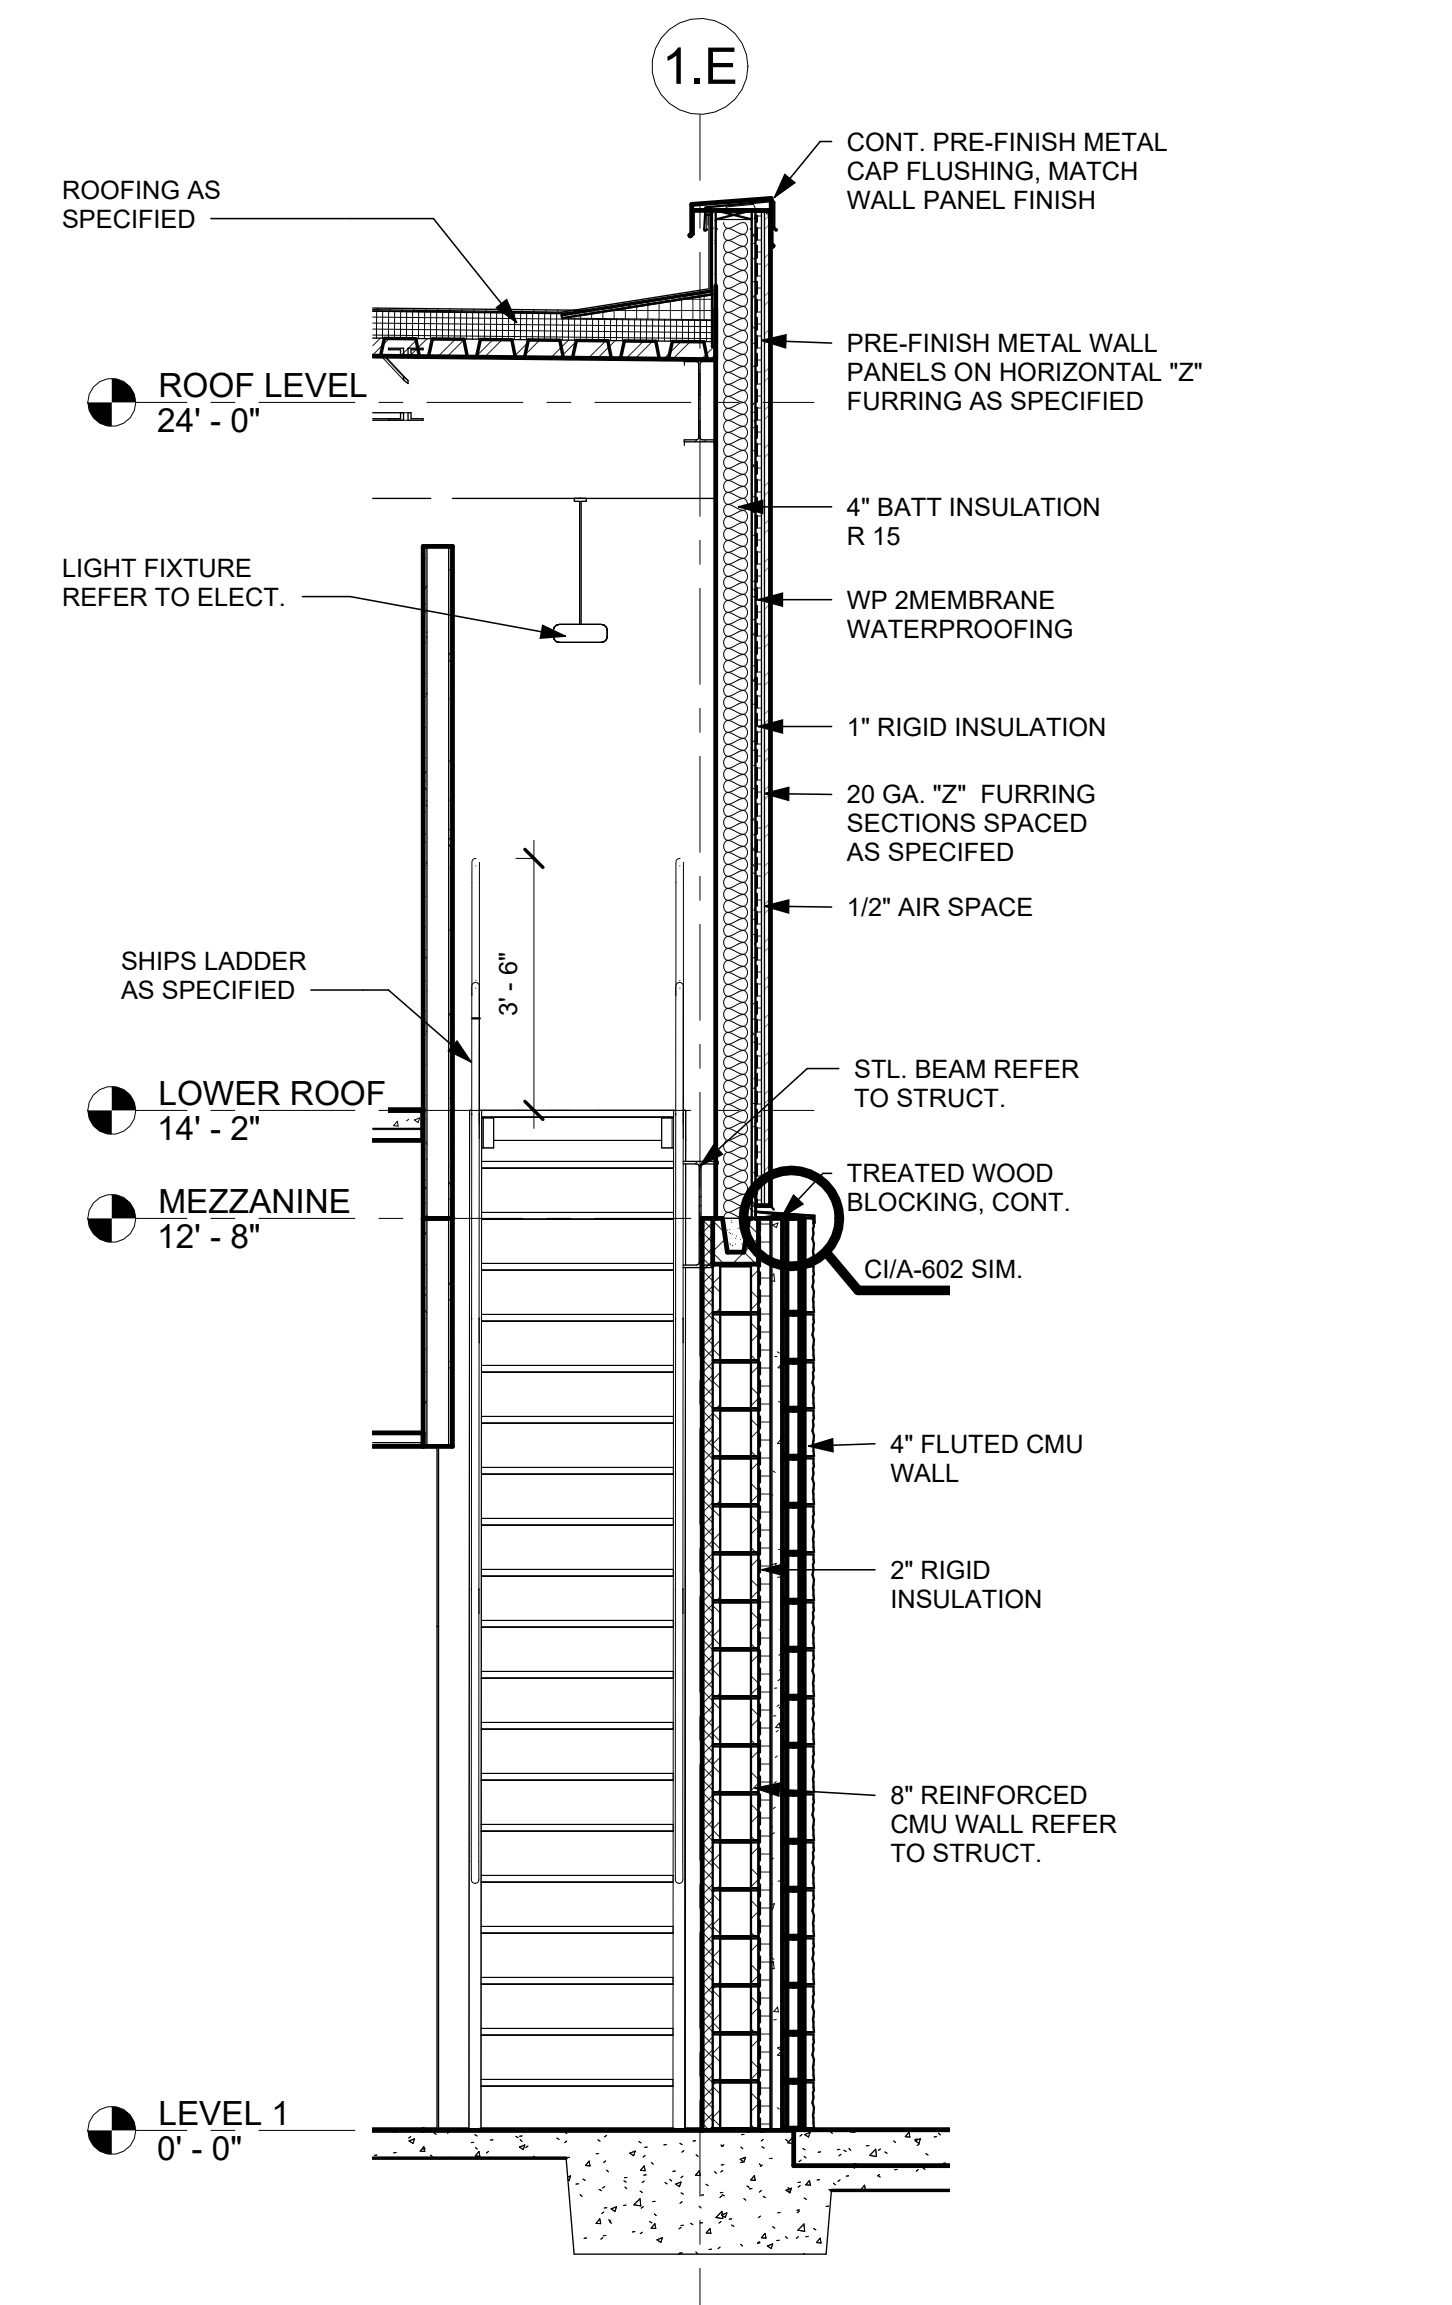


2 WALL SECTION @ 1.E - BLACK BOX
A-603 3/8\"/>

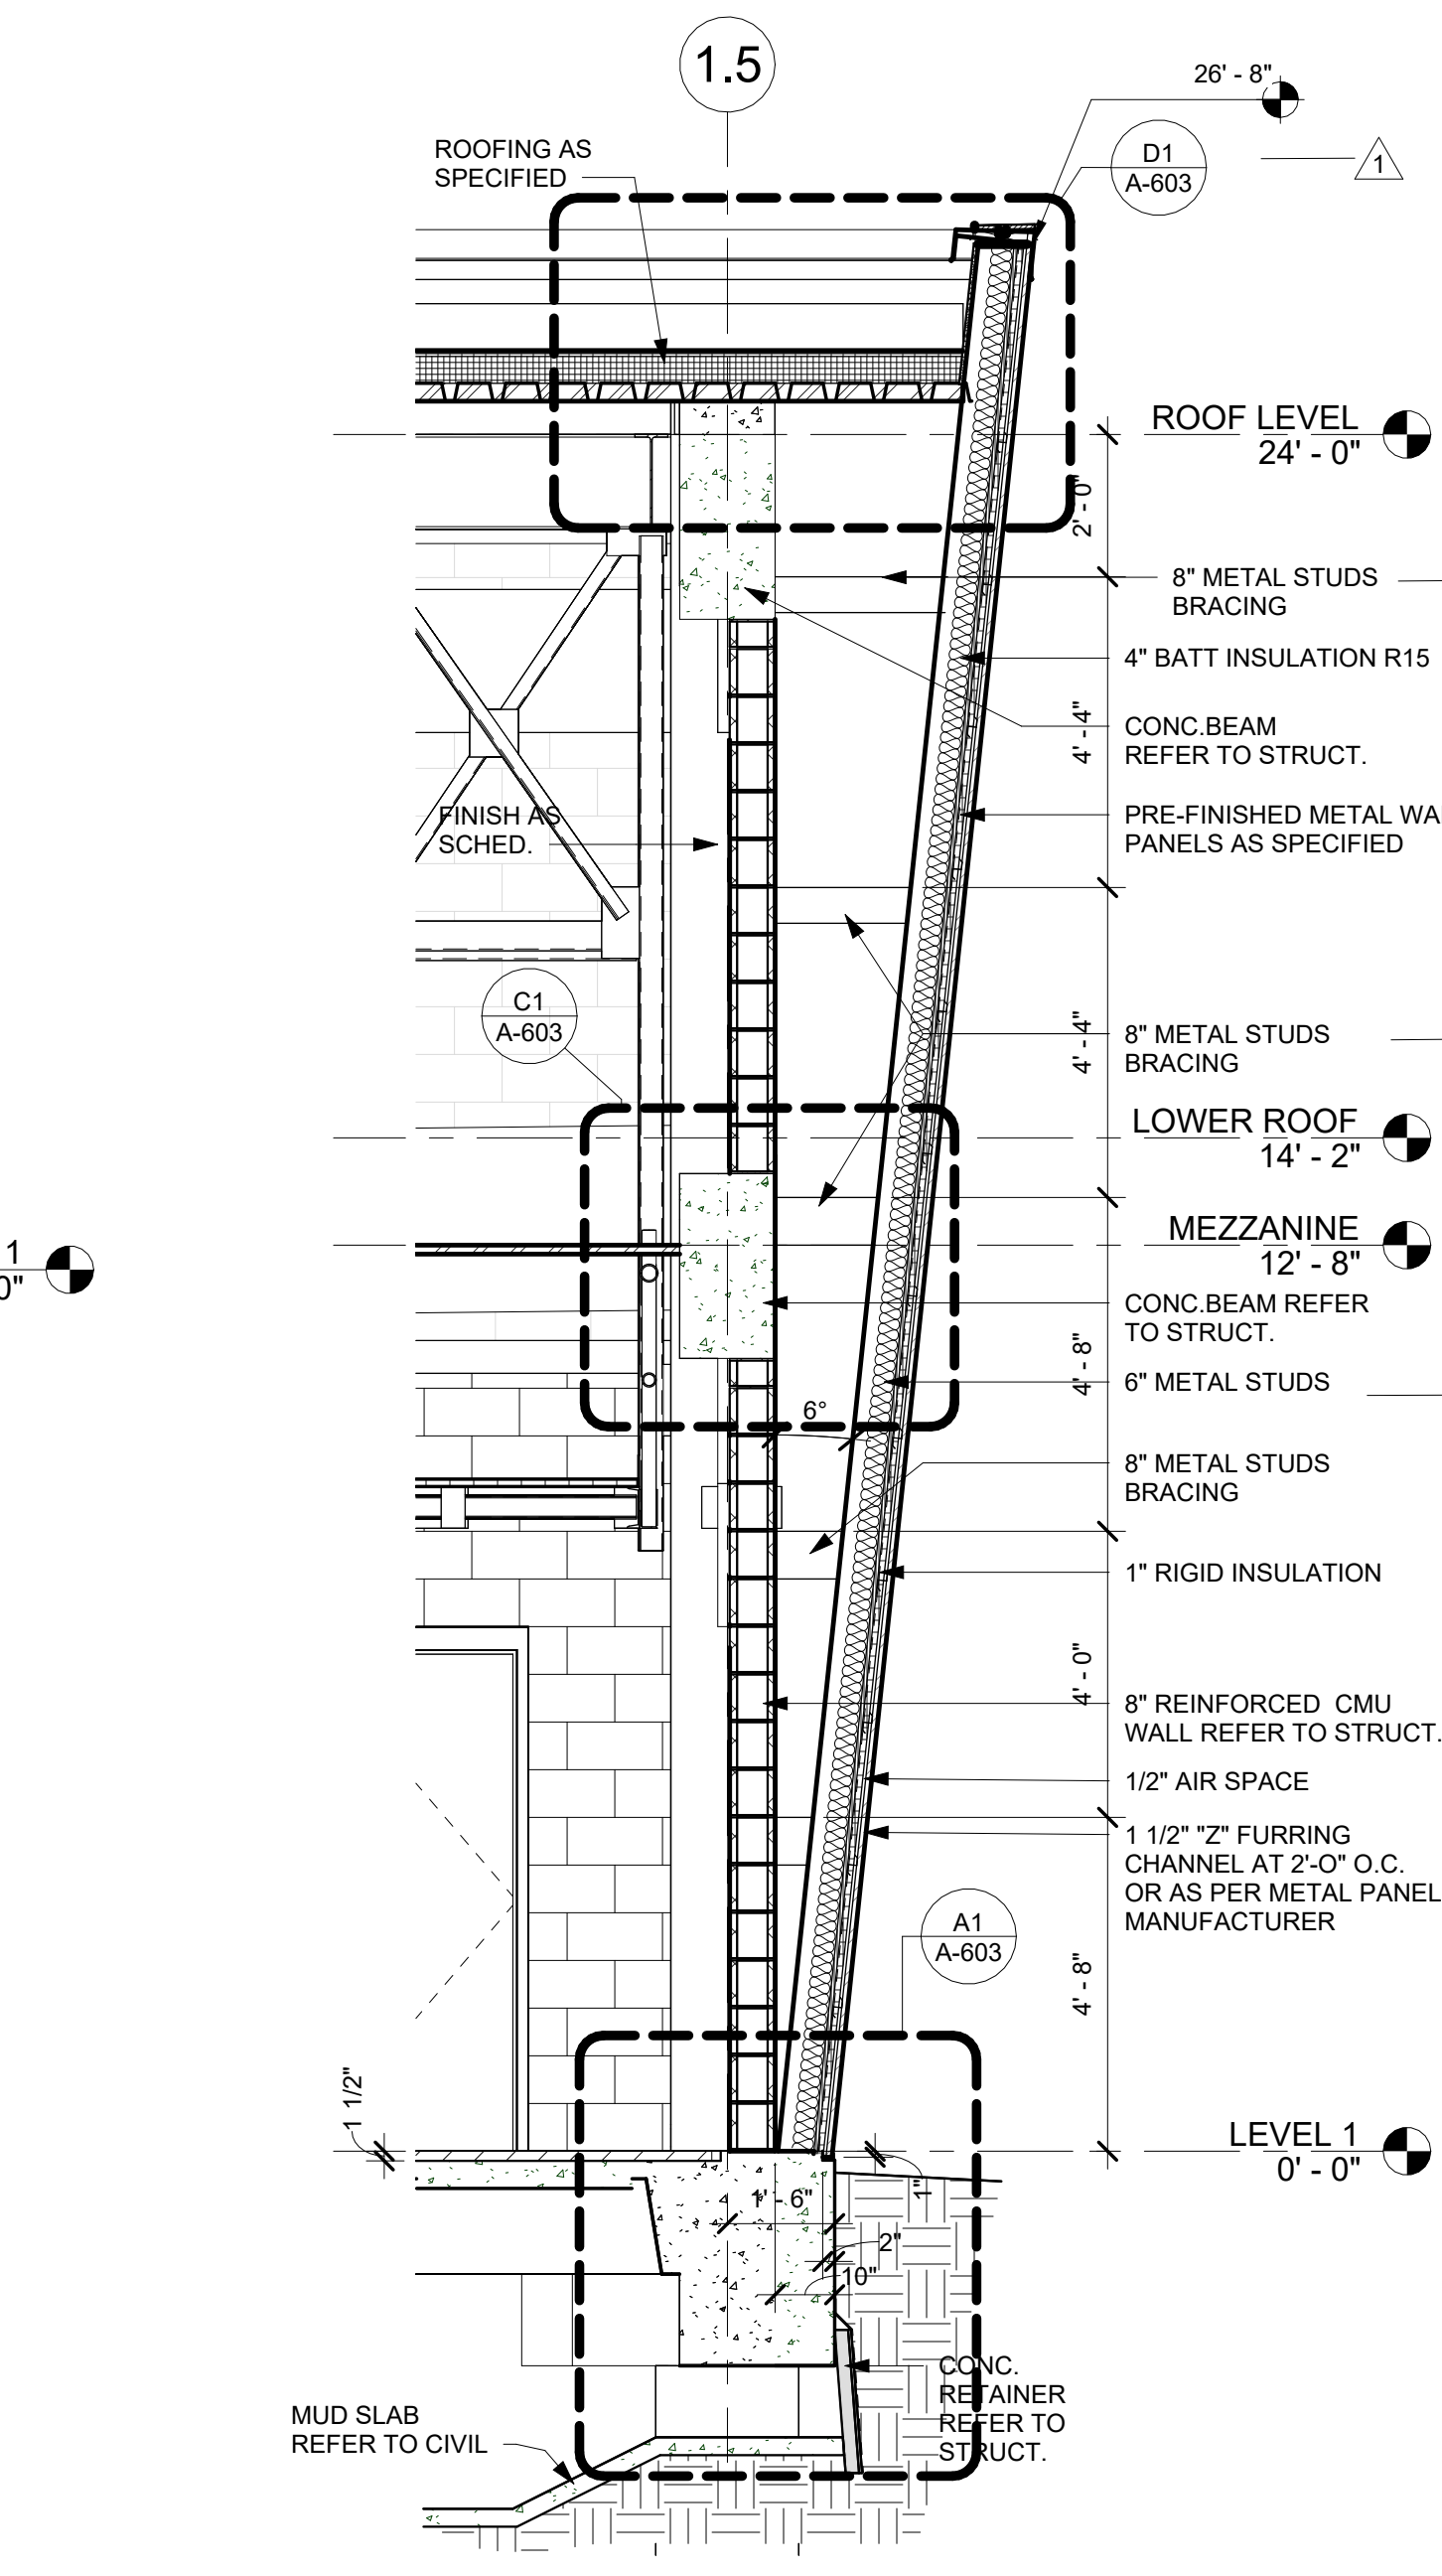

A5 WALL SECTION @ 1.5 - BLACK BOX
A-603 3/8\"/>

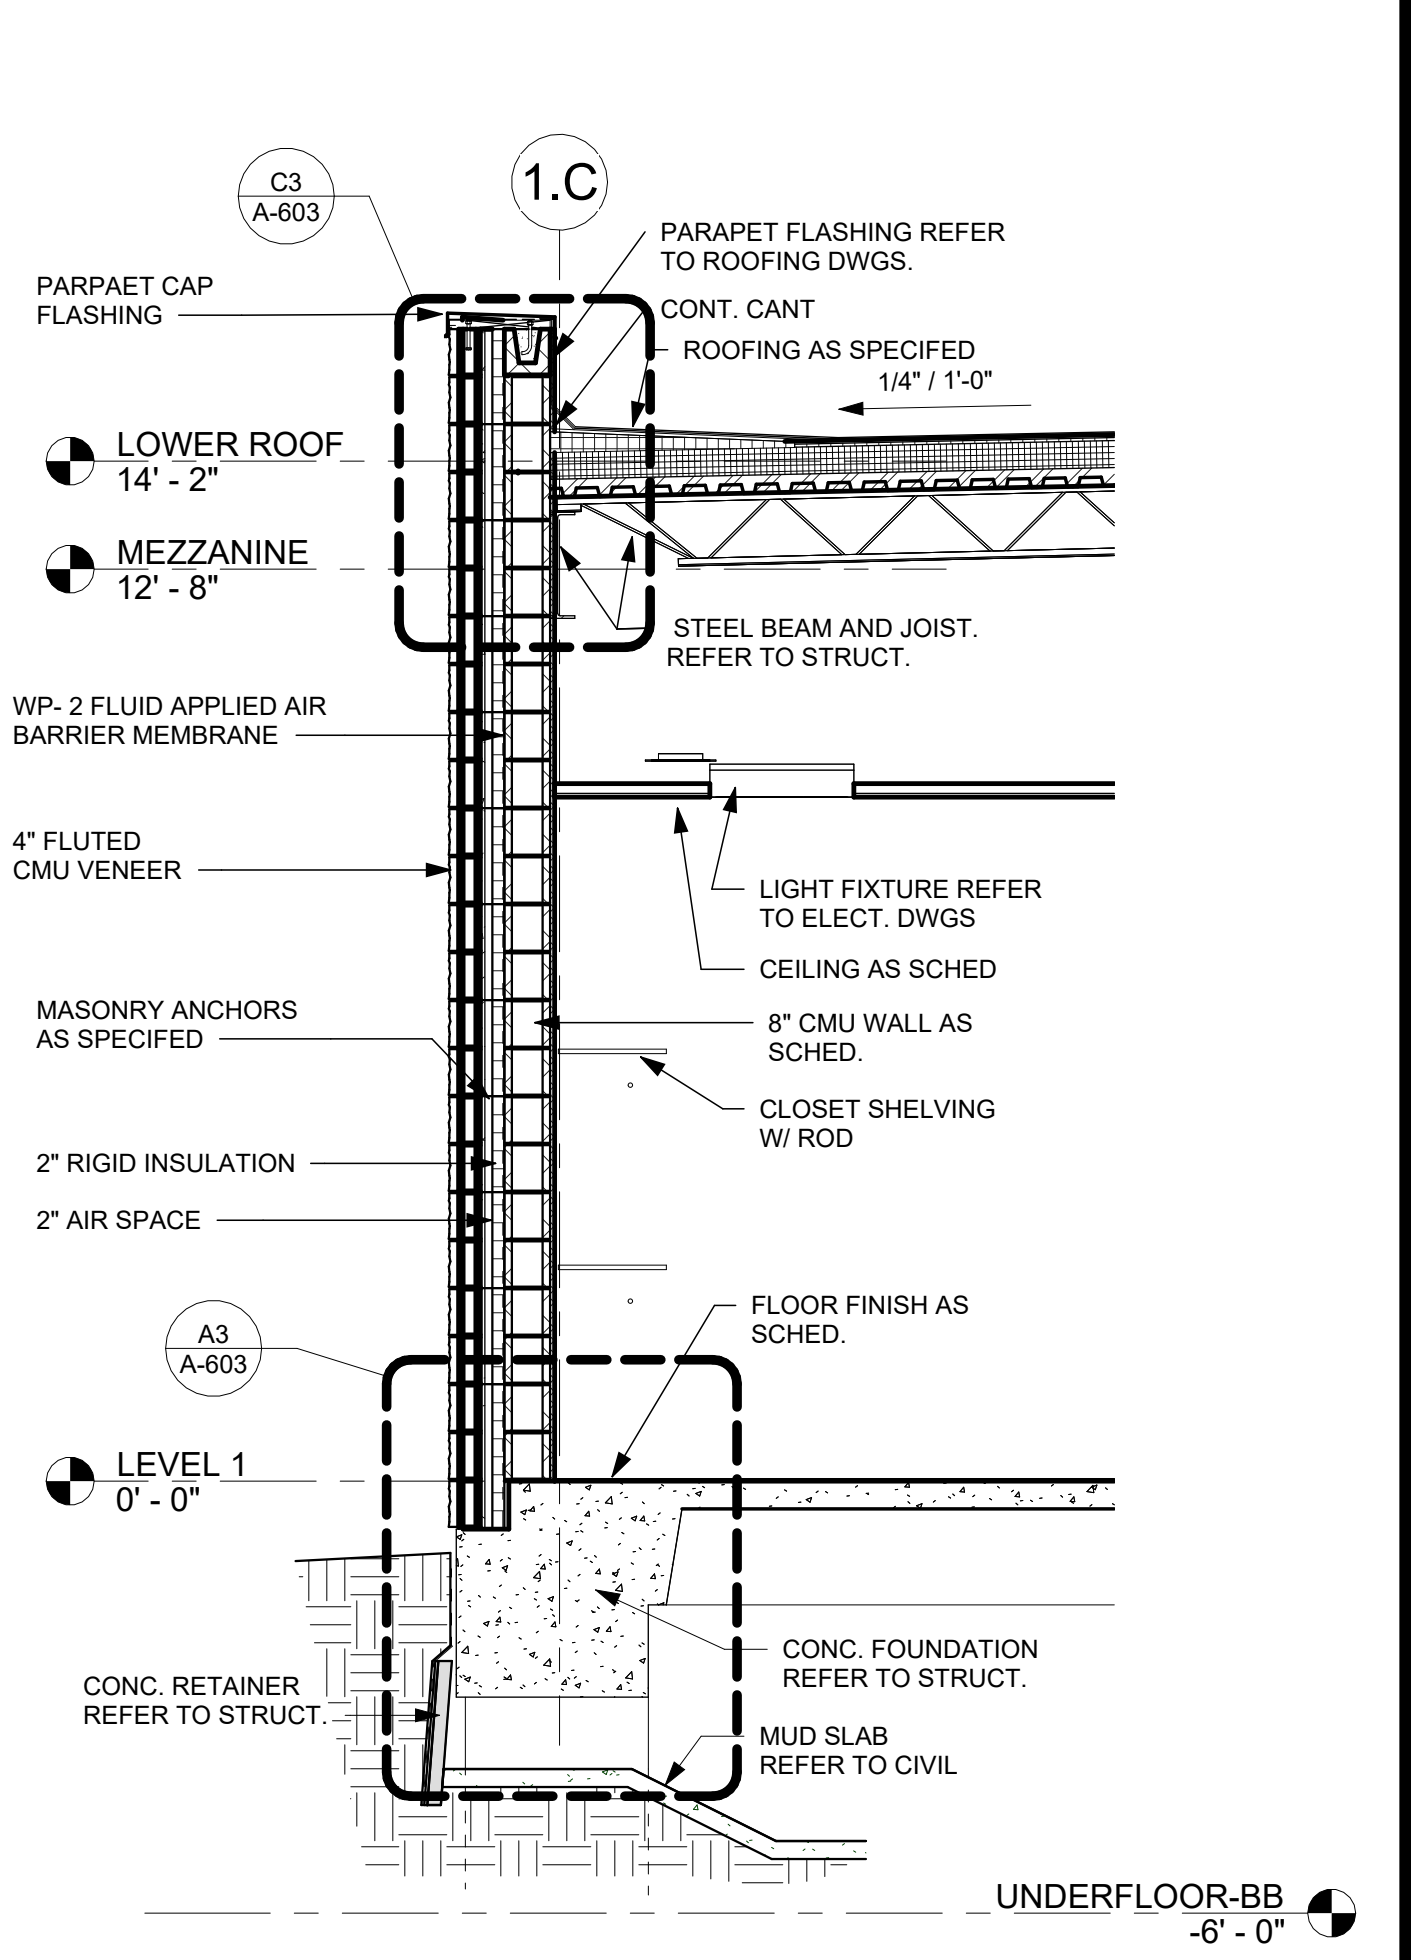

1 WALL SECTION
A-603 3/8\"/>

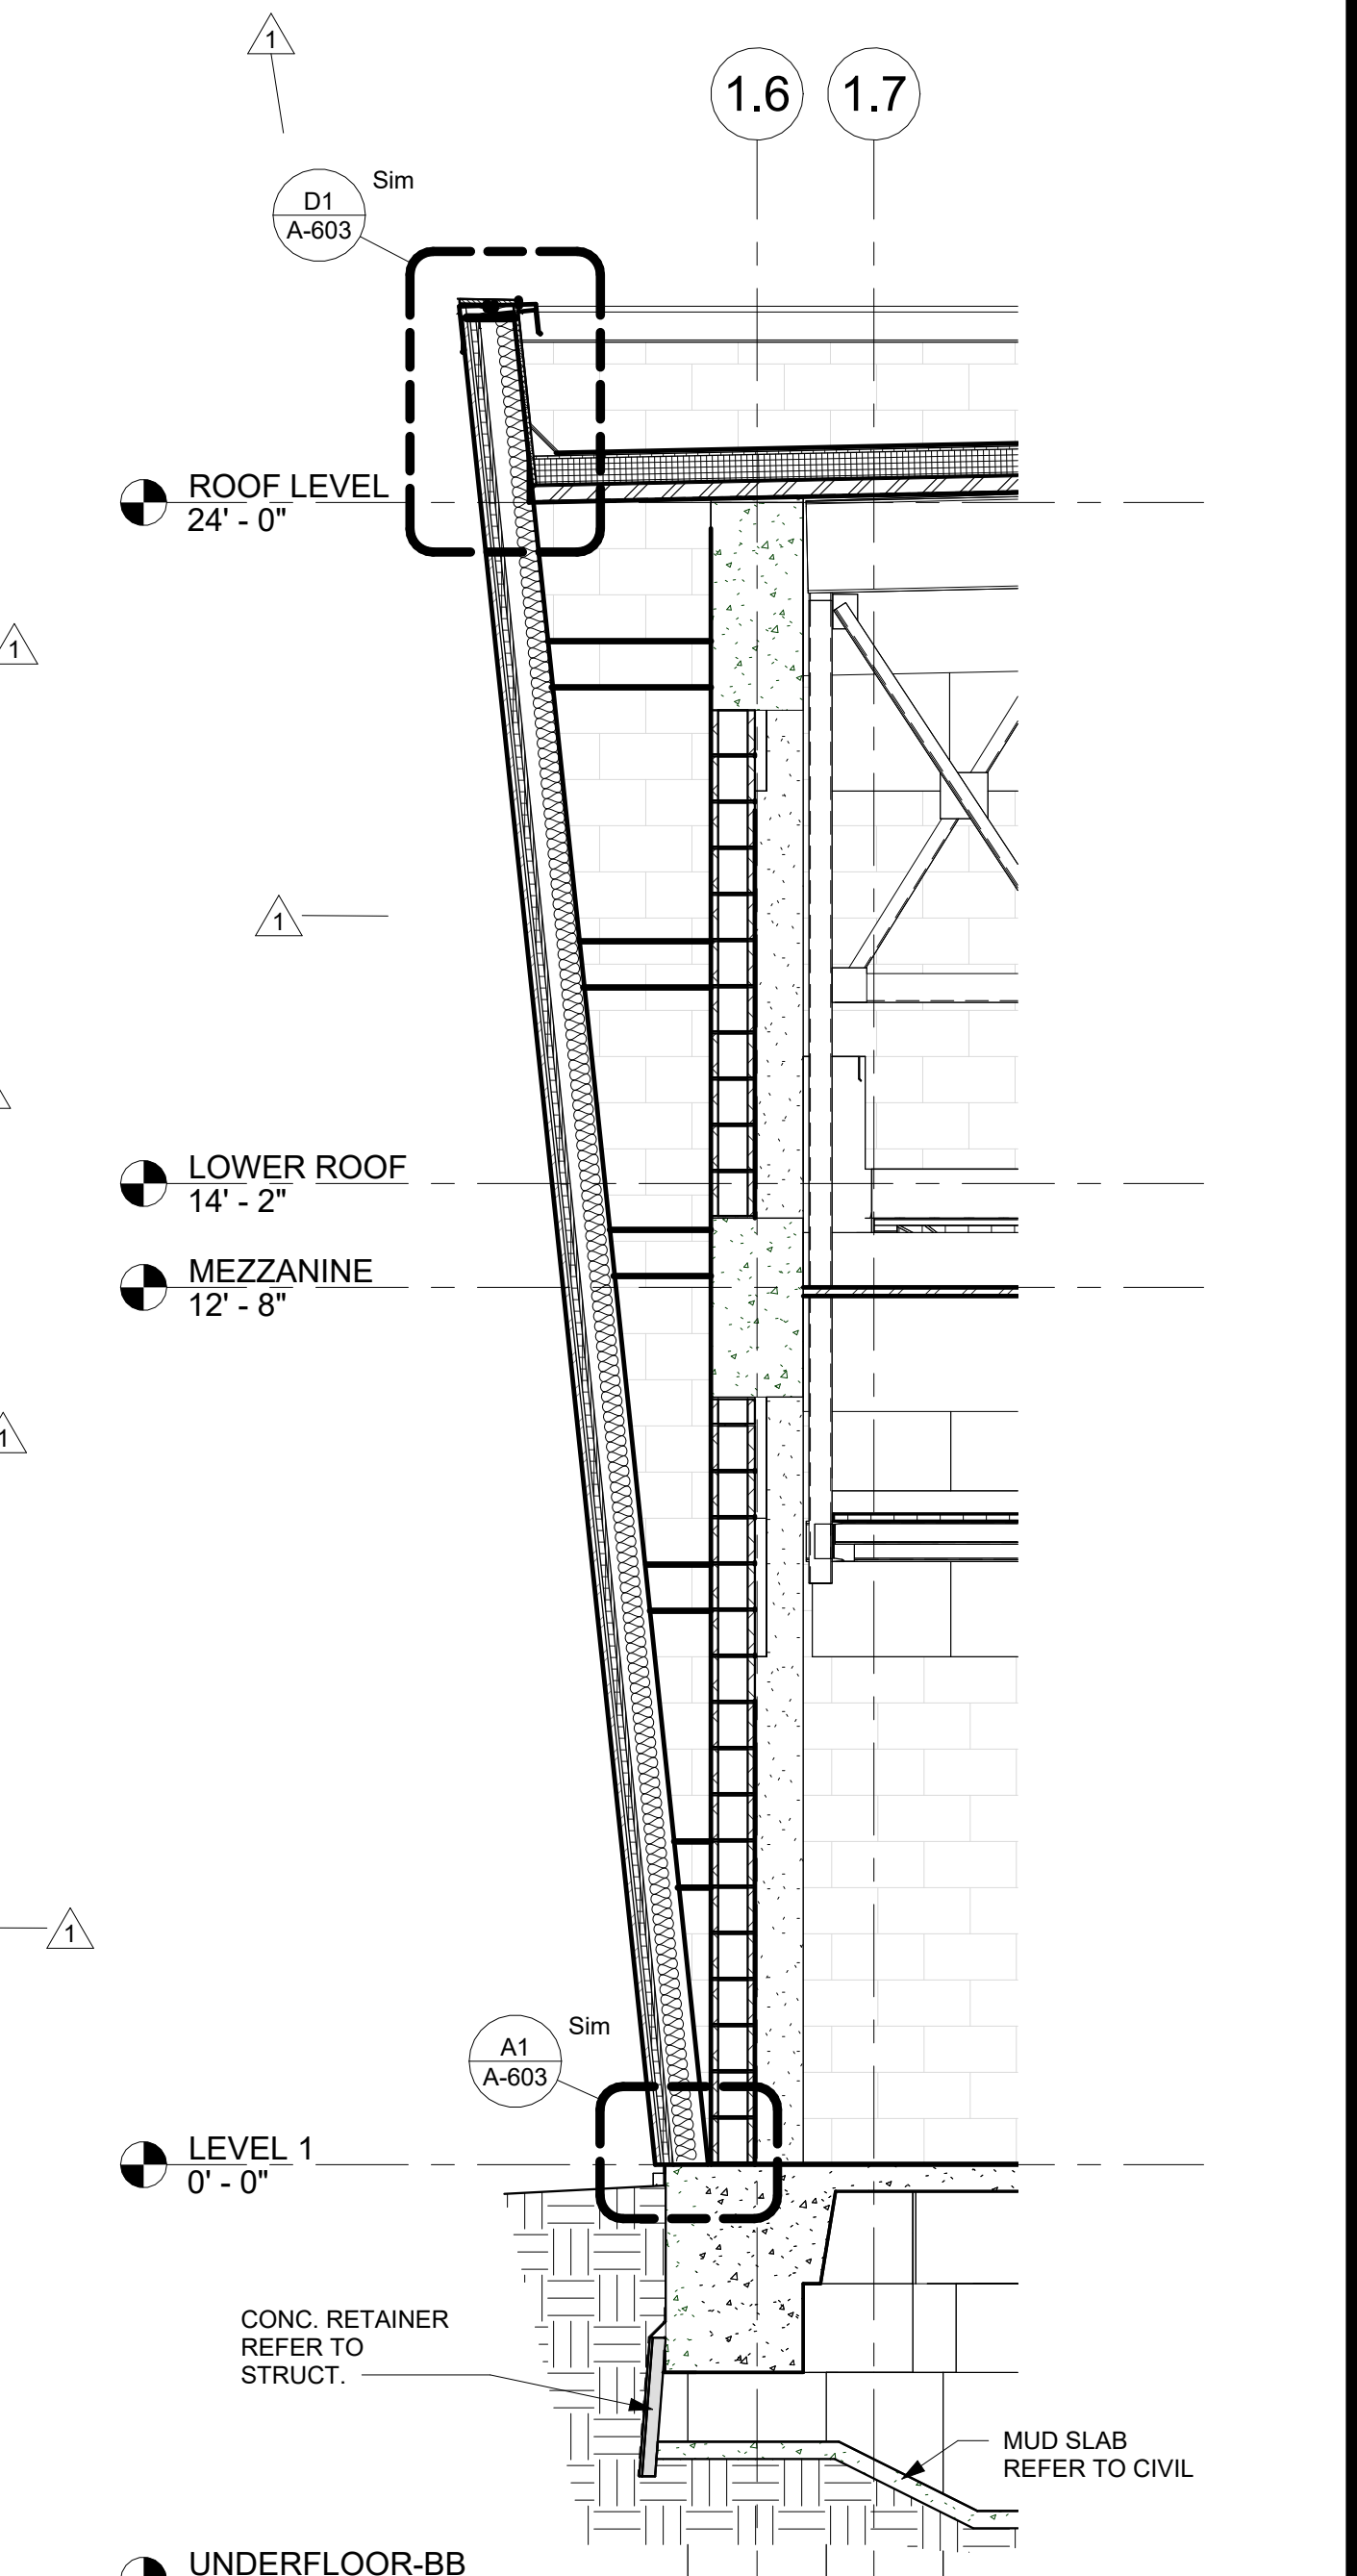

A4 WALL SECTION @ 1.6 - BLACK BOX
A-603 3/8\"/>



Permit/Seal

06.24.24

Consultant



Client/Project

SAN ANTONIO INDEPENDENT SCHOOL DISTRICT

BOND 2020 FOX TECH CAMPUS

ADDITIONS & RENOVATIONS

637 N. MAIN AVE.
SAN ANTONIO, TEXAS 78205

CONSTRUCTION DOCUMENTS		
DATE	06/24/24	
PROJECT NO.	A202108.00	
DRAWN BY	HG	CHECKED BY EG
ISSUE / REVISIONS		
#	DESCRIPTION	DATE
1	PERMIT SET	08/23/24
1	ADDENDA #02	07/26/24

PERMIT SET

Sheet Name

WALL SECTIONS - BLACK BOX

Drawing No.

A-603

W202004.12 3:55 PM
ORIGINAL SHEET - ARCH-ET

1

2

3

4

5

6


D

C


B

A

E1 PLAN DETAIL
A-610 1 1/2" = 1'-0"

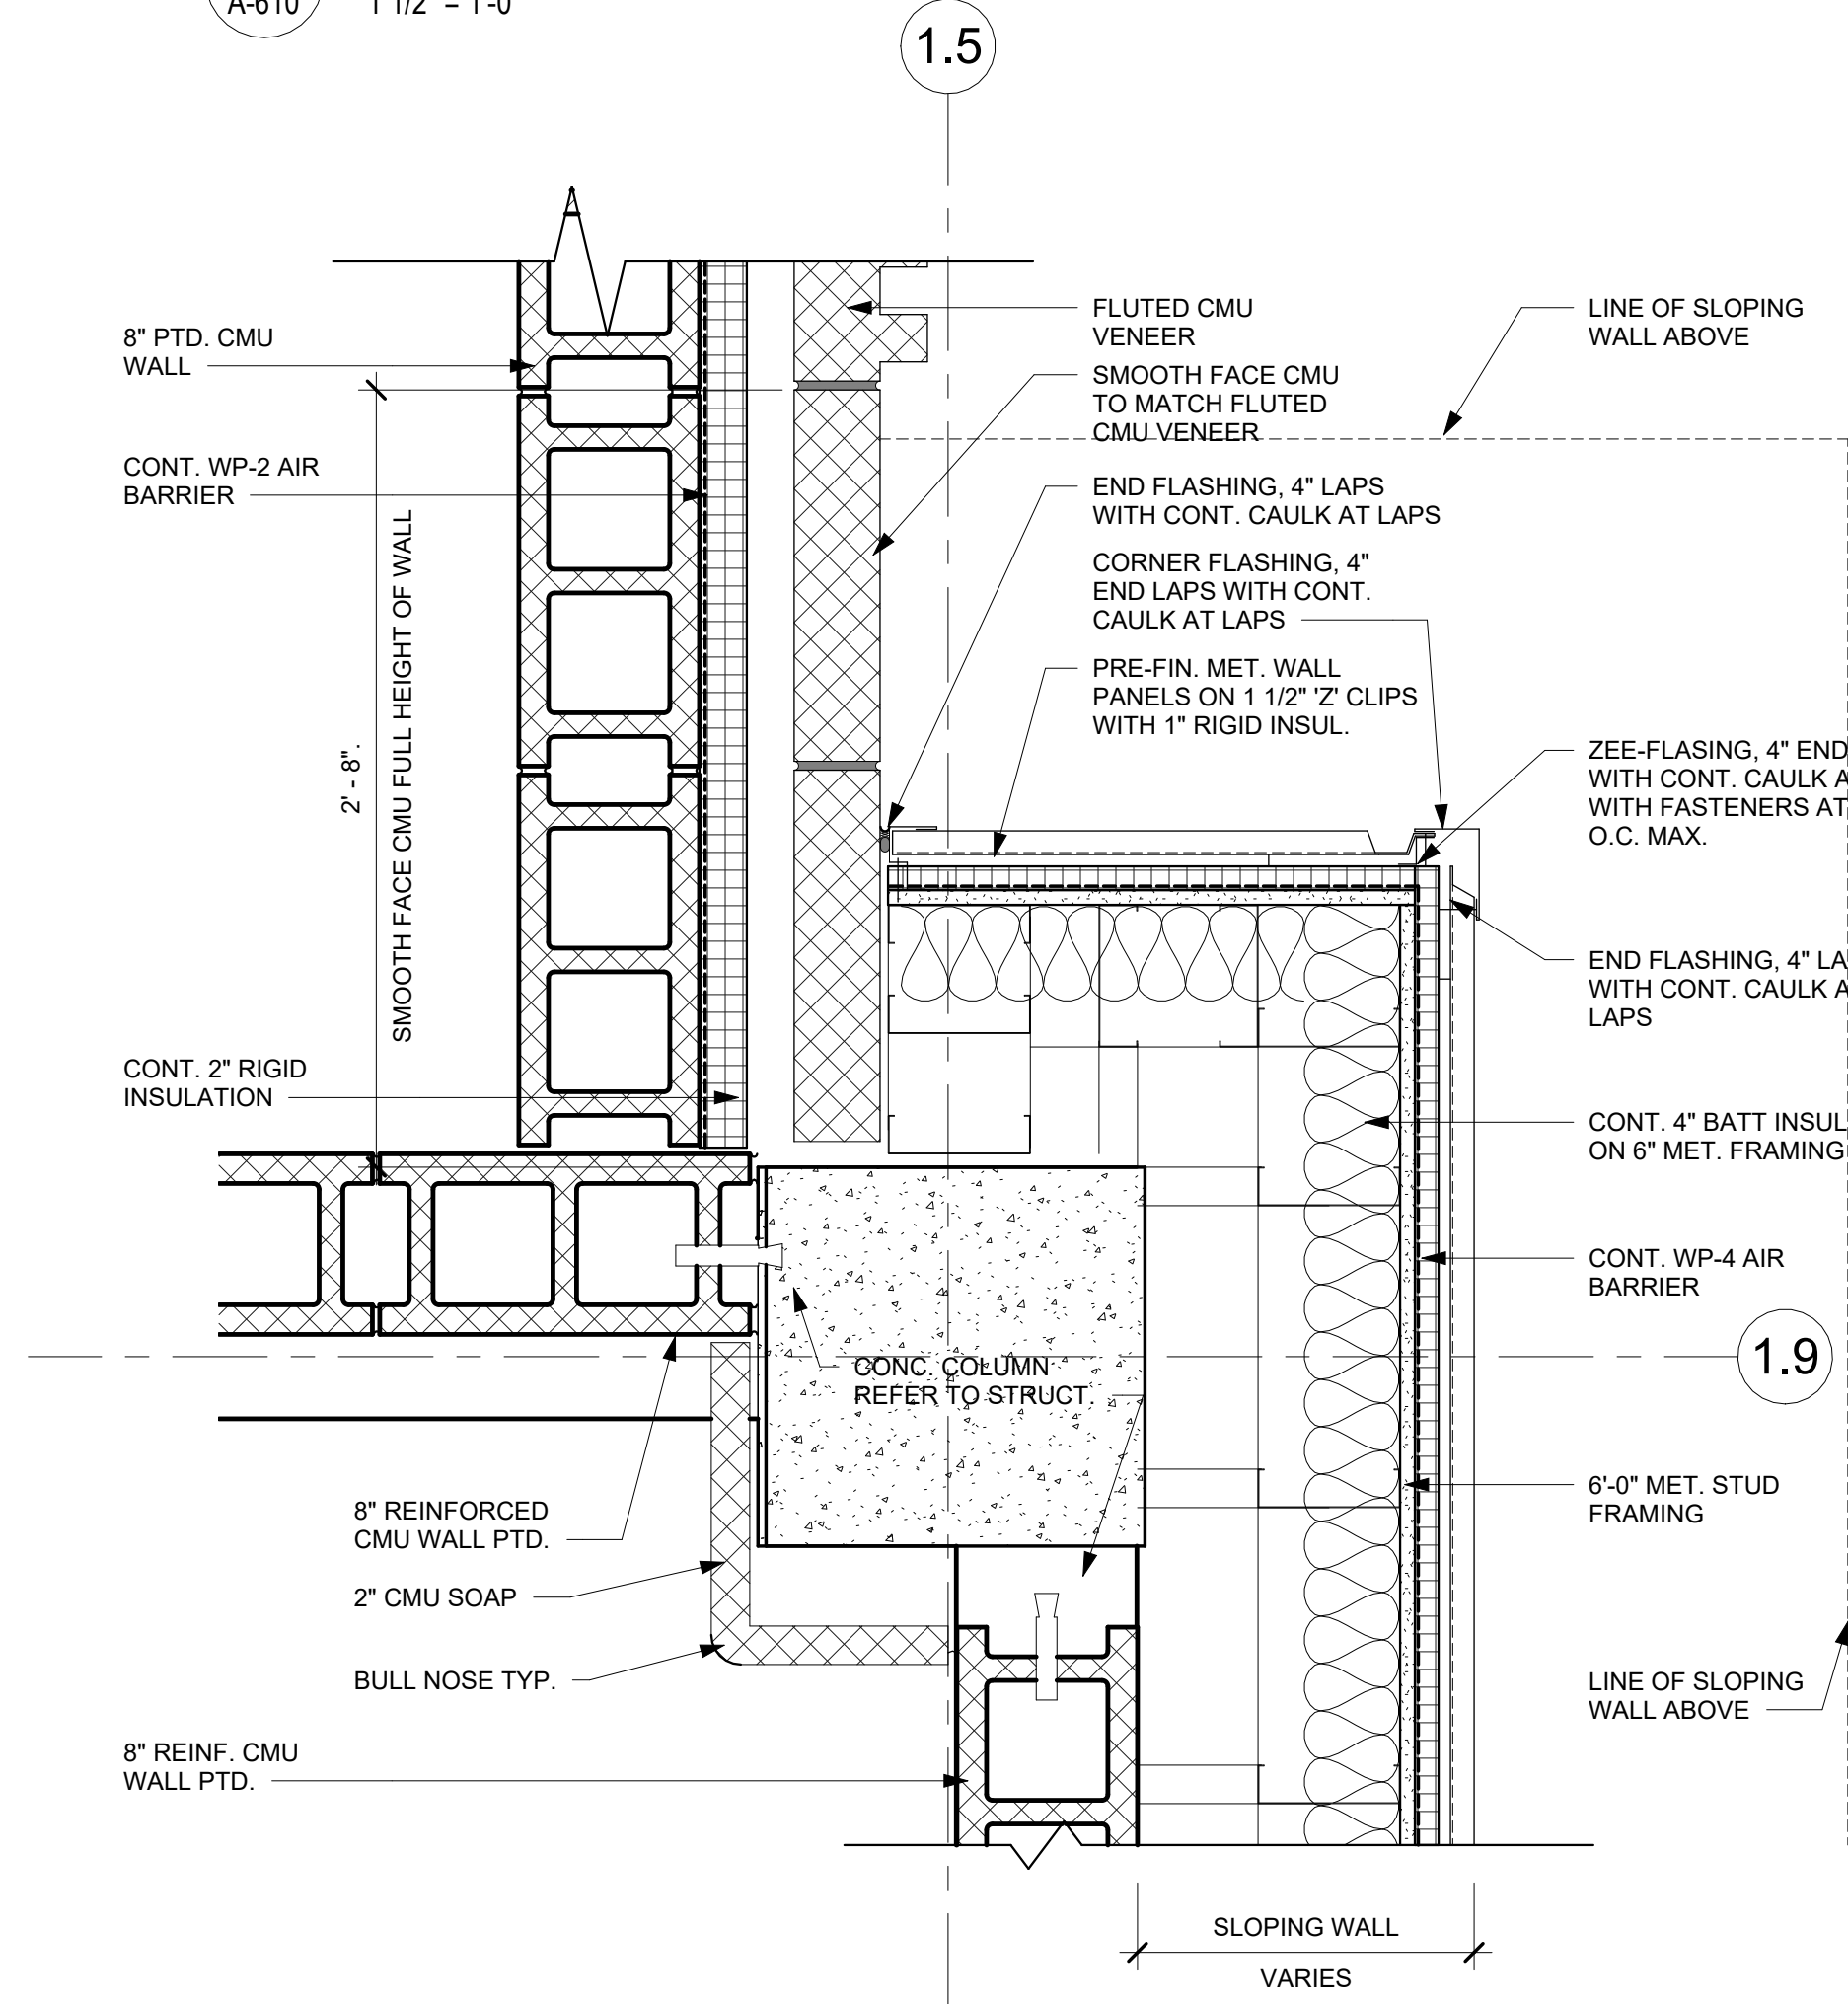


C1 PLAN DETAIL
A-610 1 1/2" = 1'-0"

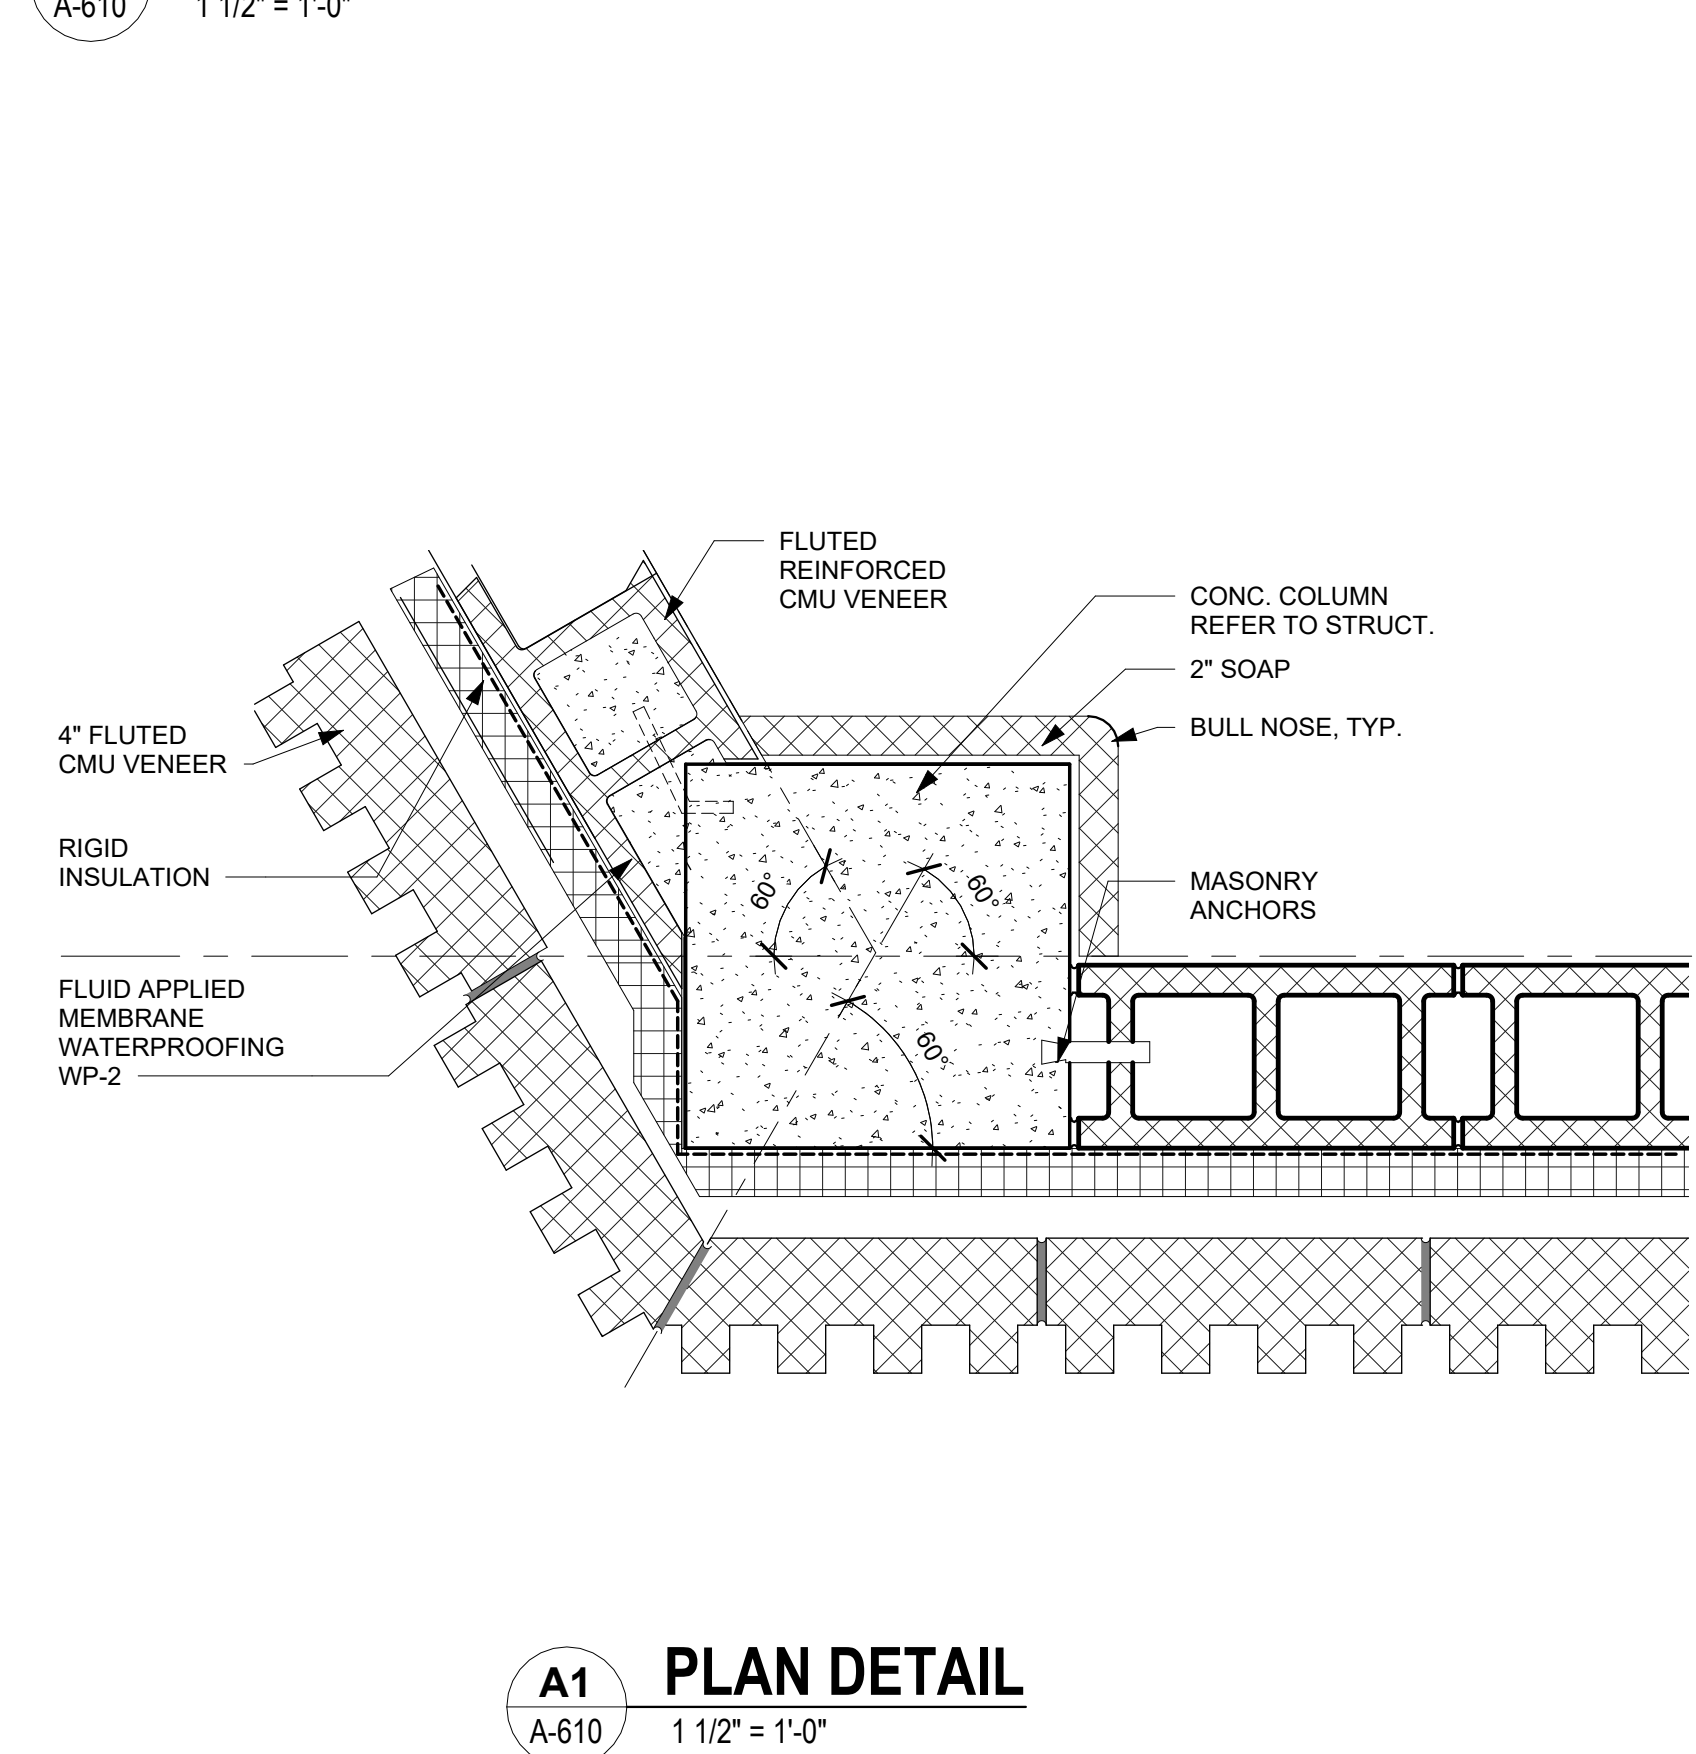


A1 PLAN DETAIL
A-610 1 1/2" = 1'-0"

E3 PLAN DETAIL
A-610 1 1/2" = 1'-0"

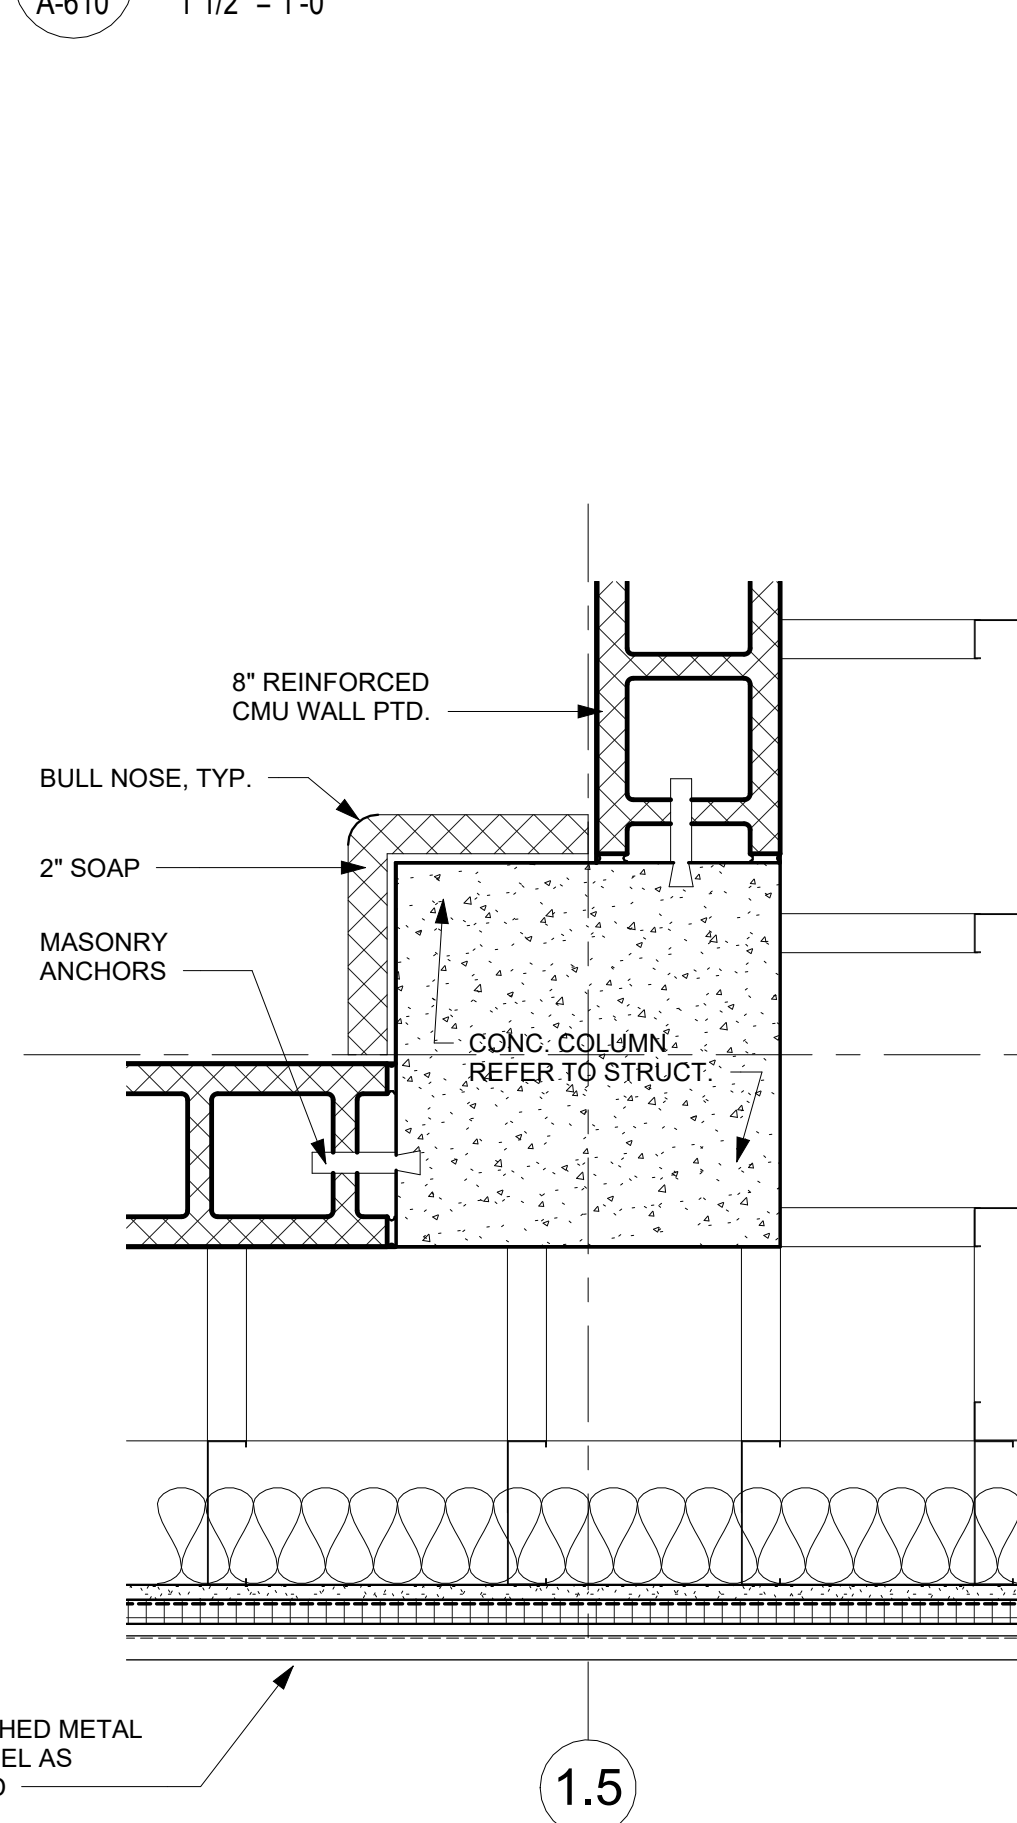


C3 PLAN DETAIL
A-610 1 1/2" = 1'-0"

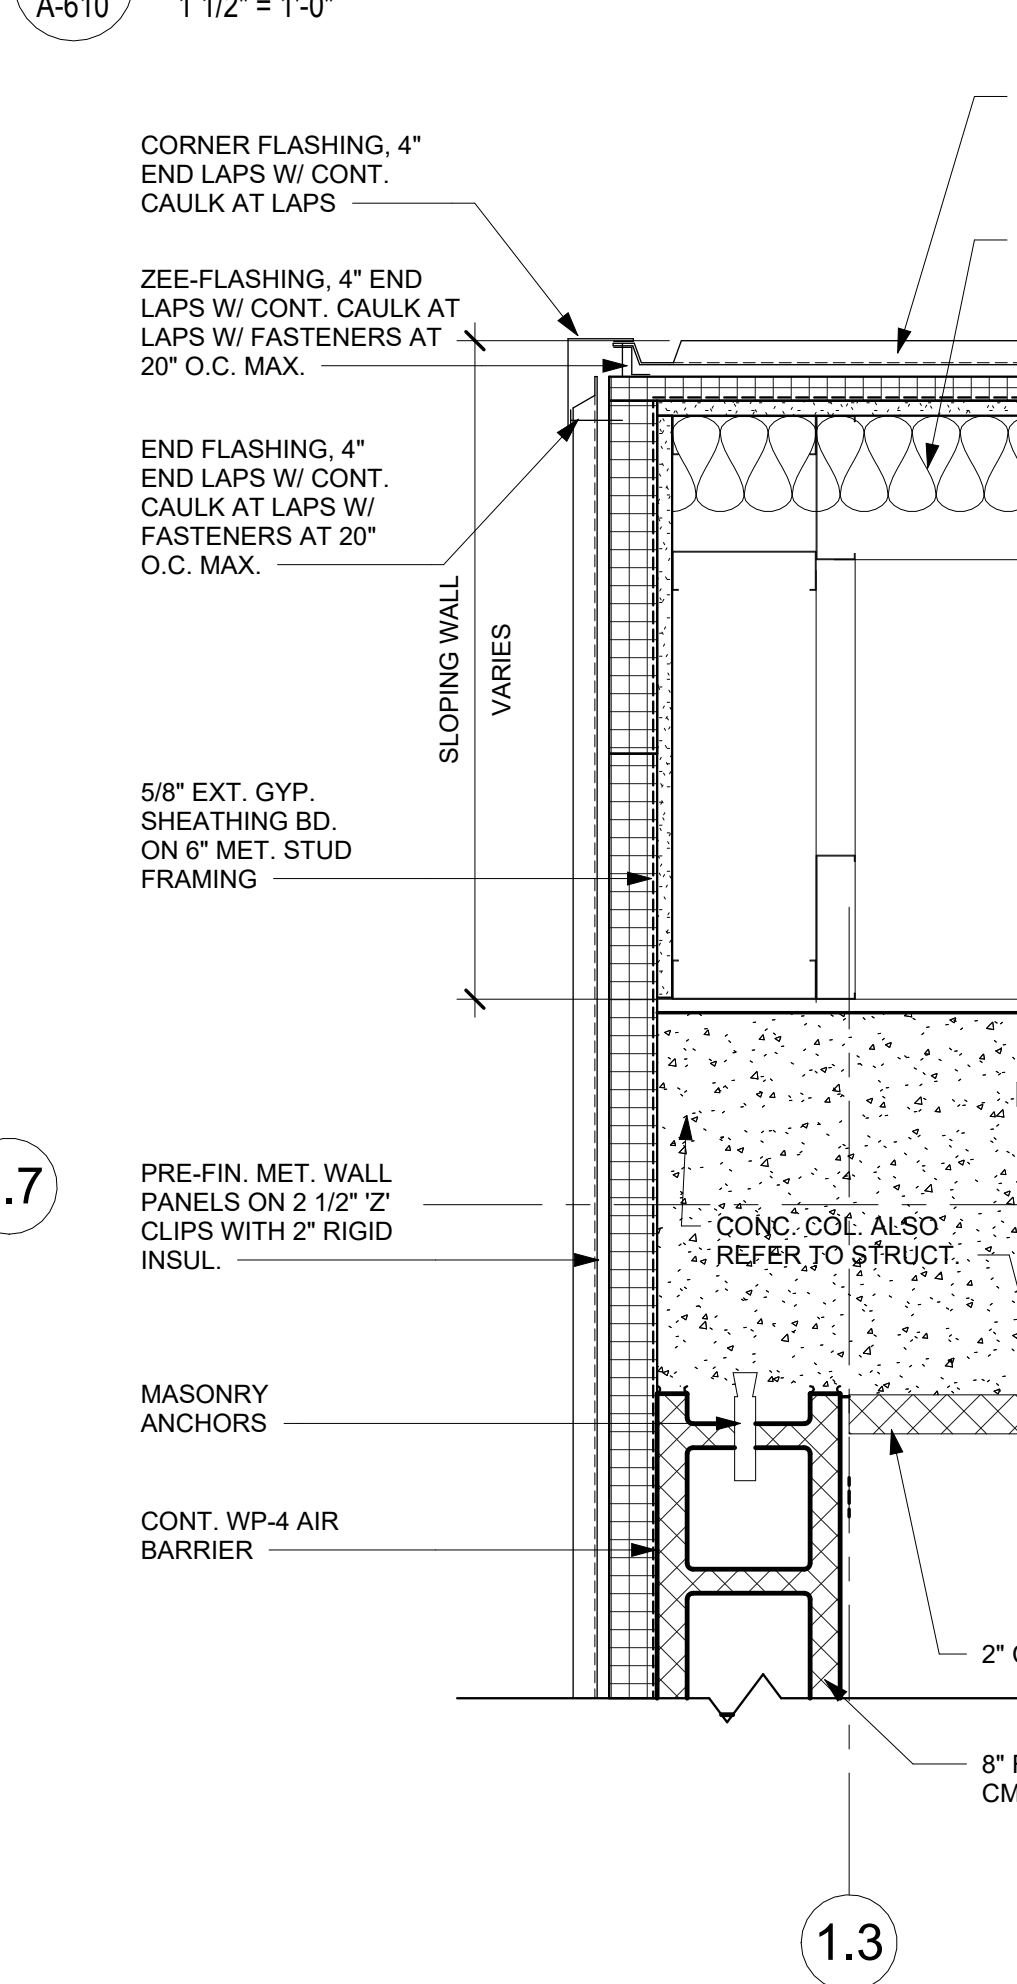


A3 PLAN DETAIL
A-610 1 1/2" = 1'-0"



E4 PLAN DETAIL
A-610 1 1/2" = 1'-0"

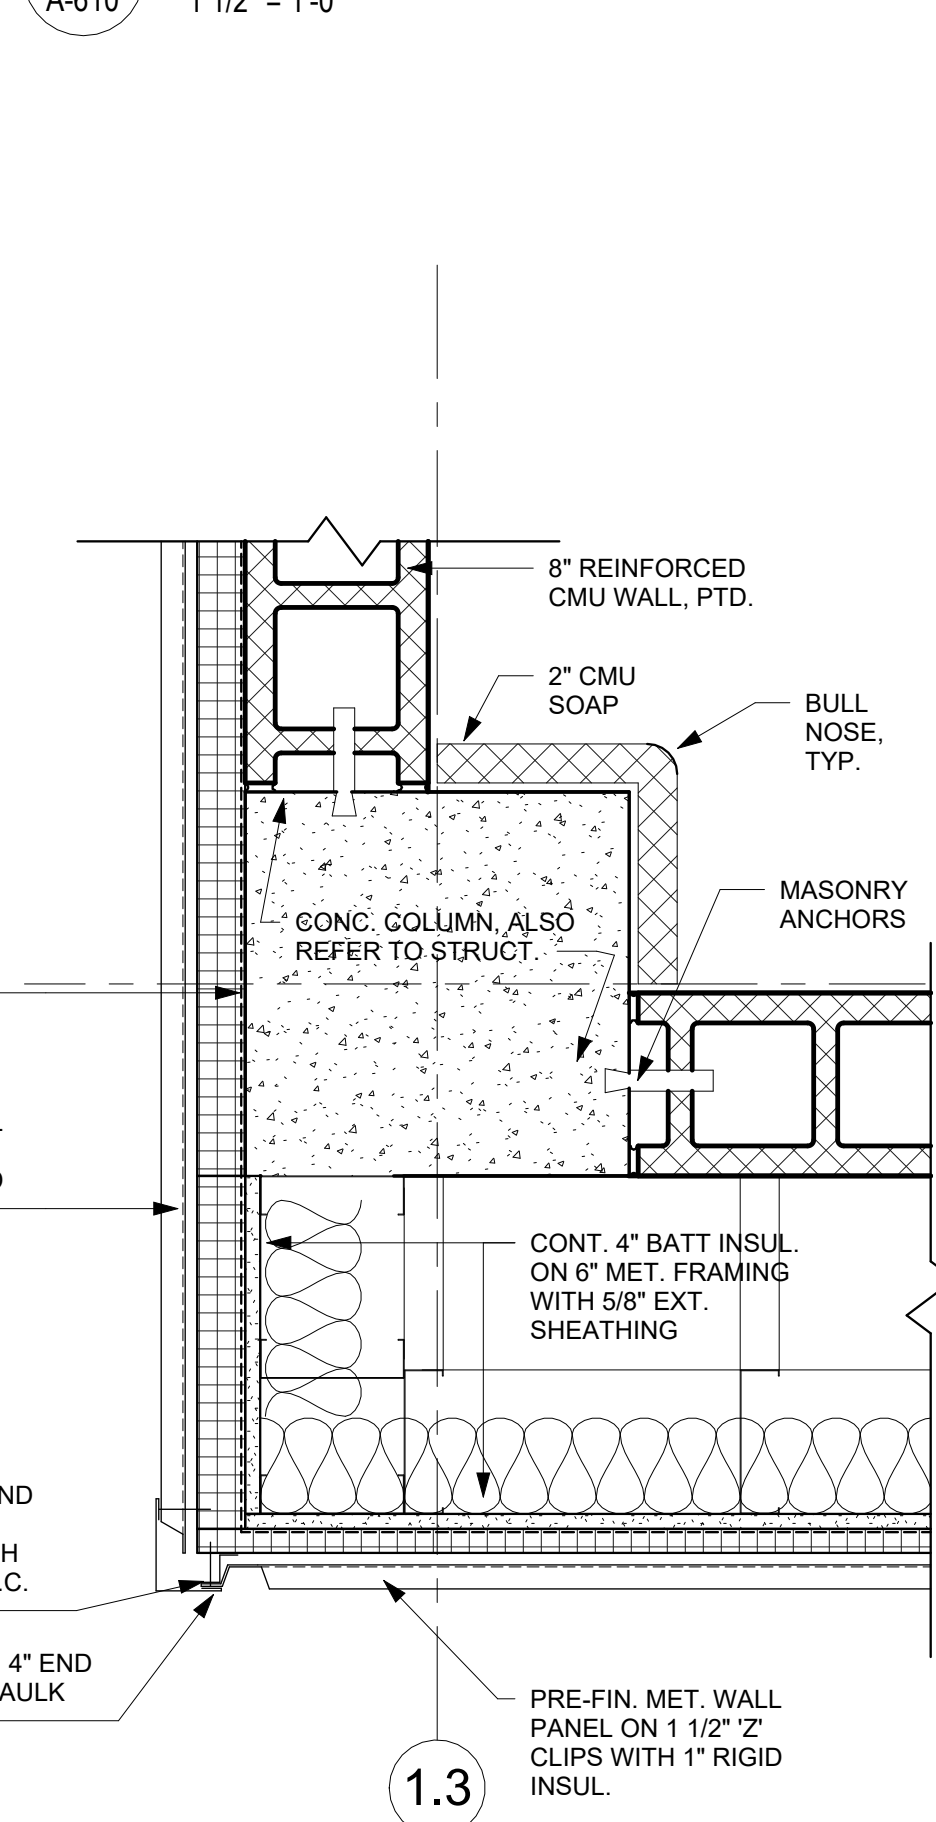


C4 PLAN DETAIL
A-610 1 1/2" = 1'-0"

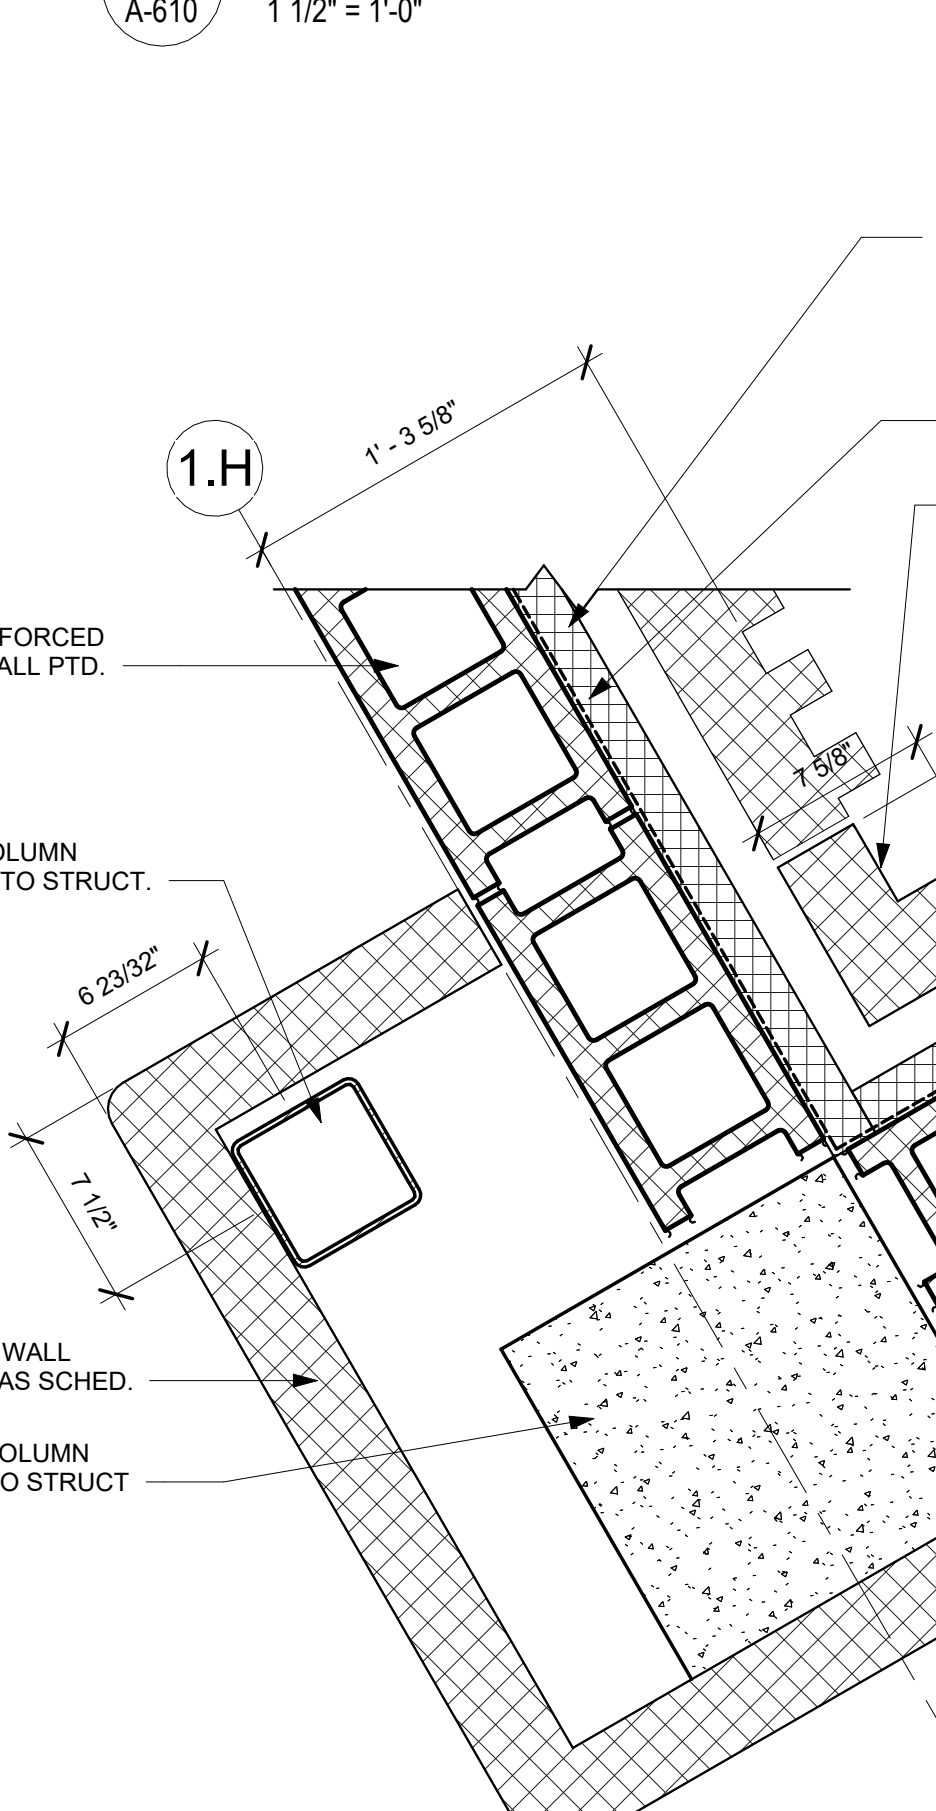


A4 PLAN DETAIL
A-610 1 1/2" = 1'-0"



E6 PLAN DETAIL
A-610 1 1/2" = 1'-0"

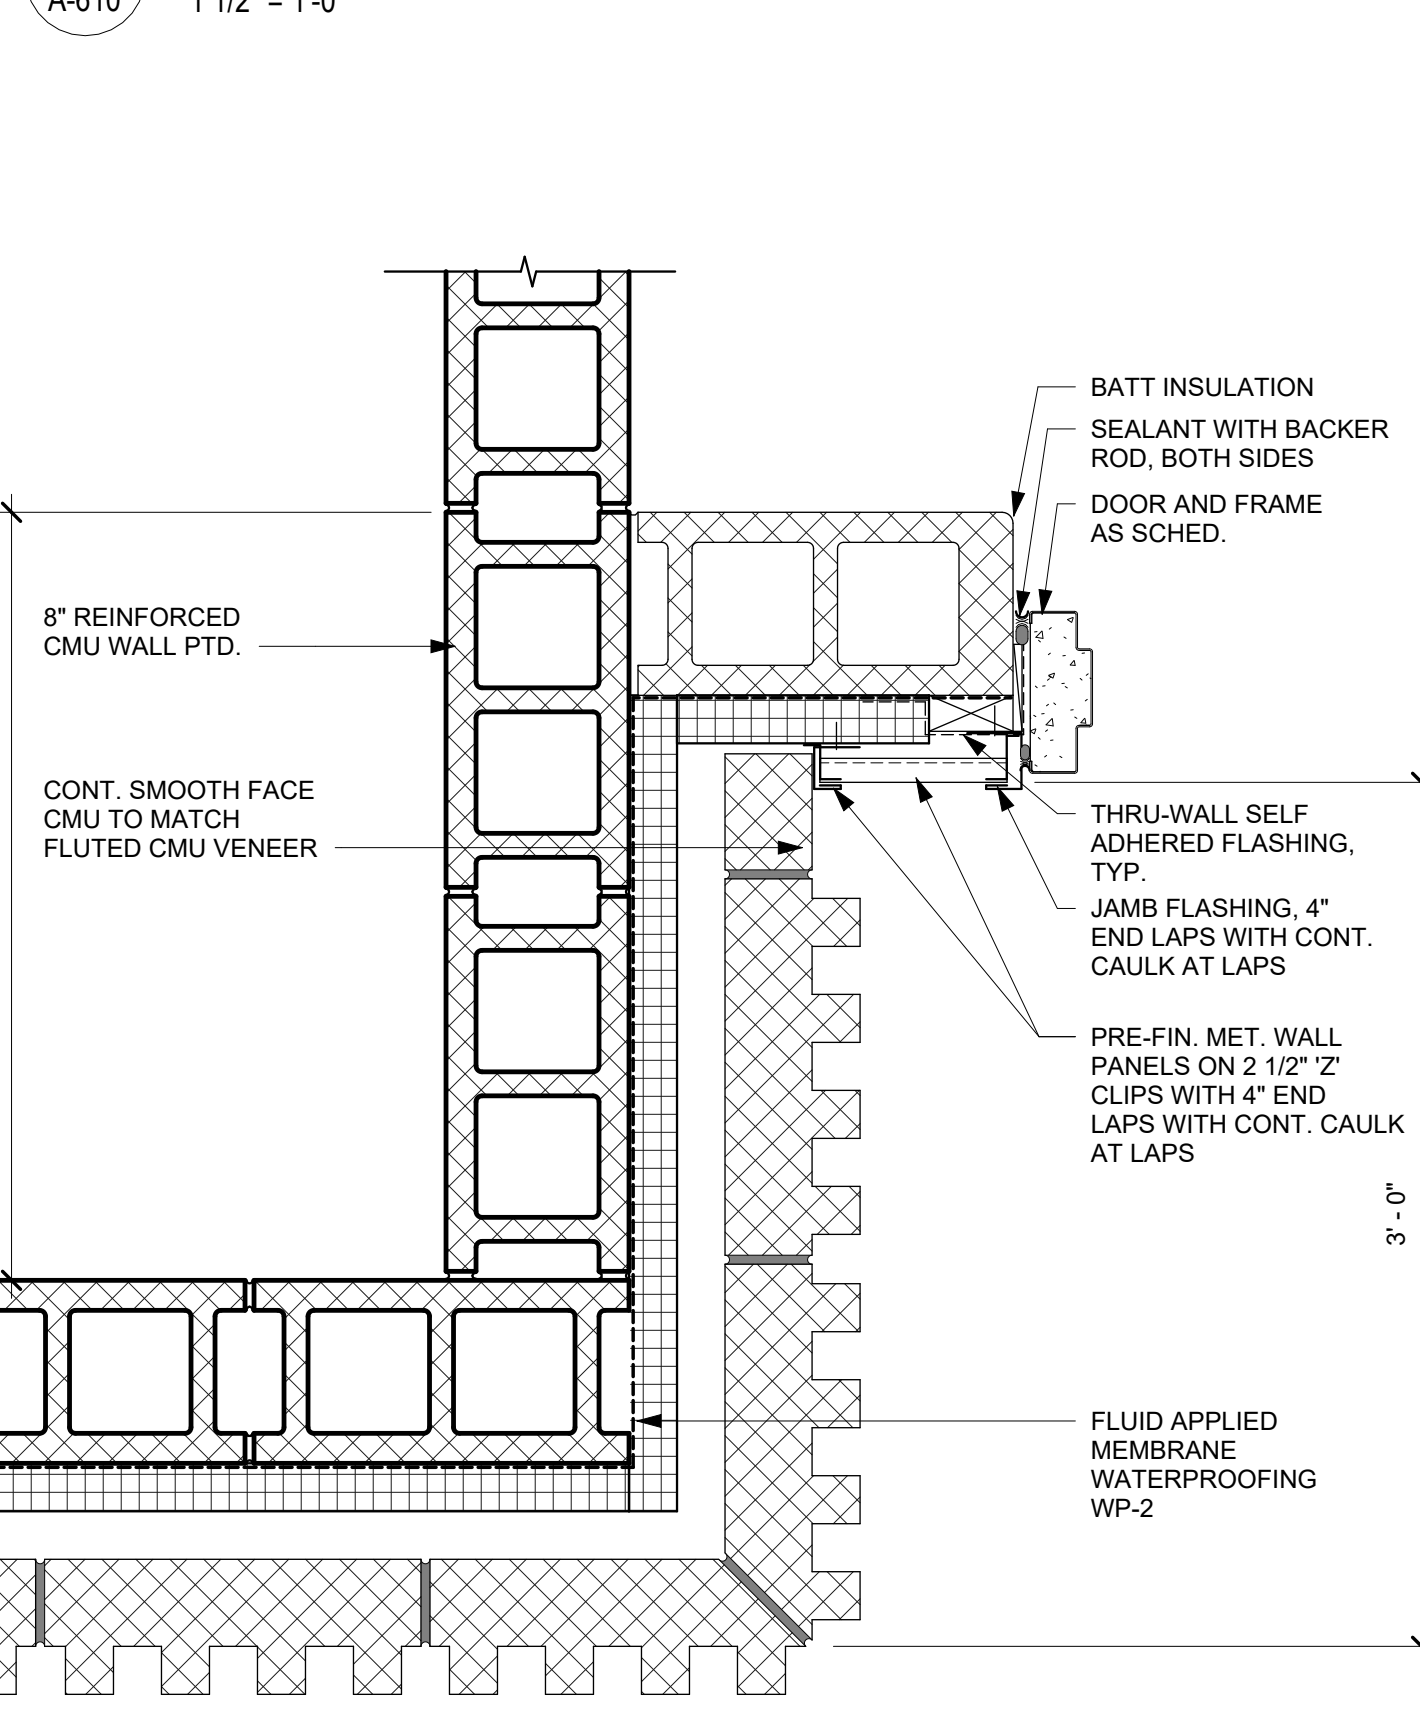

C5 PLAN DETAIL
A-610 1 1/2" = 1'-0"

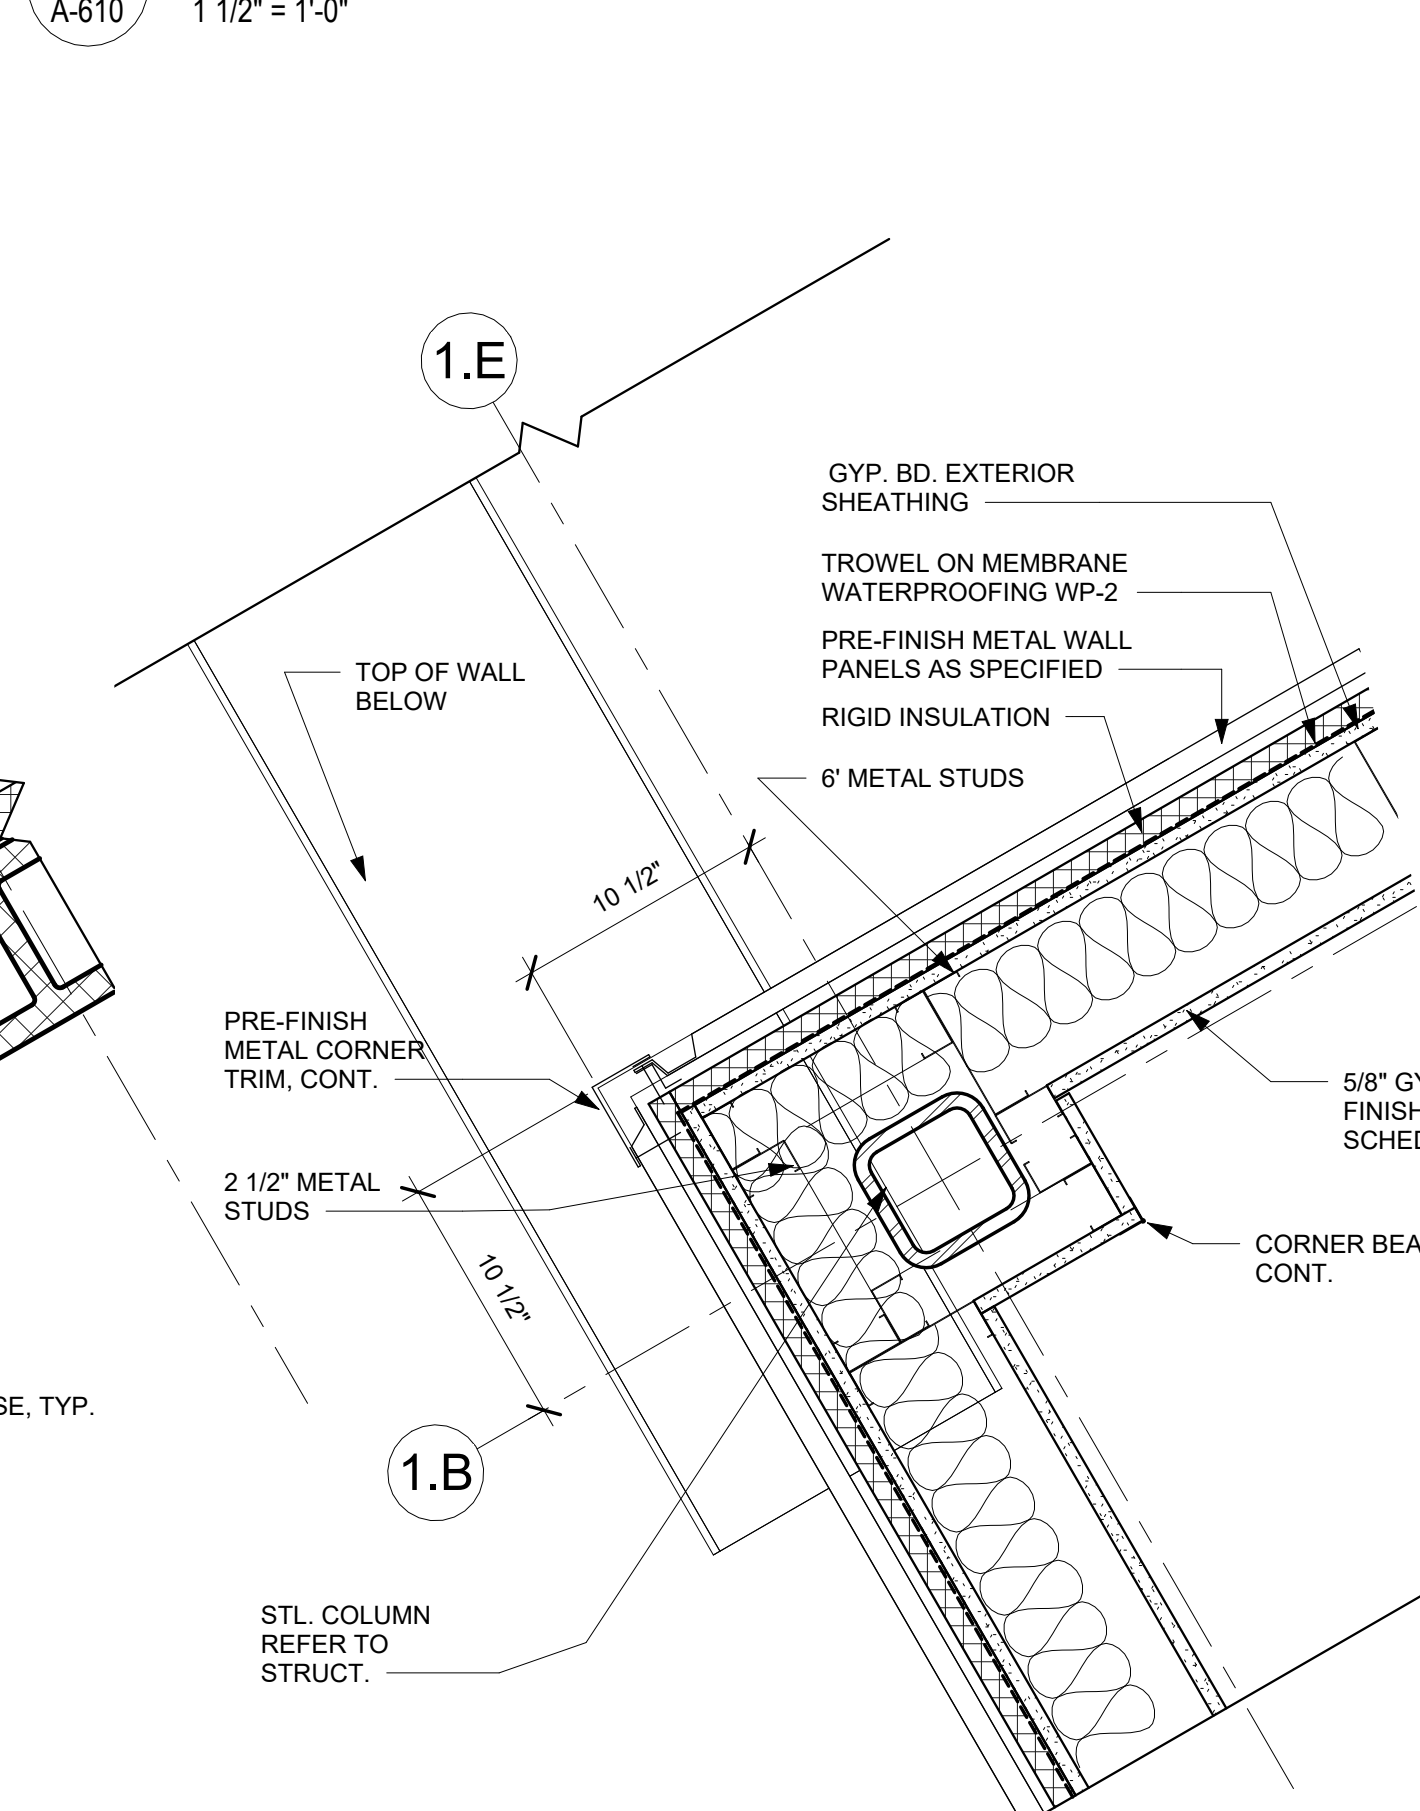

A5 PLAN DETAIL
A-610 1 1/2" = 1'-0"



alta

Permit/Seal



Consultant



Client/Project
SAN ANTONIO INDEPENDENT SCHOOL DISTRICT

**BOND 2020 FOX TECH CAMPUS
ADDITIONS & RENOVATIONS**

637 N. MAIN AVE.
SAN ANTONIO, TEXAS 78205

DATE
06/24/24
CONSTRUCTION DOCUMENTS

PROJECT NO. **A202108.00** HG **ALTA**

ISSUE / REVISIONS

#	DESCRIPTION	DATE
1	PERMIT SET	08/23/24
1	ADDENDA #02	07/26/24

PERMIT SET

Sheet Name
PLAN DETAILS - BLACK BOX

Drawing No.
A-610



Permit/Seal

Consultant



Client/Project
SAN ANTONIO INDEPENDENT SCHOOL DISTRICT
BOND 2020 FOX TECH CAMPUS
ADDITIONS & RENOVATIONS
637 N. MAIN AVE.
SAN ANTONIO, TEXAS 78205


DATE	06/24/24	CONSTRUCTION DOCUMENTS
PROJECT NO.	A202108.00	DRAWN BY LA
		CHECKED BY LD
ISSUE / REVISIONS		
#	DESCRIPTION	DATE
1	PERMIT SET	08/23/24
1	ADDENDA #02	07/26/24

PERMIT SET

Sheet Name
INTERIOR ELEVATIONS - BLACK BOX BLDG


Drawing No.
A-809

E
D
C
B
A

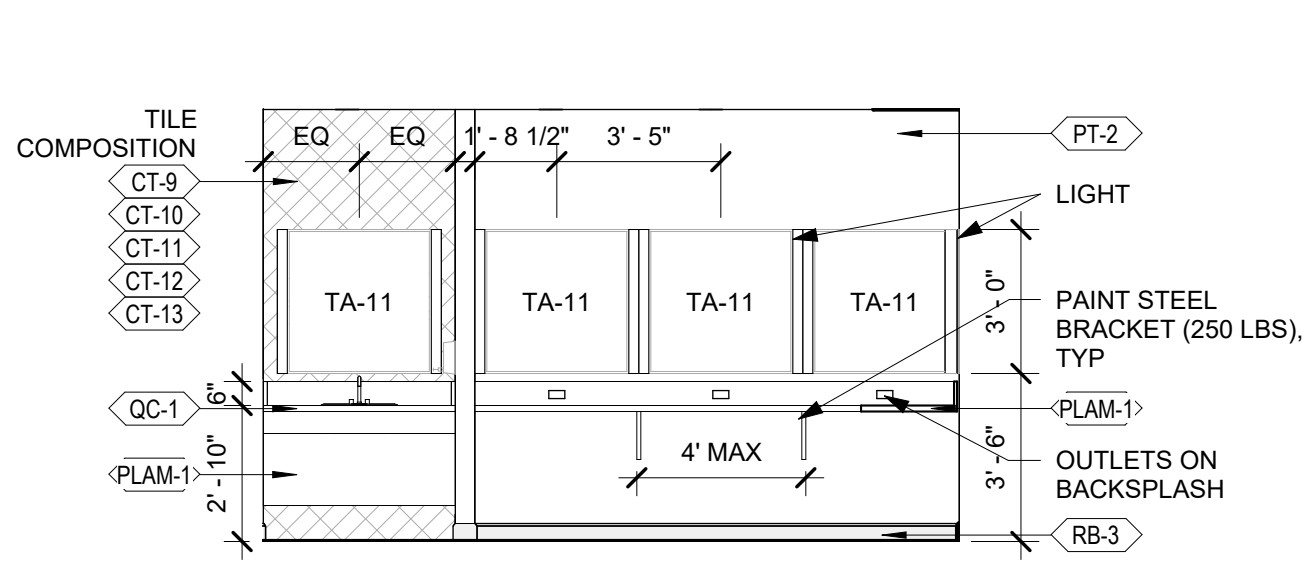


E1 EAST ELEV. DRESSING R. 51004

A-810 1/4" = 1'-0"

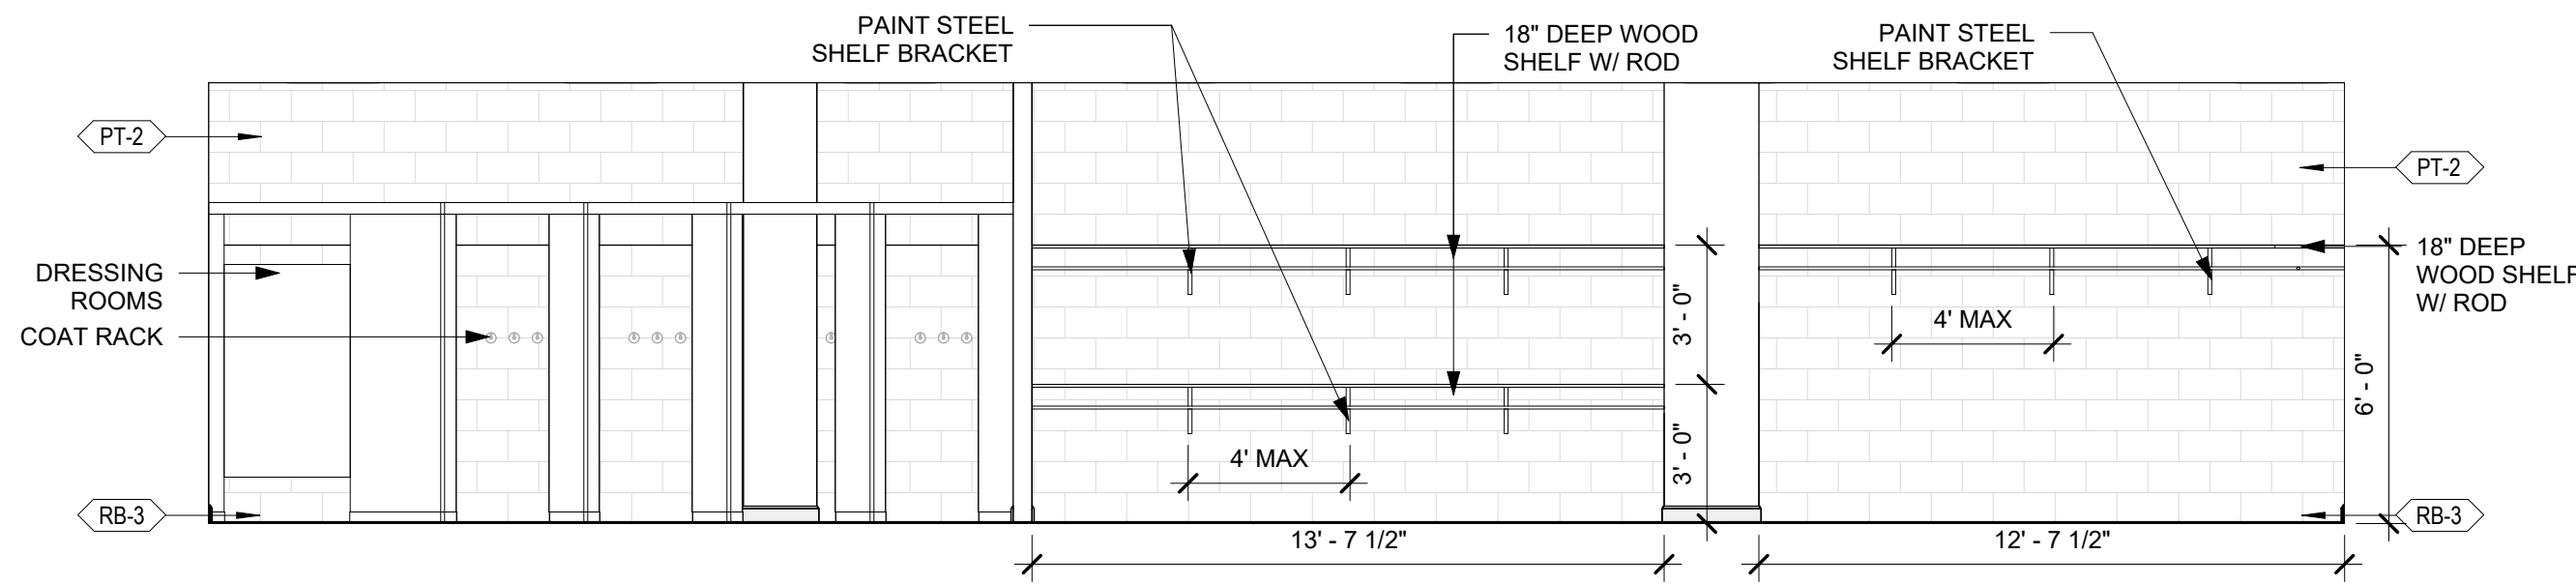


E3 NORTH ELEV. DRESSING R. 51004

A-810 1/4" = 1'-0"

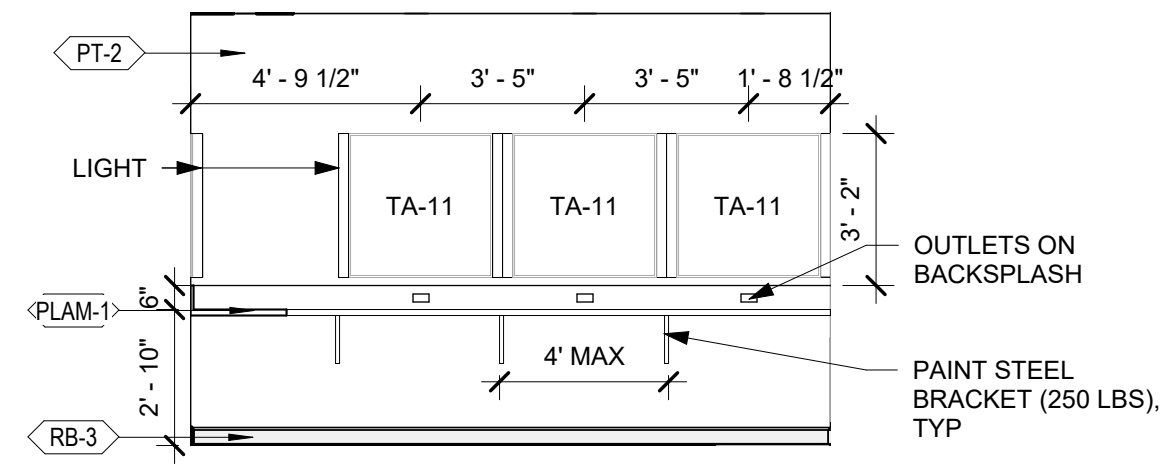


E5 SOUTH B ELEV. DRESSING R. 51004

A-810 1/4" = 1'-0"

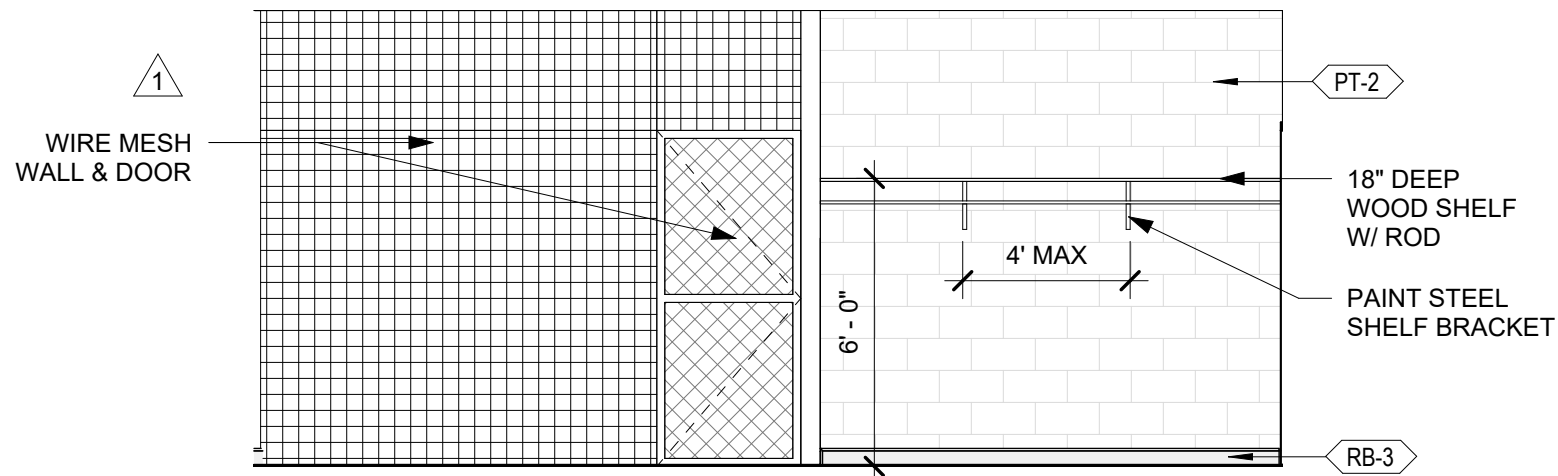


D1 WEST ELEV. DRESSING R. 51004

A-810 1/4" = 1'-0"

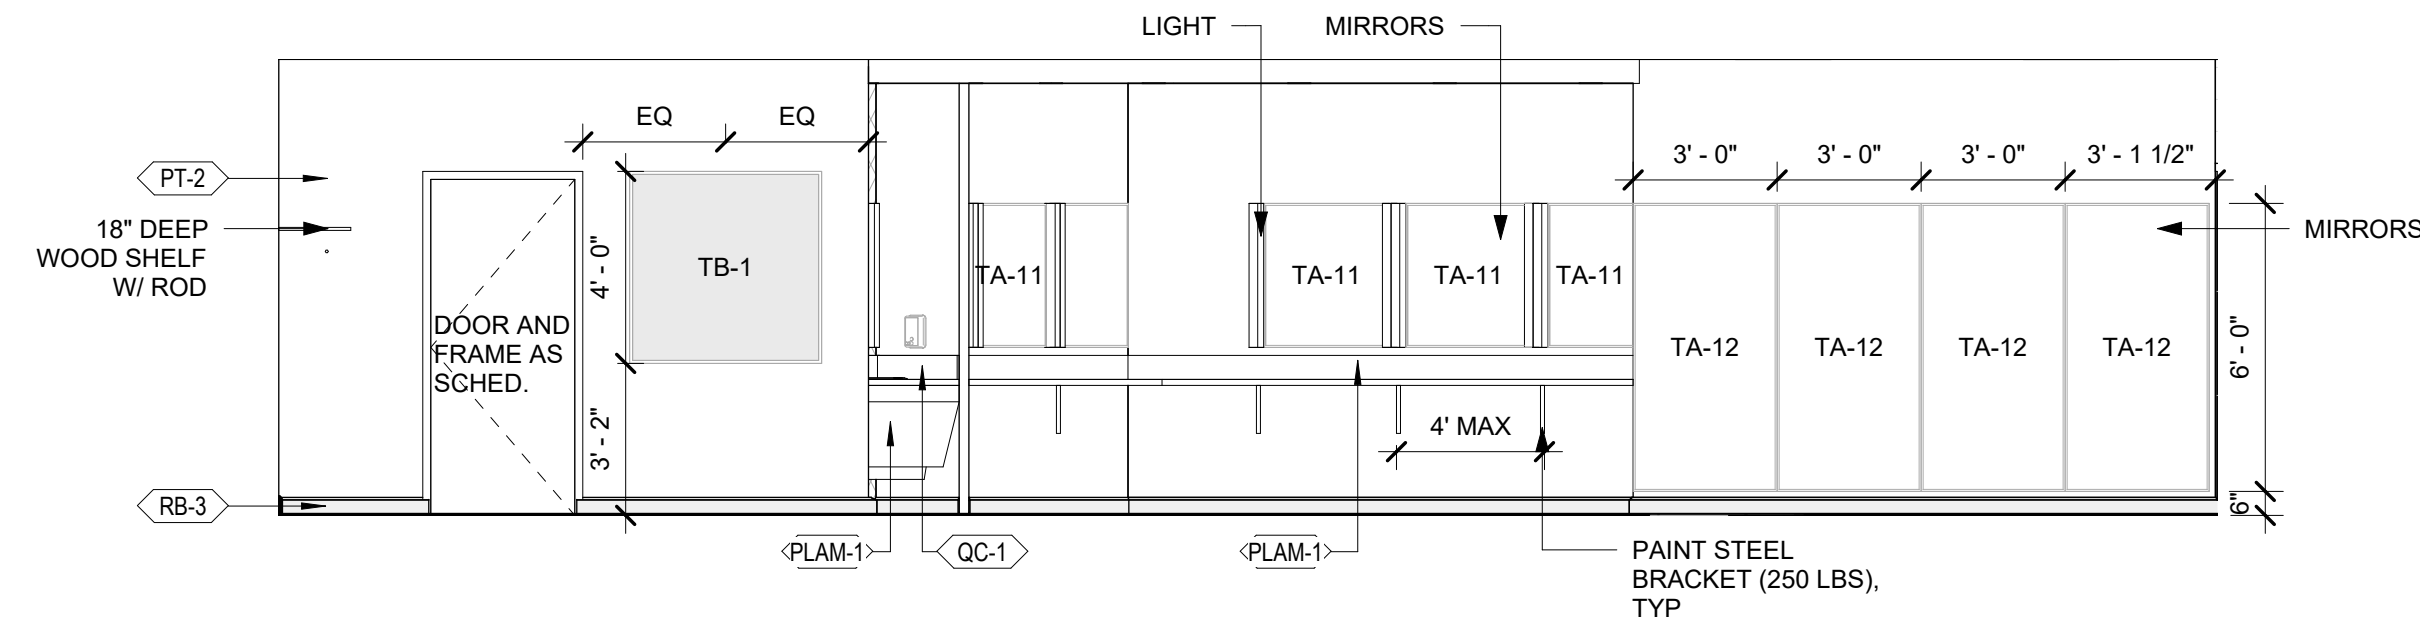


D3 SOUTH A ELEV. DRESSING R. 51004

A-810 1/4" = 1'-0"

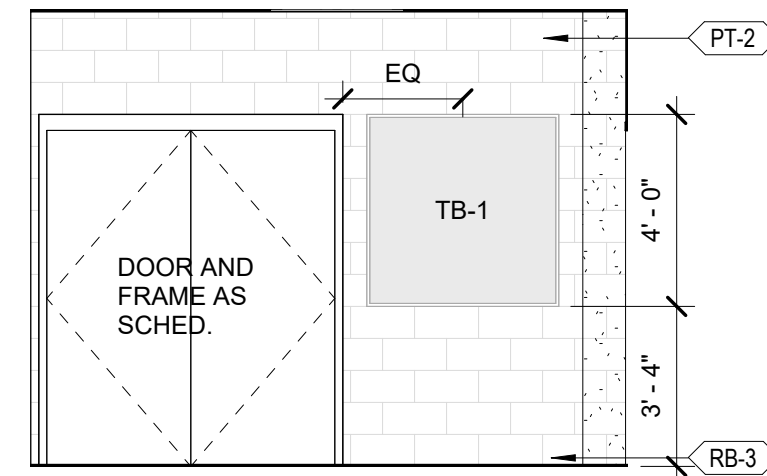

D5 EAST-B ELEV. DRESSING R. 51004


A-810 1/4" = 1'-0"

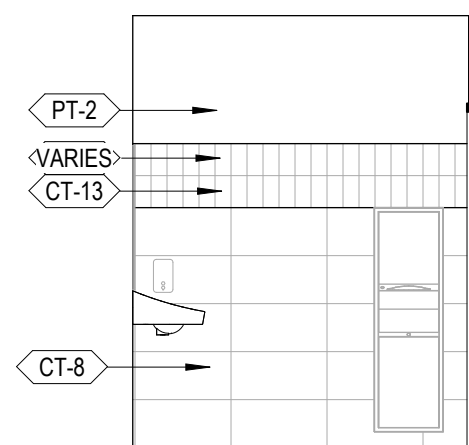

C1 EAST ELEV. RR. 51004A

A-810 1/4" = 1'-0"


NOTE:
TYPICAL RR WALL ELEVATION.
REFER TO C4/A-806 FOR DETAILS.

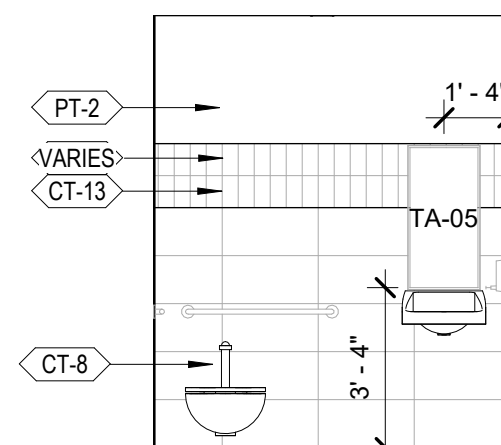

C2 NORTH ELEV. RR. 51004A

A-810 1/4" = 1'-0"


NOTE:
TYPICAL RR WALL ELEVATION.
REFER TO C4/A-806 FOR DETAILS.

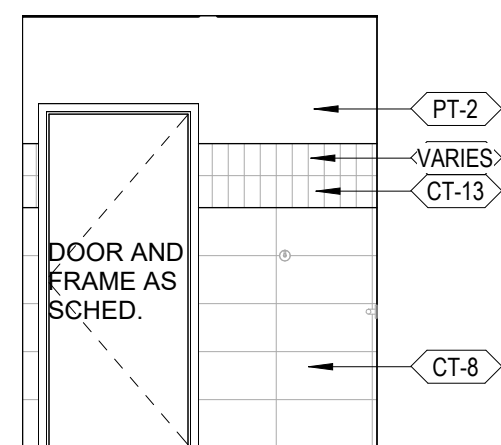

C3 SOUTH ELEV. RR. 51004A

A-810 1/4" = 1'-0"


NOTE:
TYPICAL RR WALL ELEVATION.
REFER TO C4/A-806 FOR DETAILS.

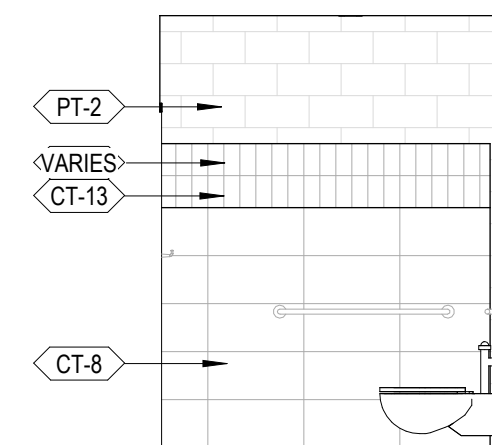

C4 WEST ELEV. RR. 51004A


A-810 1/4" = 1'-0"

NOTE:
TYPICAL RR WALL ELEVATION.
REFER TO C4/A-806 FOR DETAILS.

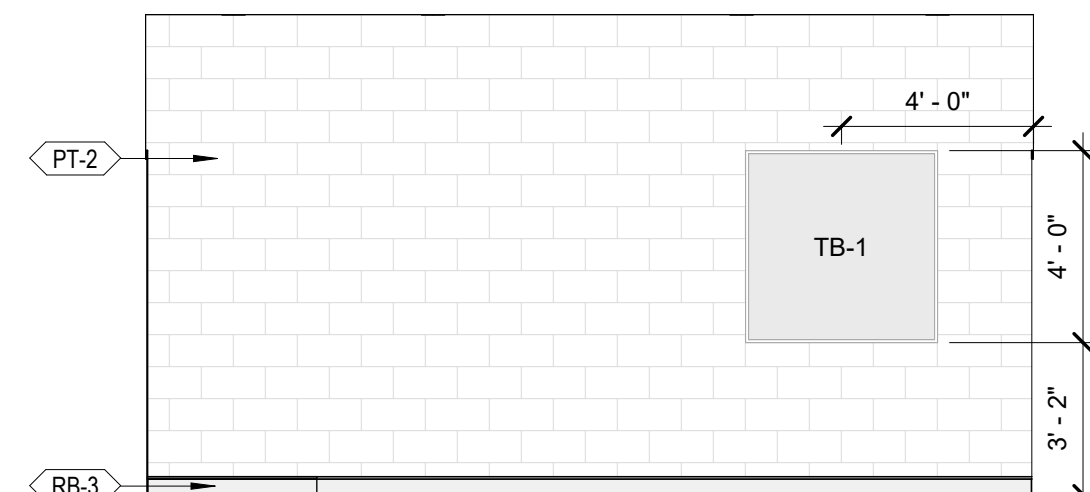

C5 EAST ELEV. ACAD. LOBBY 5V-1100


A-810 1/4" = 1'-0"

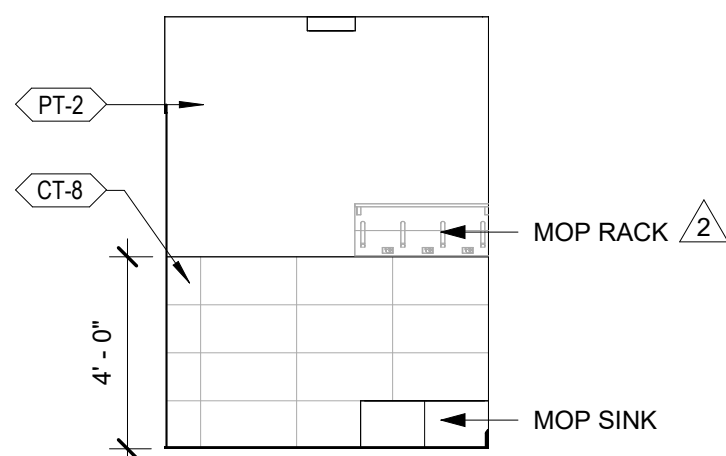

B1 NORTH ELEV. CUST. 51005

A-810 1/4" = 1'-0"

NOTE:
TYPICAL CUSTODIAL WALL ELEVATION.
REFER TO A6/A-806 FOR DETAILS.

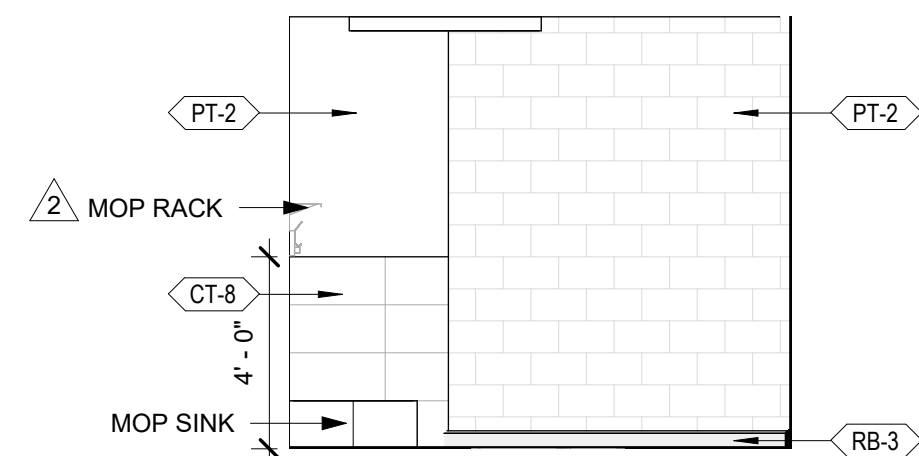

B2 WEST ELEV. CUST. 51005

A-810 1/4" = 1'-0"

NOTE:
TYPICAL CUSTODIAL WALL ELEVATION.
REFER TO A6/A-806 FOR DETAILS.

alta

Permit/Seal



06.24.24

Consultant



Client/Project
SAN ANTONIO INDEPENDENT SCHOOL DISTRICT

BOND 2020 FOX TECH CAMPUS
ADDITIONS & RENOVATIONS

637 N. MAIN AVE.
SAN ANTONIO, TEXAS 78205

DATE
06/24/24
CONSTRUCTION DOCUMENTS
PROJECT NO.
A202108.00
DRAWN BY
LA
CHECKED BY
LD

ISSUE / REVISIONS		
#	DESCRIPTION	DATE
1	PERMIT SET	08/23/24
2	ADDENDUM #01	07/17/24
3	ADDENDA #02	07/26/24

PERMIT SET

Sheet Name
INTERIOR ELEVATIONS -
BLACK BOX BLDG

Drawing No.
A-810


M

D


C

B


A

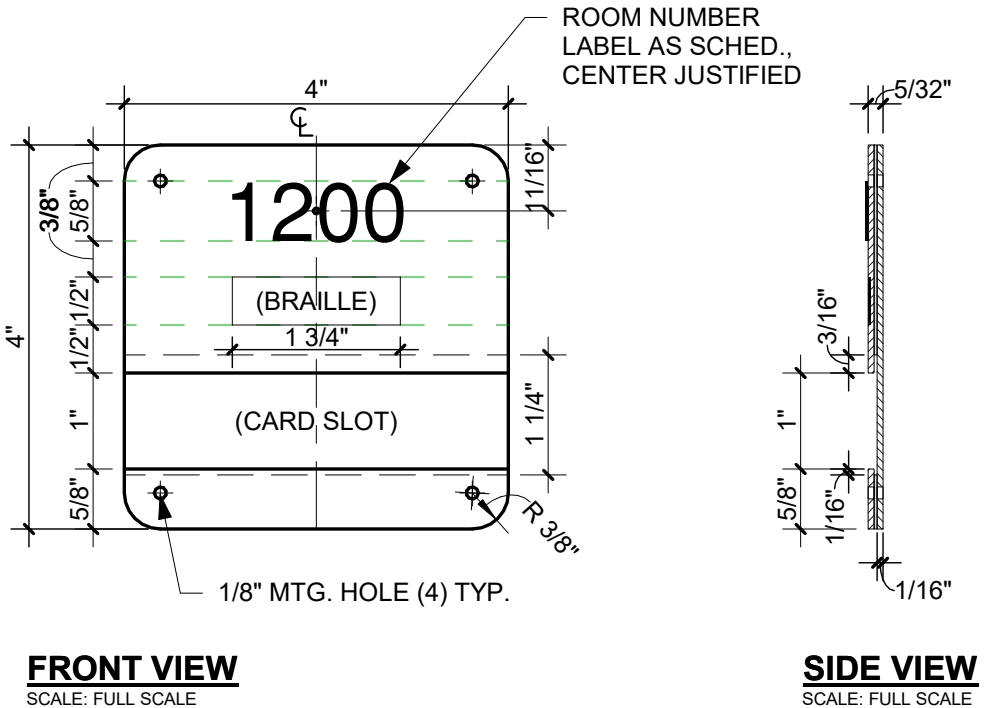


E1 TYPE A - ADMIN. ROOM
A-901 6" = 1'-0"

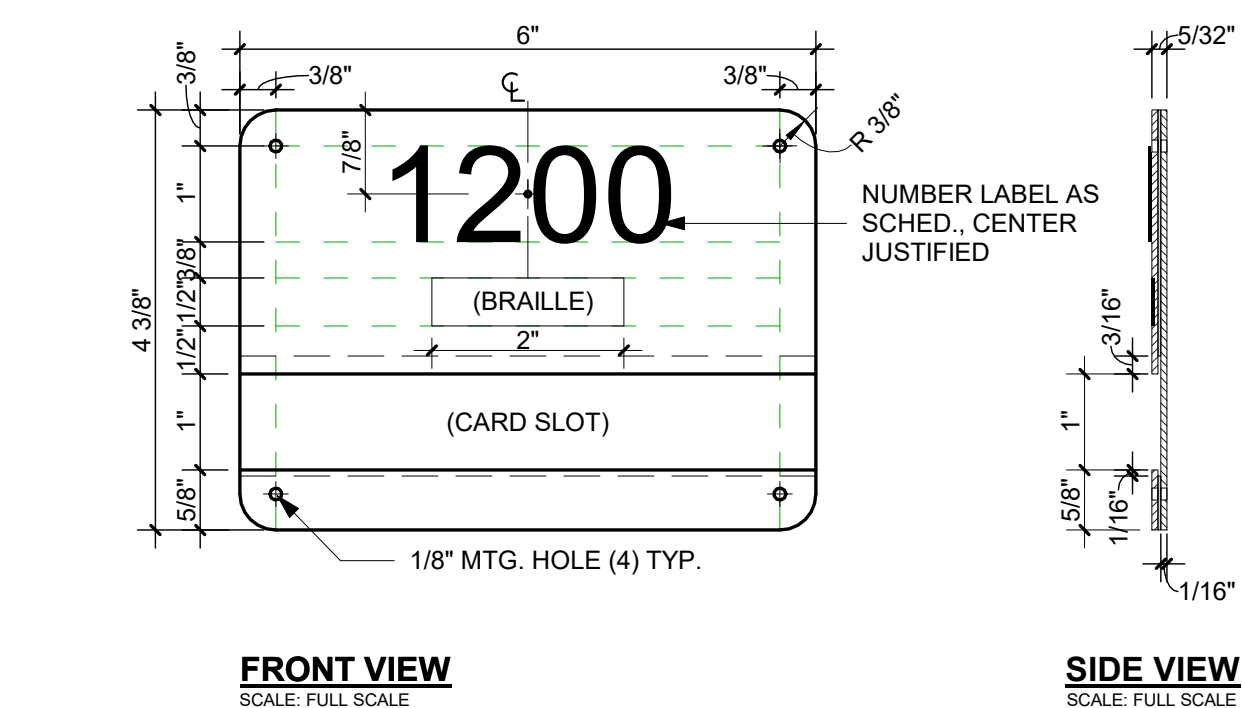


E2 TYPE B - CLASSROOMS
A-901 6" = 1'-0"

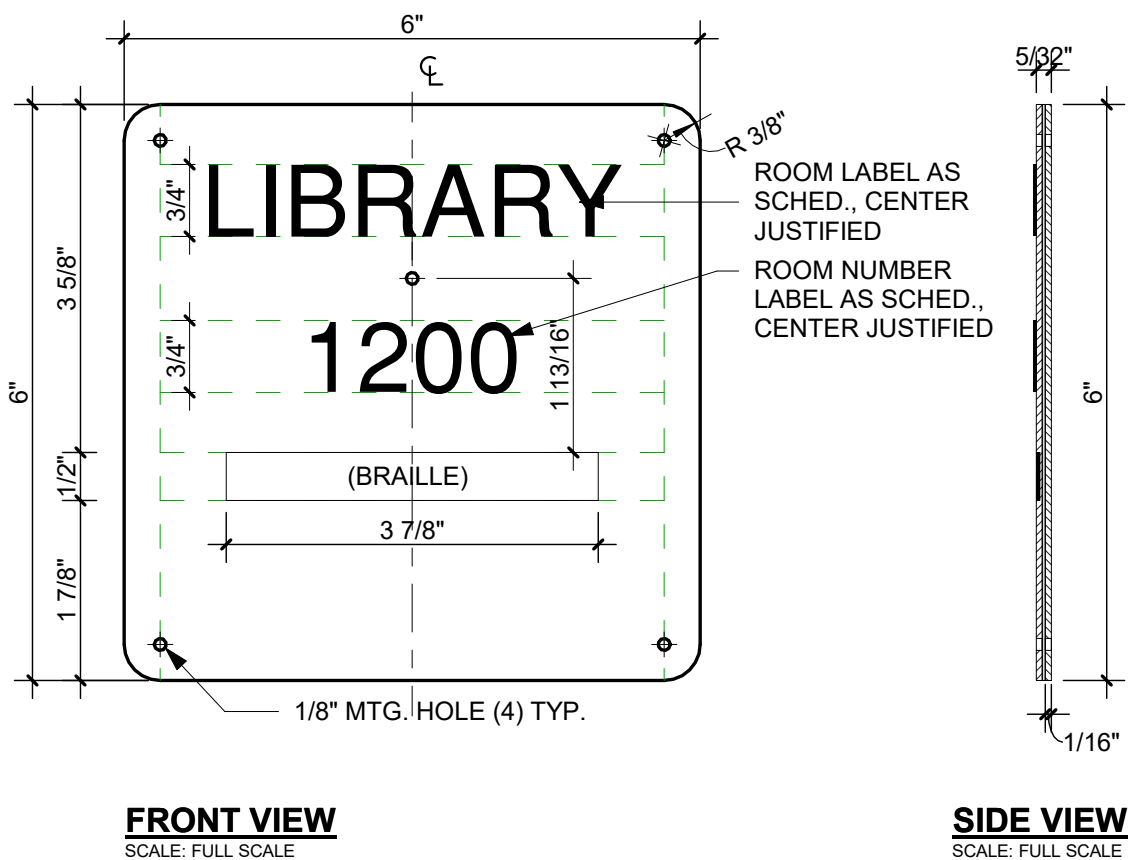


D1 TYPE C - SPECIALIZED AREAS
A-901 6" = 1'-0"

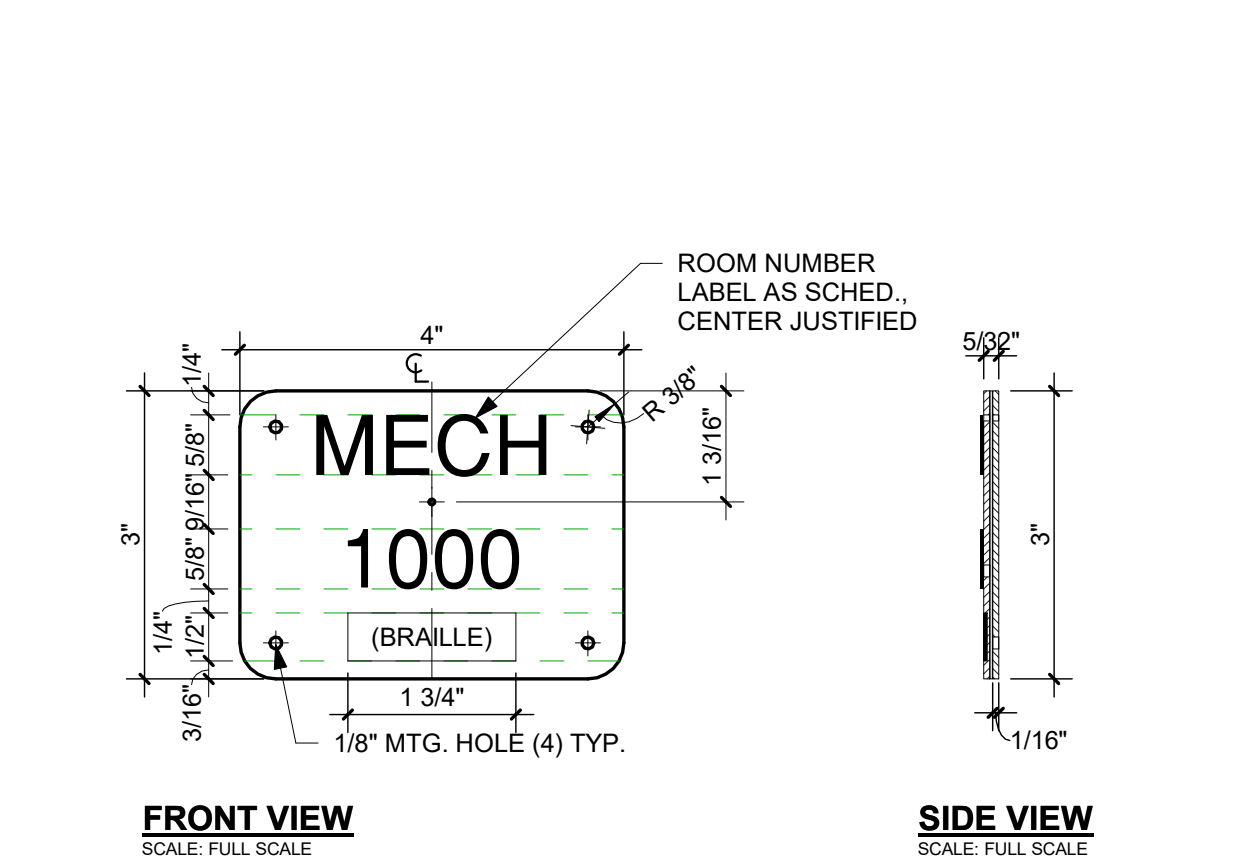


D2 TYPE D - MAINTENANCE ROOMS
A-901 6" = 1'-0"

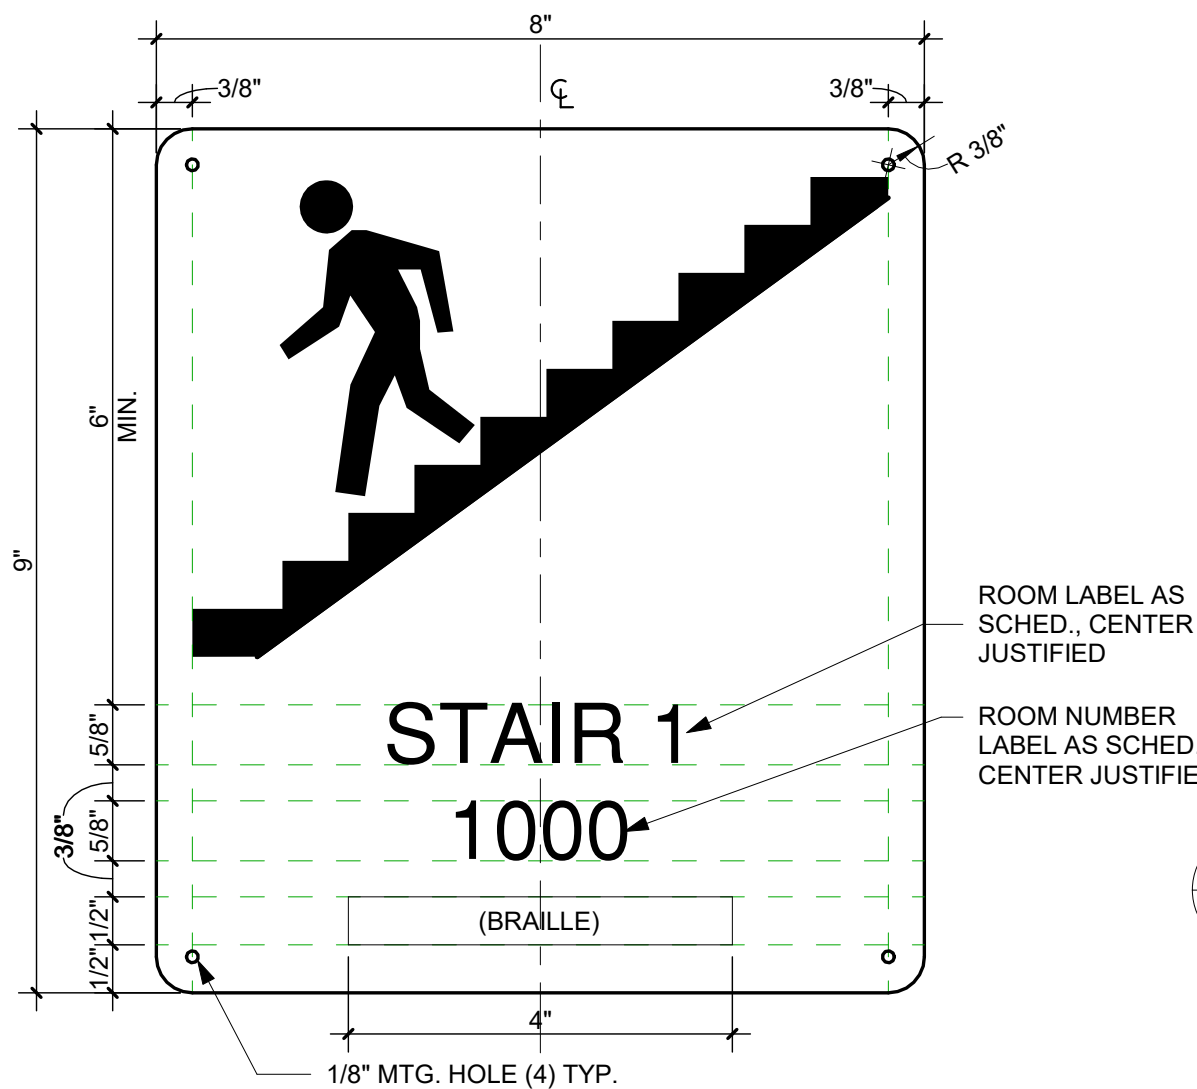


B2 TYPE F1 - STAIR
A-901 6" = 1'-0"

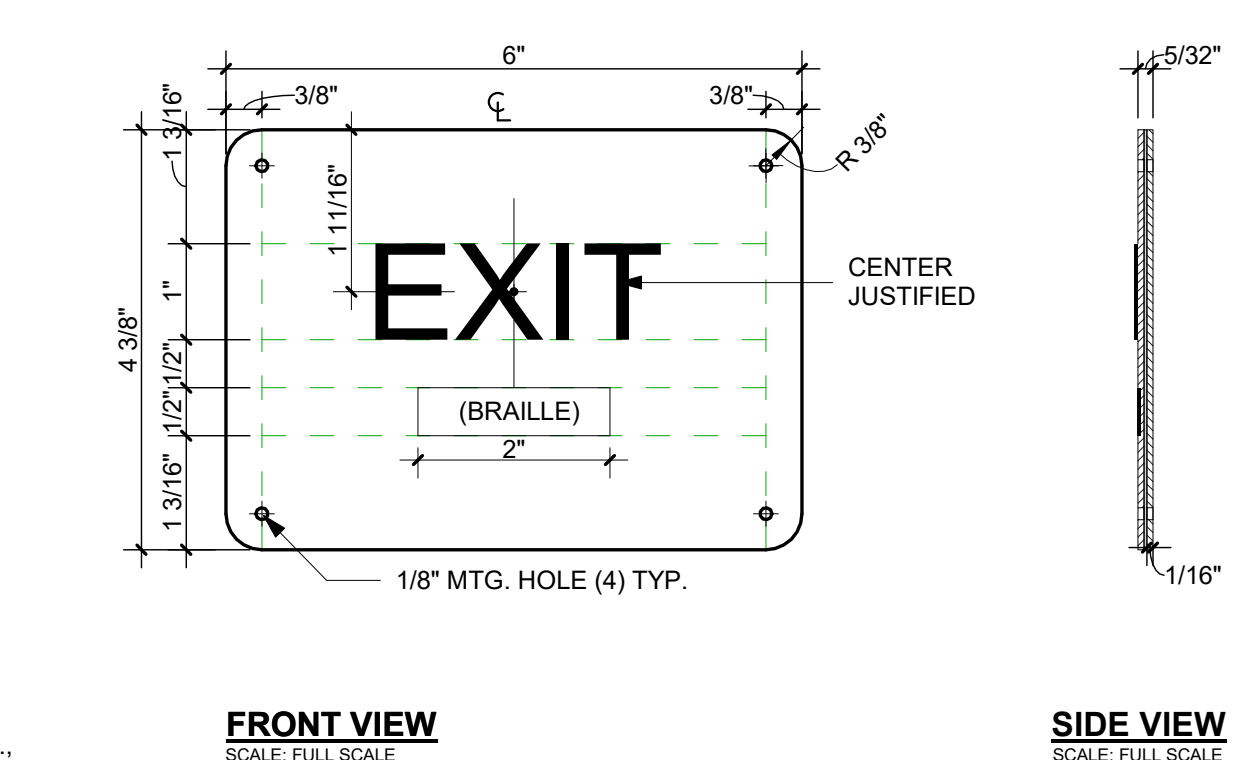


B1 TYPE F2 - EXIT
A-901 6" = 1'-0"

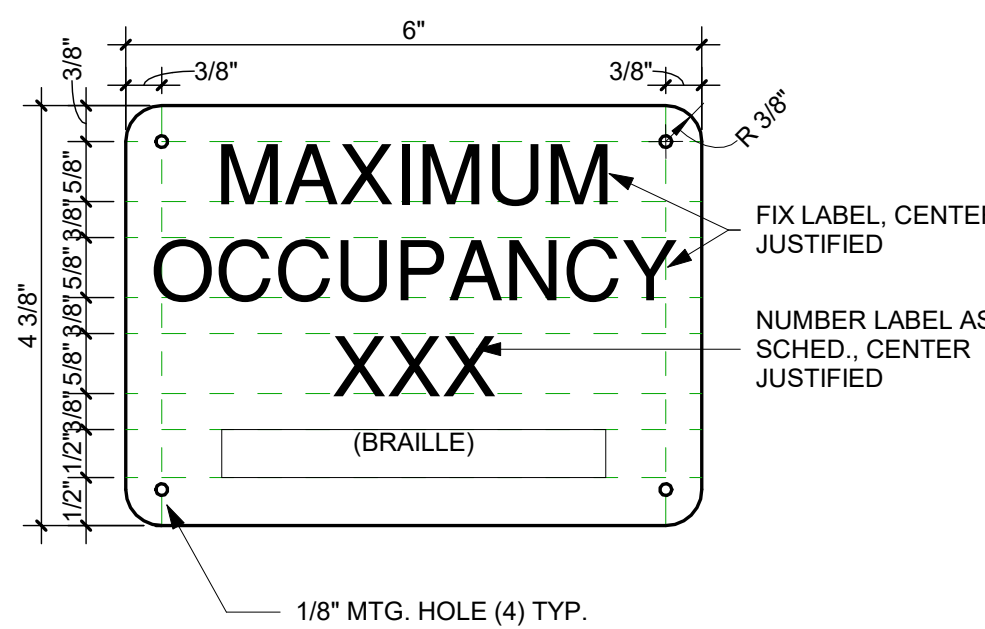



A1 TYPE G - MAXIMUM OCCUPANT
A-901 6" = 1'-0"

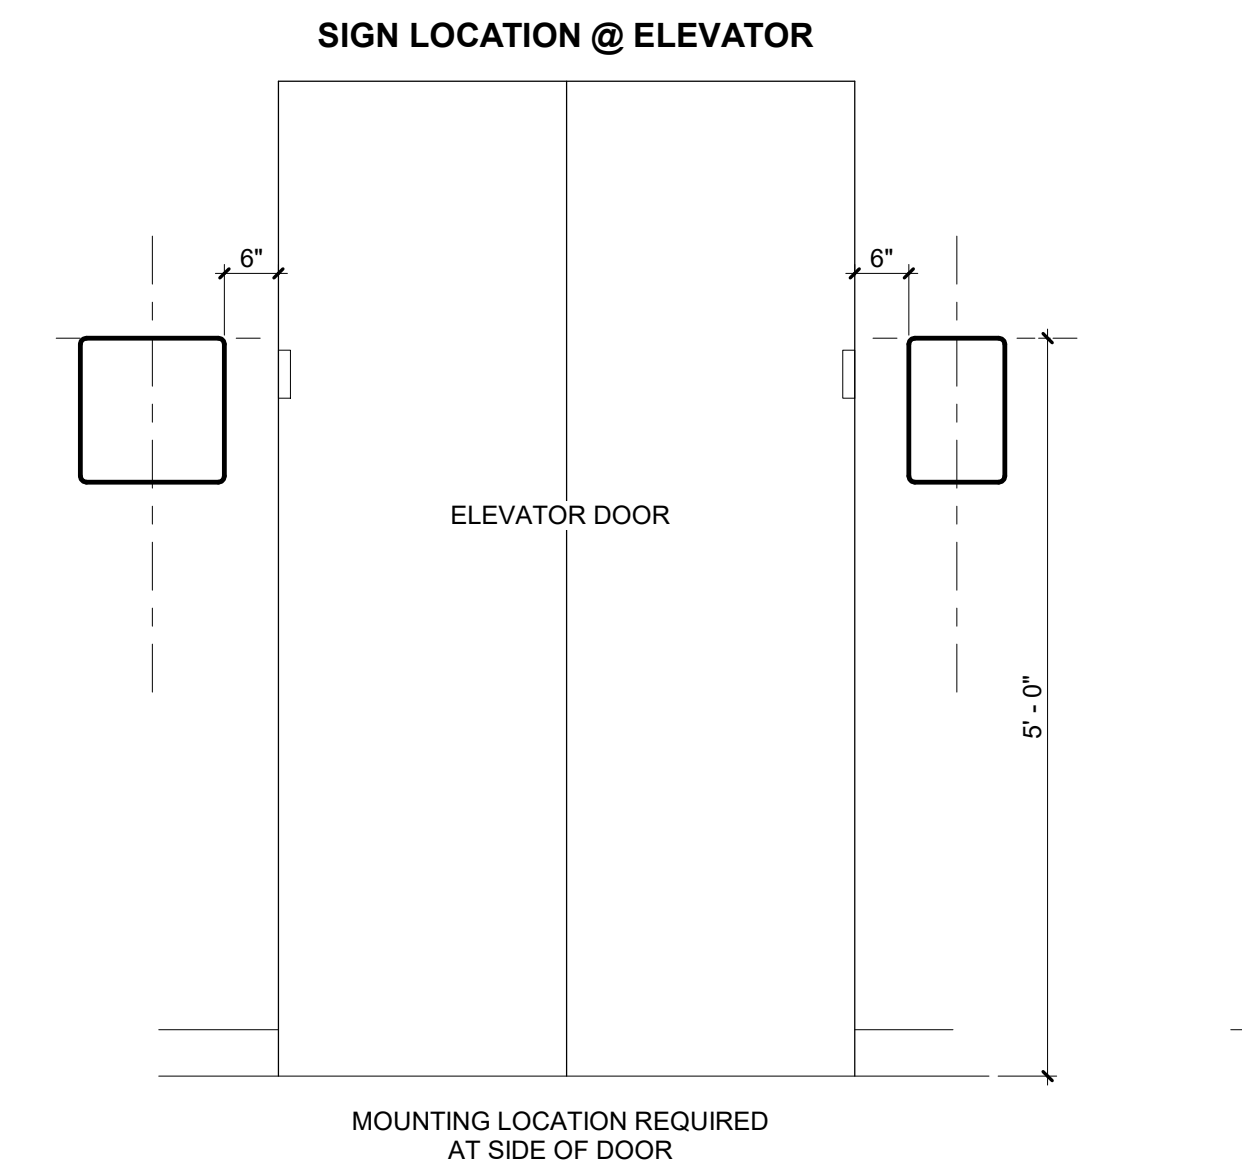




A3 TYP. SIGNAGE LOCATION
A-901 3/4" = 1'-0"

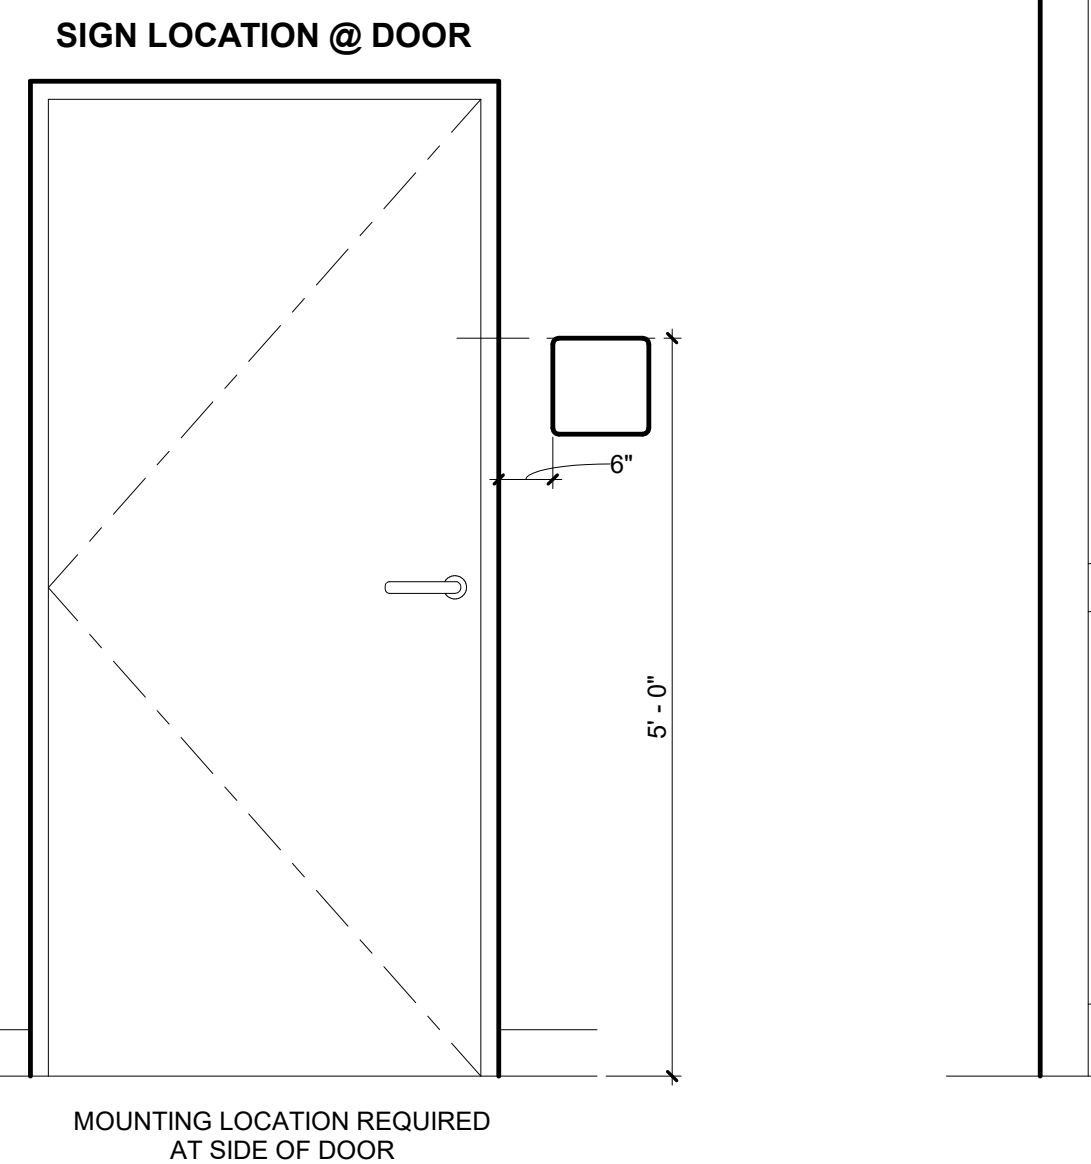

A5 DOOR VINYL DECAL - EMERGENCY ENTRANCE
A-901 3/4" = 1'-0"

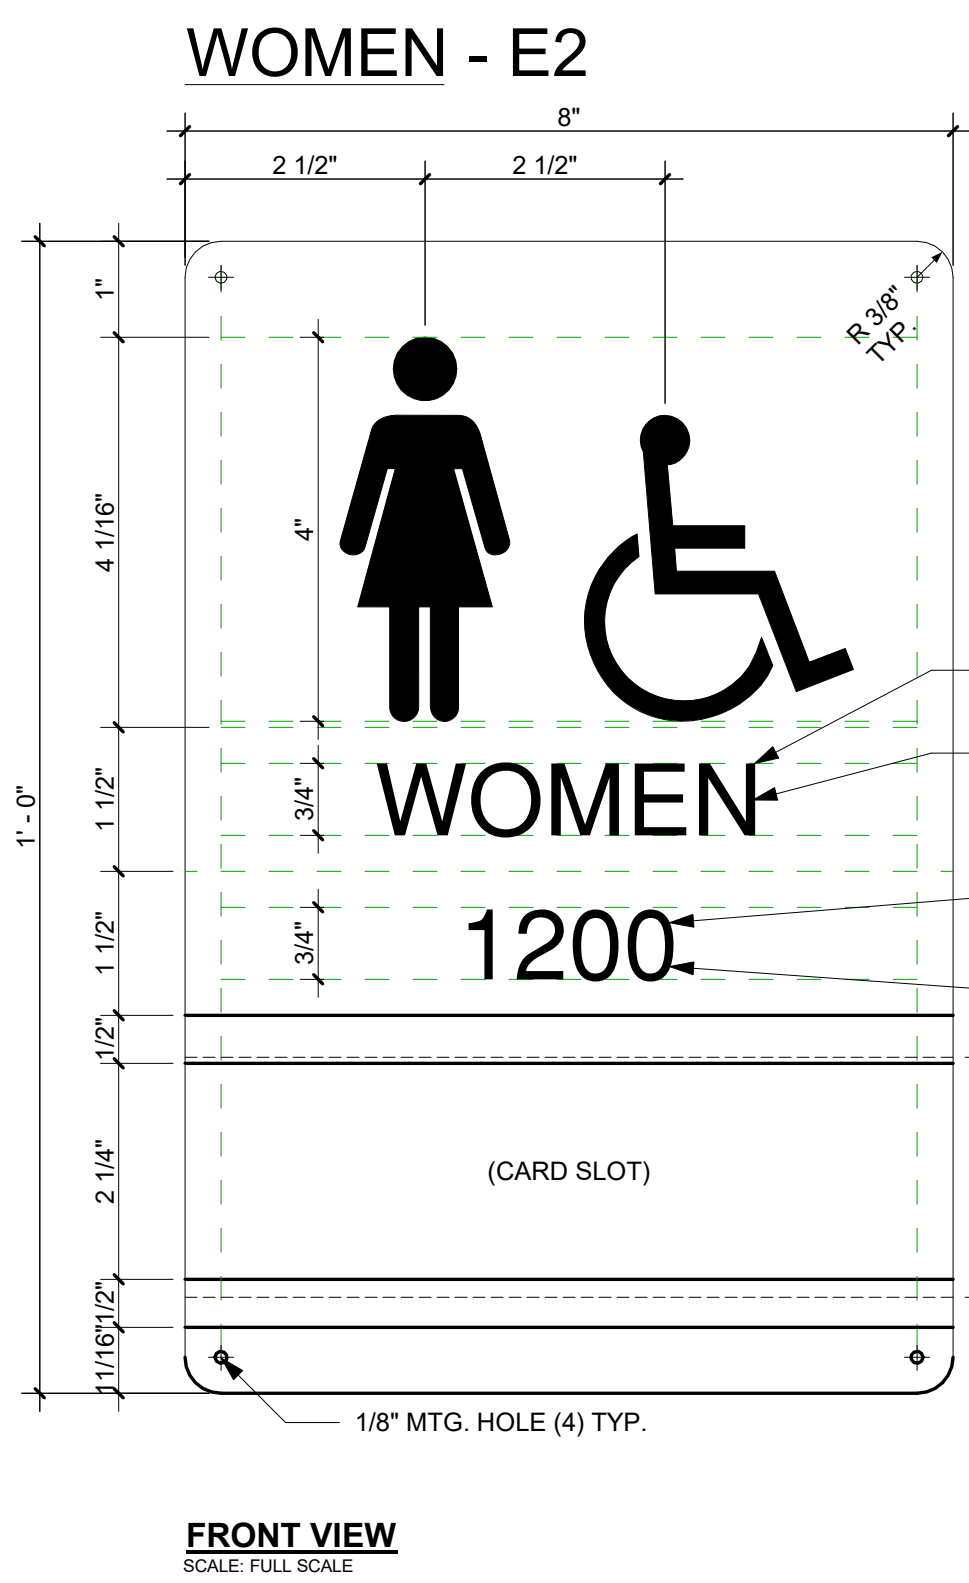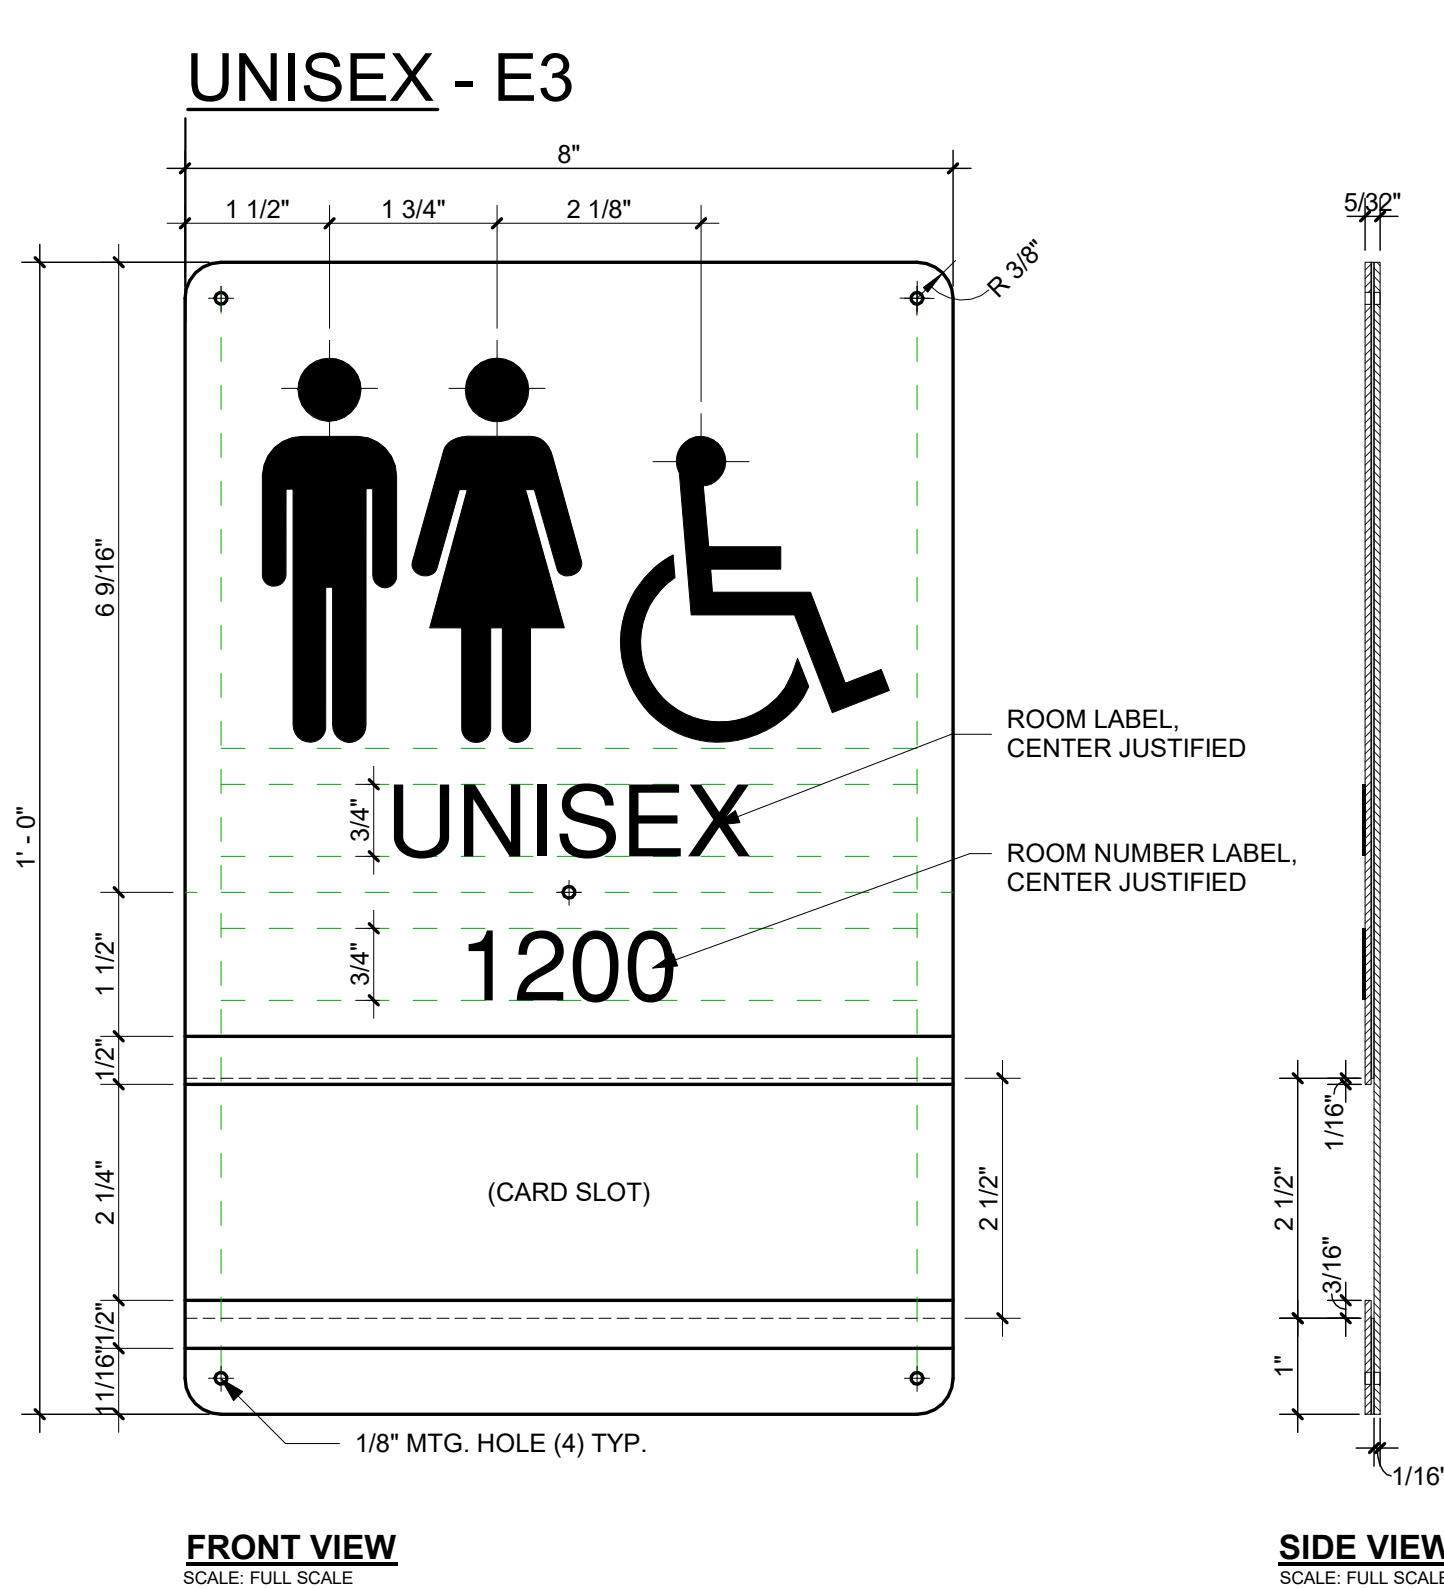

B3 TYPE E - RESTROOM
A-901 6" = 1'-0"

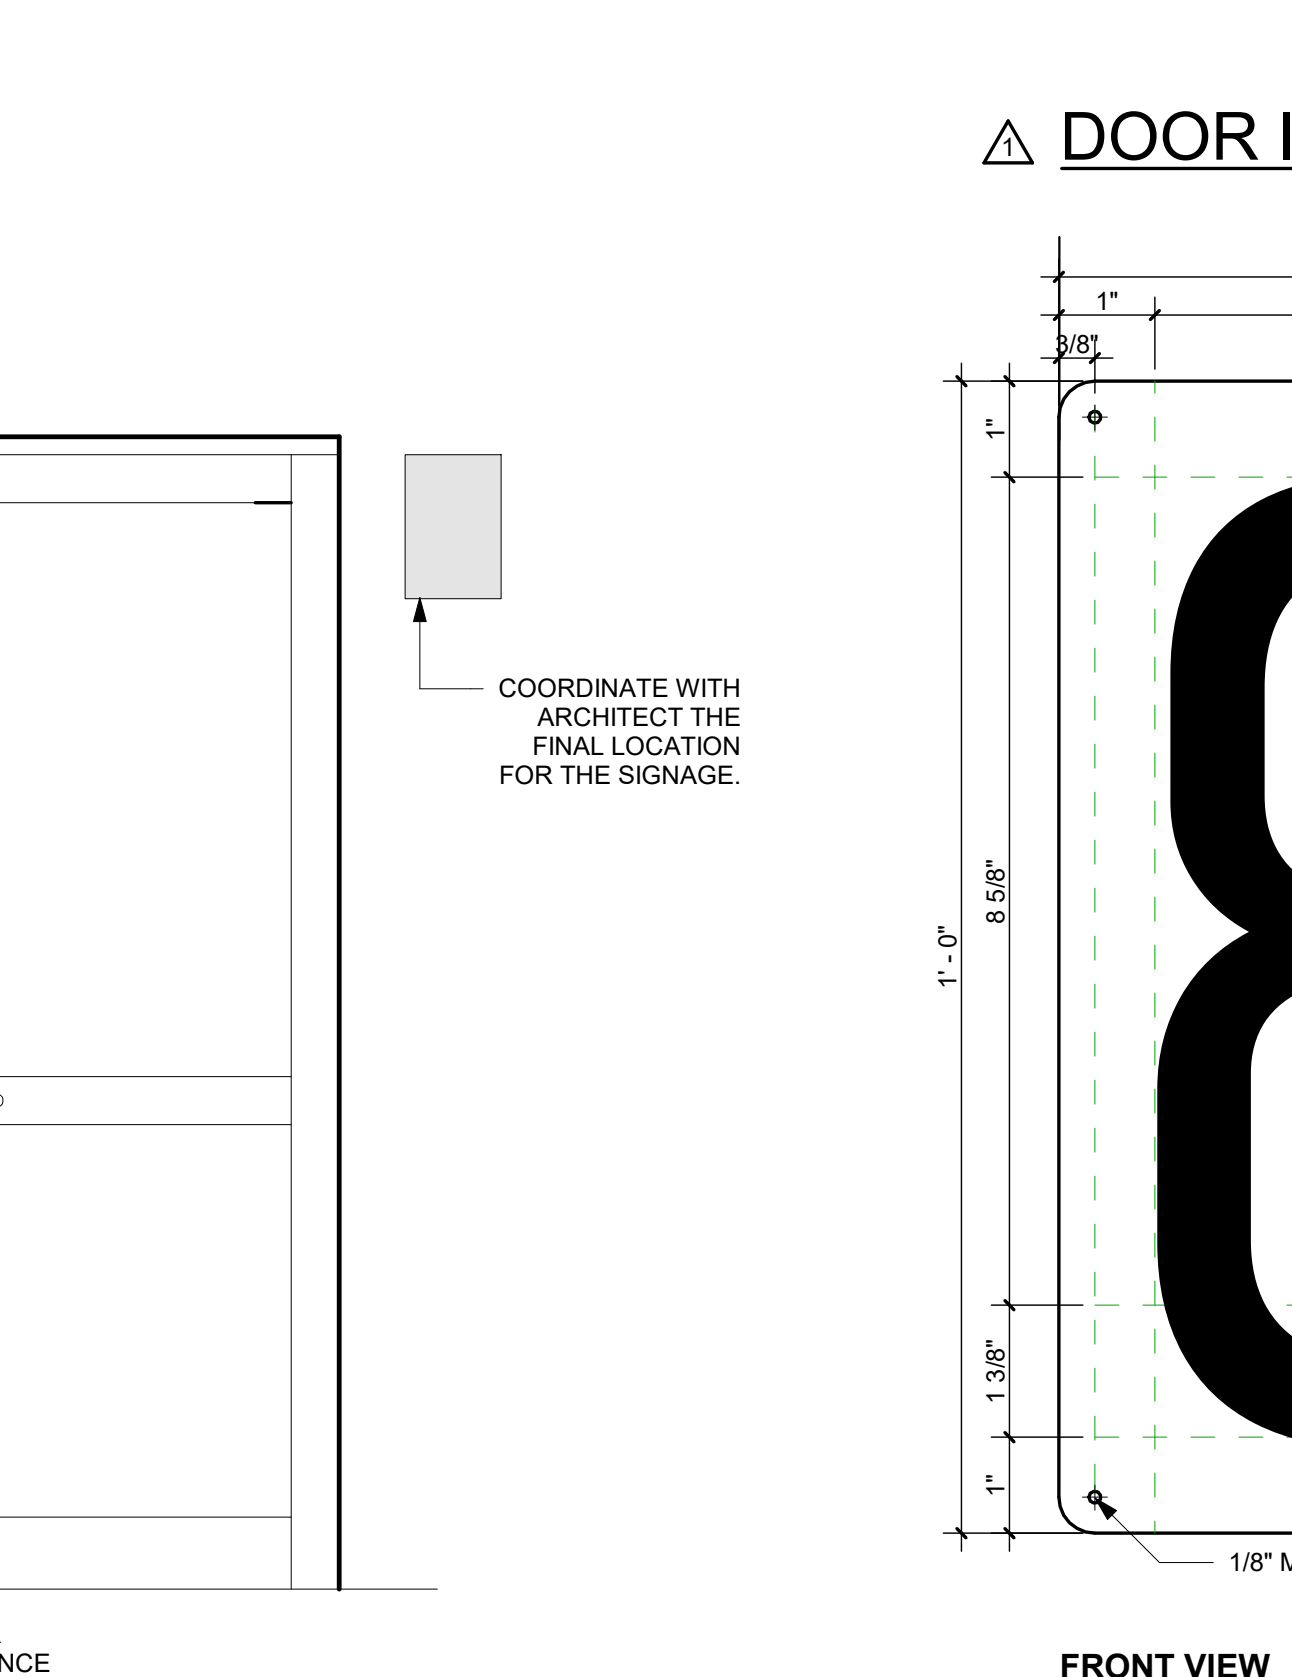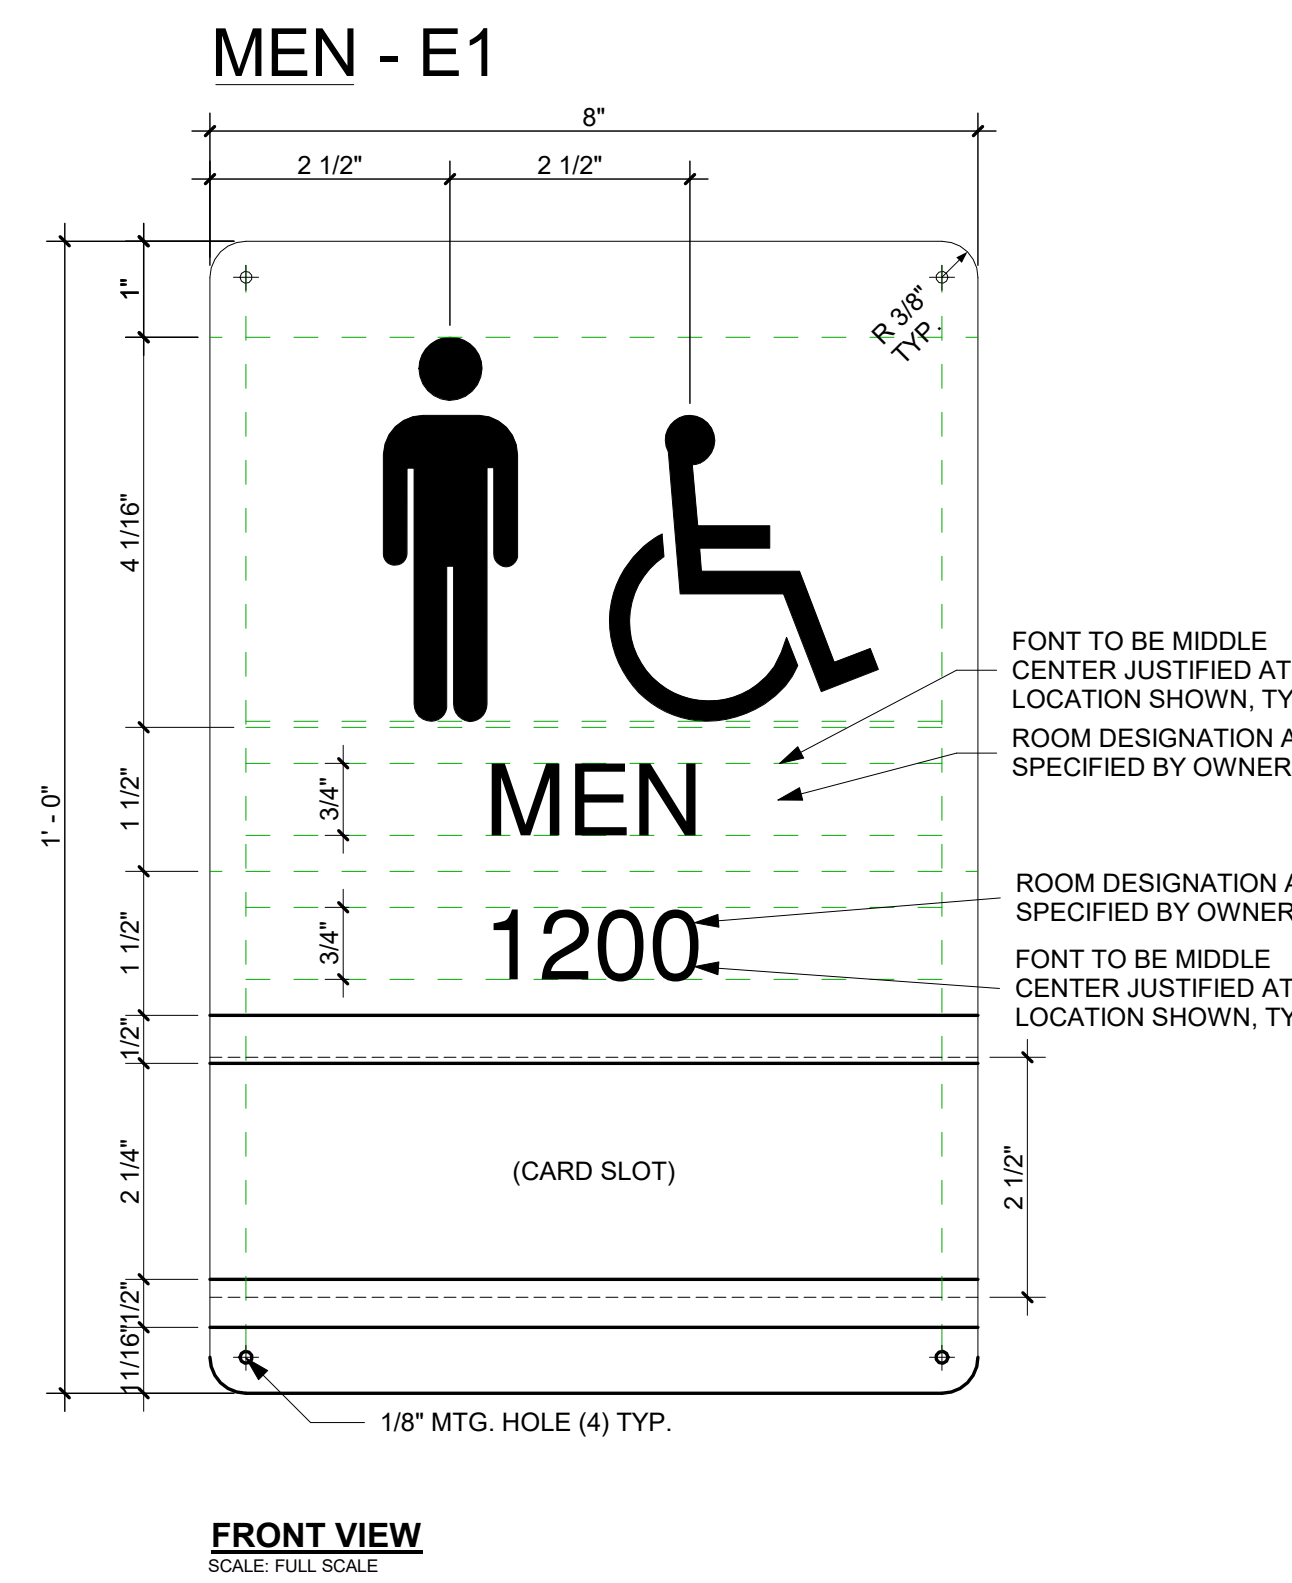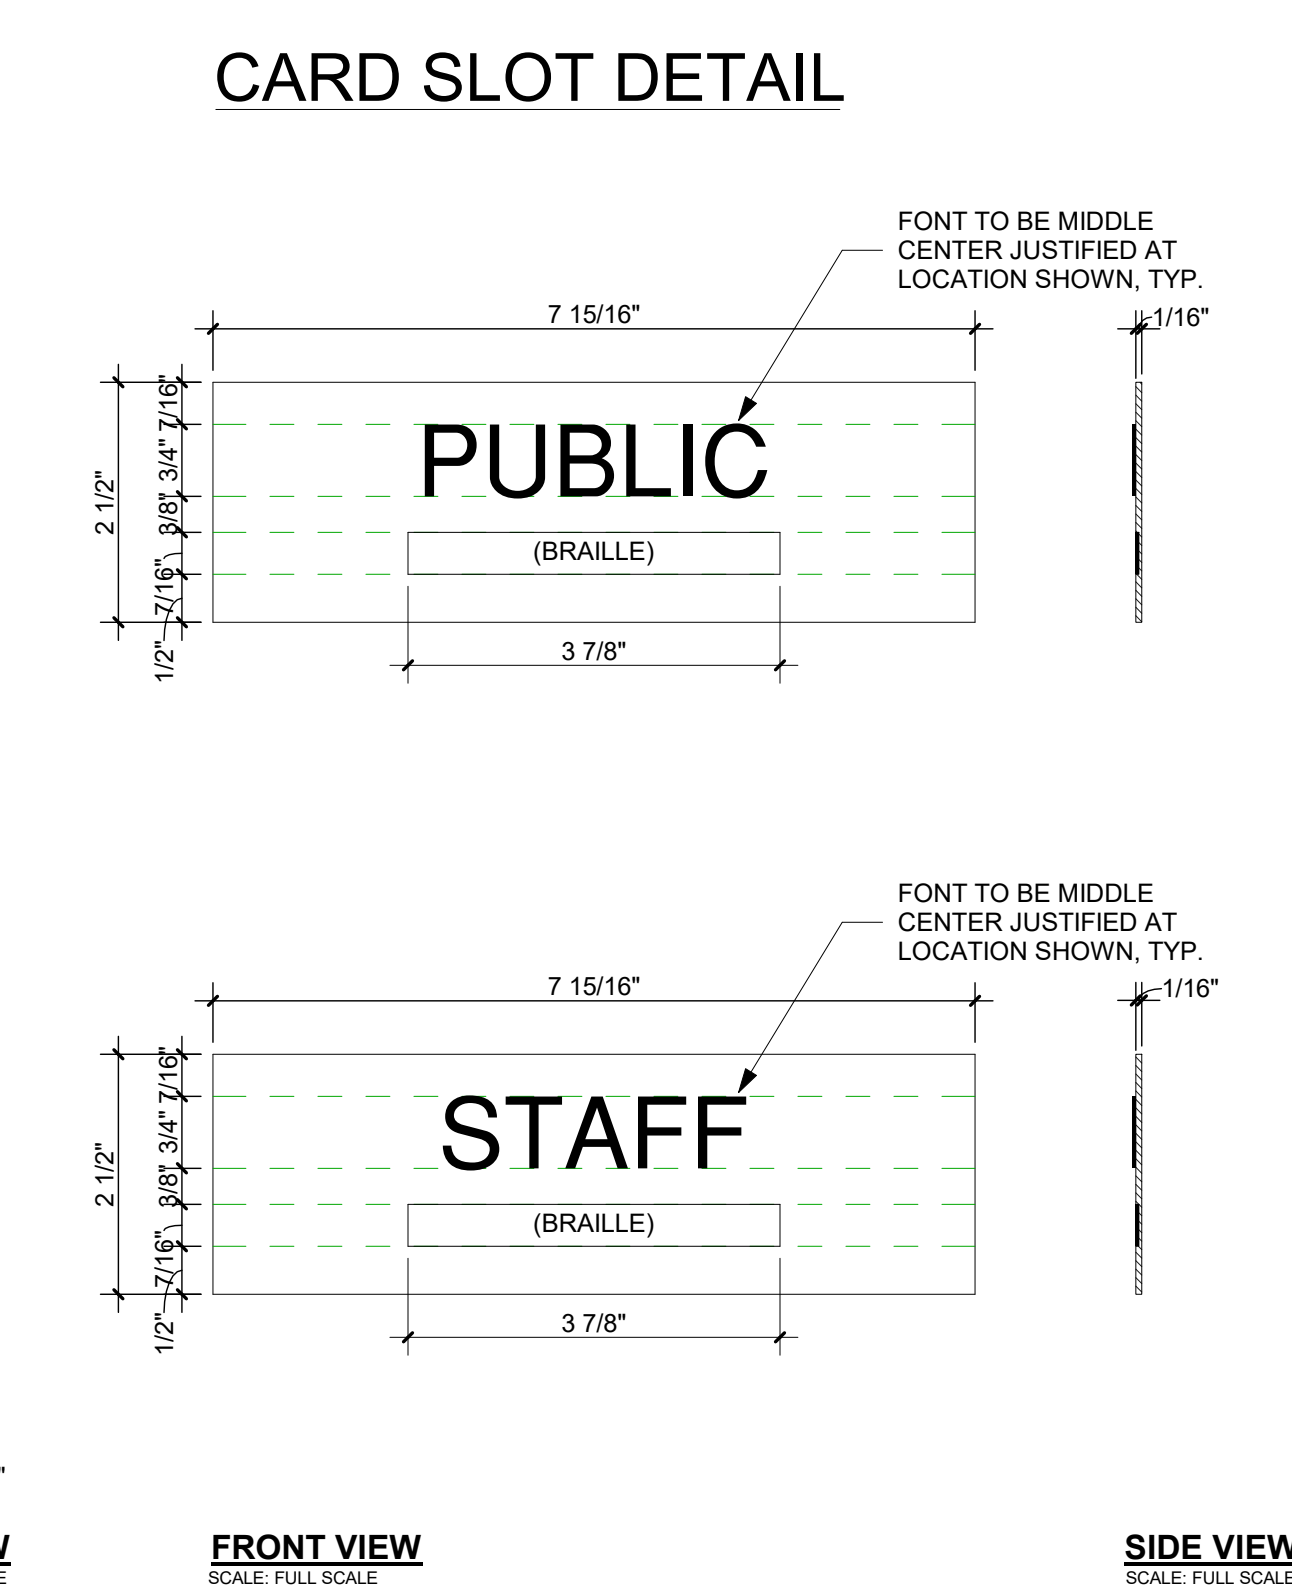

A6 TYP. SIGNAGE - EMERGENCY ENTRANCE
A-901 6" = 1'-0"

△ SIGNAGE GENERAL NOTES:

- THE POLICE DEPARTMENT HAS RECOMMENDED THAT ALL EXITS BE NUMBERED TO BETTER INDICATE SPECIFIC EXISTS WHEN PLANNING BUILDING EVACUATIONS OR FOR OTHER EMERGENCY SITUATIONS.
- ALL SIGNAGE NEEDS TO BE WEATHER RESISTANT.

MOUNTING

- THE MOUNTING SURFACE SHOULD BE IDENTIFIED FOR EACH SIGN TO ENSURE THAT HOLES ARE PROVIDED ONLY WHEN IT IS POSSIBLE TO THE SCREW TO THE WALL.

SIGNAGE COLOR STANDARD

- SIGNS WILL BE COLORED WITH WHITE LETTERING AND BLACK BACKGROUND, U.O.N.
- IF ALTERNATE COLORS ARE REQUESTED, THEY MUST FOLLOW INDUSTRY STANDARD AND ADA COMPLAINT COLORS SHALL BE USED, ALONG WITH THE FOLLOWING GUIDELINES.
- NO TWO-TONE BACKGROUNDS.
- SOLID SINGLE COLOR BACKGROUNDS ONLY.
- ALL TEXT MUST CONTRAST WITH BACKGROUND COLOR.
- ONLY APPROVED TEXTURED BACKGROUND MAYBE USED FOR OUTDOOR SIGNAGE, MUST BE WEATHER RESISTANT.
- THE COLOR CODE MUST BE PROVIDED TO MATCH THE COLOR FOR REPLACEMENT SIGNAGE IN INDUSTRY STANDARD SYSTEMS SUCH AS: - PANTONE MATCHING SYSTEM - RGB, HEX (HEXADECIMAL), CMYK, HSL, OR HSV

SIGNAGE MATERIAL - INTERNAL PLATES

- 0.30 WILSONART LAMINATE ON 3/16" ACRYLIC CORE
- 1/32" RAISED ADA TEXT, CHEMICALLY WELDED TO ACRYLIC CORE
- 1/32" RAISED GRADE 2 BRAILLE TRANSLATION
- 1/16" CLEAR NON-GLARE ACRYLIC WINDOW TO ACCEPT CARDSTOCK INSERTS (BY OTHERS)

SIGNAGE MATERIAL - EXTERNAL PLATES - EXTERIOR DOORS

REFER TO DETAIL A6/A-901

ROOM PLATE TYPE A - ADMIN. ROOMS

- OFFICES
- CONFERENCE ROOM
- BREAK ROOM
- WORK ROOM

ROOM PLATE TYPE B - CLASSROOMS

ROOM PLATE TYPE C - SPECIALIZED AREAS

- ATHLETICS
- FINE ARTS
- AUDITORIUM
- MAKER SPACE
- BLACK BOX

ROOM PLATE TYPE D - MAINTENANCE ROOMS

- ELEC
- MECH
- DF/MDF
- CUSTODIAN
- STORAGE
- ELEVATOR
- BOOKS


ROOM PLATE TYPE E - RESTROOMS

- PUBLIC RESTROOMS

SIGNAGE LEGEND (REFER TO SIGN SCHEDULE AND DETAILS)

TYPE A	TYPE B	TYPE C	TYPE D
A ROOM SIGN (ADM SIGN)	B ROOM SIGN (CLASSROOM)	C ROOM SIGN (SPECIALIZED)	D ROOM SIGN (MAINTENANCE)
TYPE E	TYPE F	TYPE G	
E ROOM SIGN (RESTROOM)	F EXIT SIGN	G OCCUPANCY	

△ DOOR IDENTIFICATION

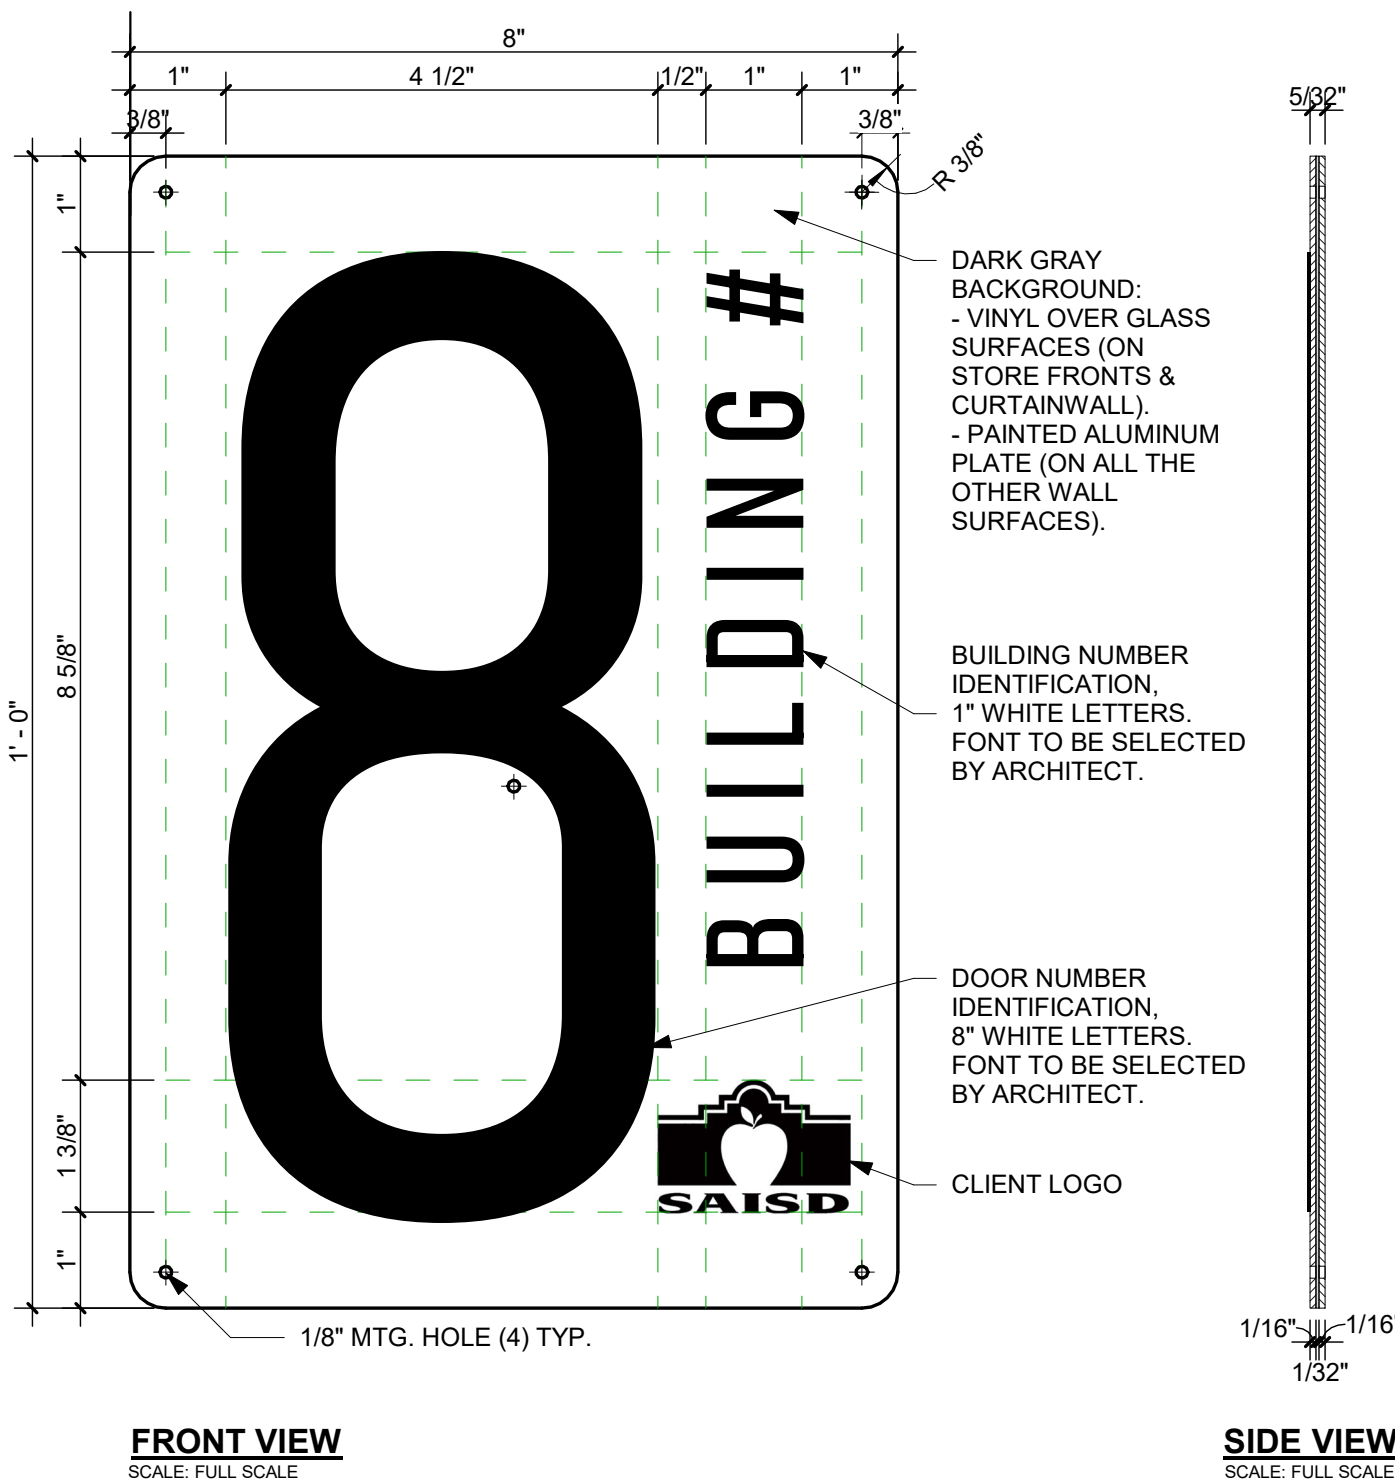

A6 TYP. SIGNAGE - EMERGENCY ENTRANCE
A-901 6" = 1'-0"



723 South Flores
San Antonio, Texas 78204
Tel: (210) 349-1163
www.alta-architects.com

Permit/Seal



06.24.24

Consultant



Client/Project
SAN ANTONIO INDEPENDENT SCHOOL DISTRICT

**BOND 2020 FOX TECH CAMPUS
ADDITIONS & RENOVATIONS**

637 N. MAIN AVE.
SAN ANTONIO, TEXAS 78205

DATE		CONSTRUCTION DOCUMENTS	
06/24/24			
PROJECT NO.	DRAWN BY	CHECKED BY	
A202108.00	LA	WA	
ISSUE / REVISIONS			
#	DESCRIPTION		DATE
	PERMIT SET		08/23/24
1	ADDENDA #02		07/26/24

PERMIT SET

Sheet Name
SIGNAGE DETAILS

Drawing No.
A-901

E

D


C

B



A

10/2/2024 10:02:27 PM

ORIGINAL SHEET - ARCH 1/1

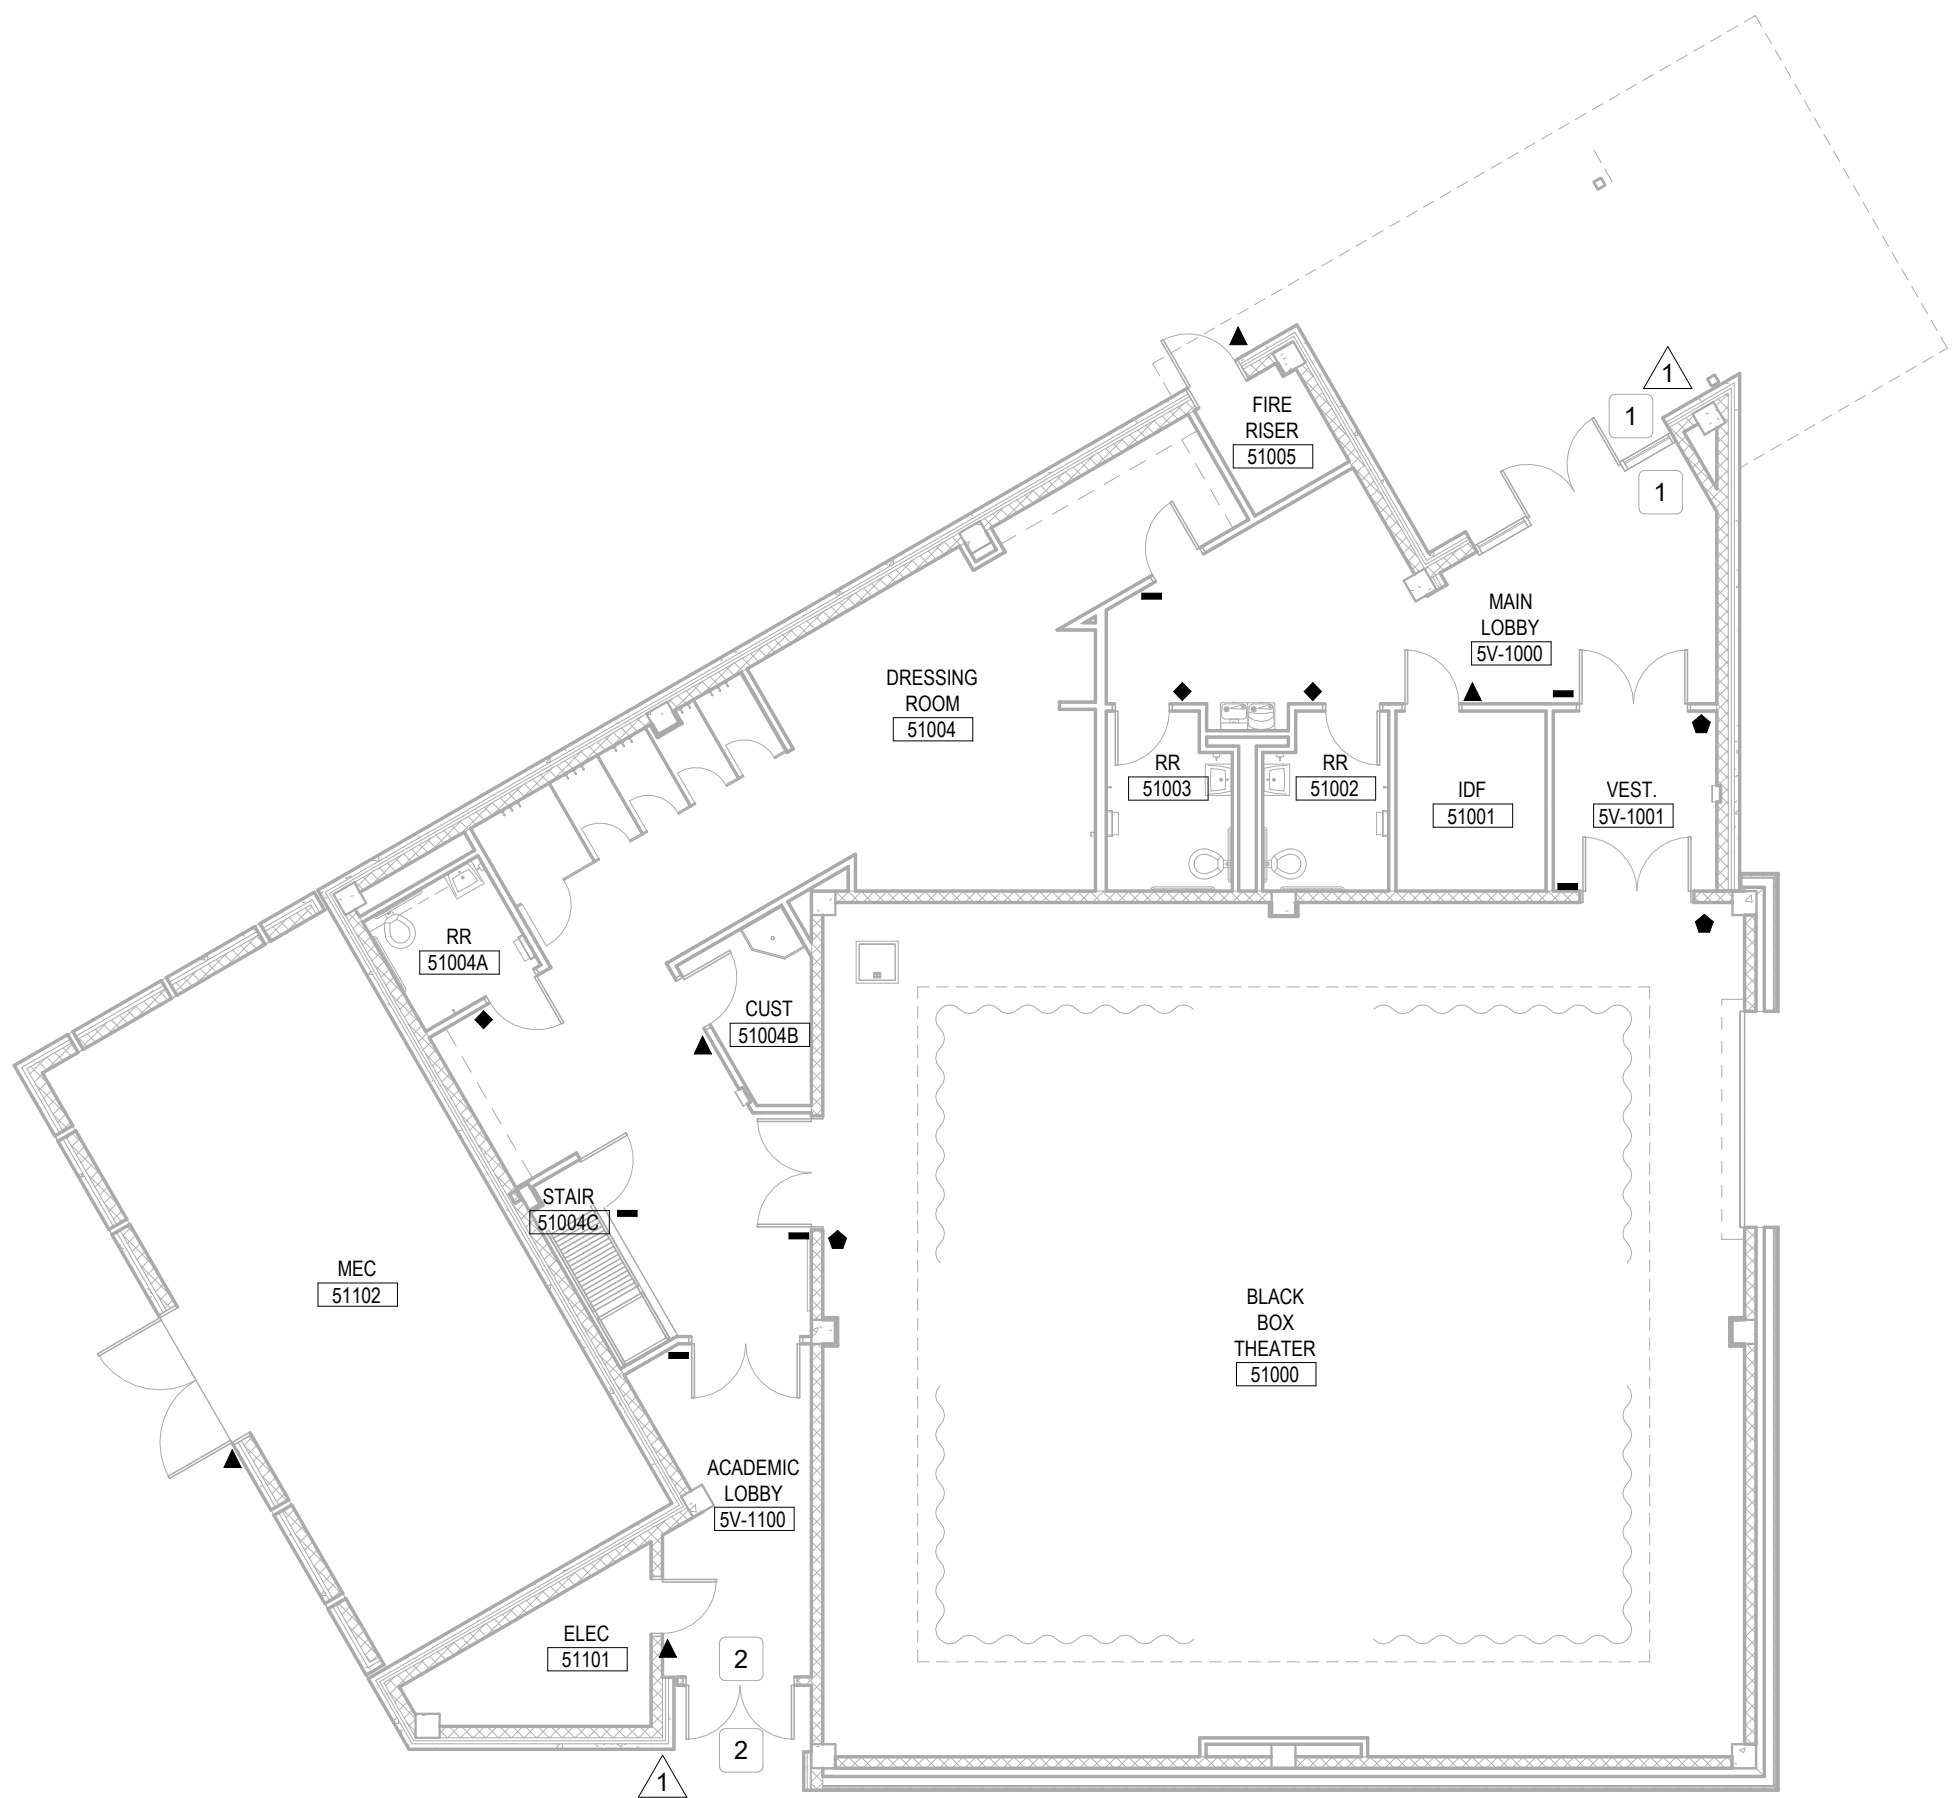


C1 **SIGNAGE FLOOR PLAN- BLACK BOX - LEVEL 1**
A-904 3/32" = 1'-0"

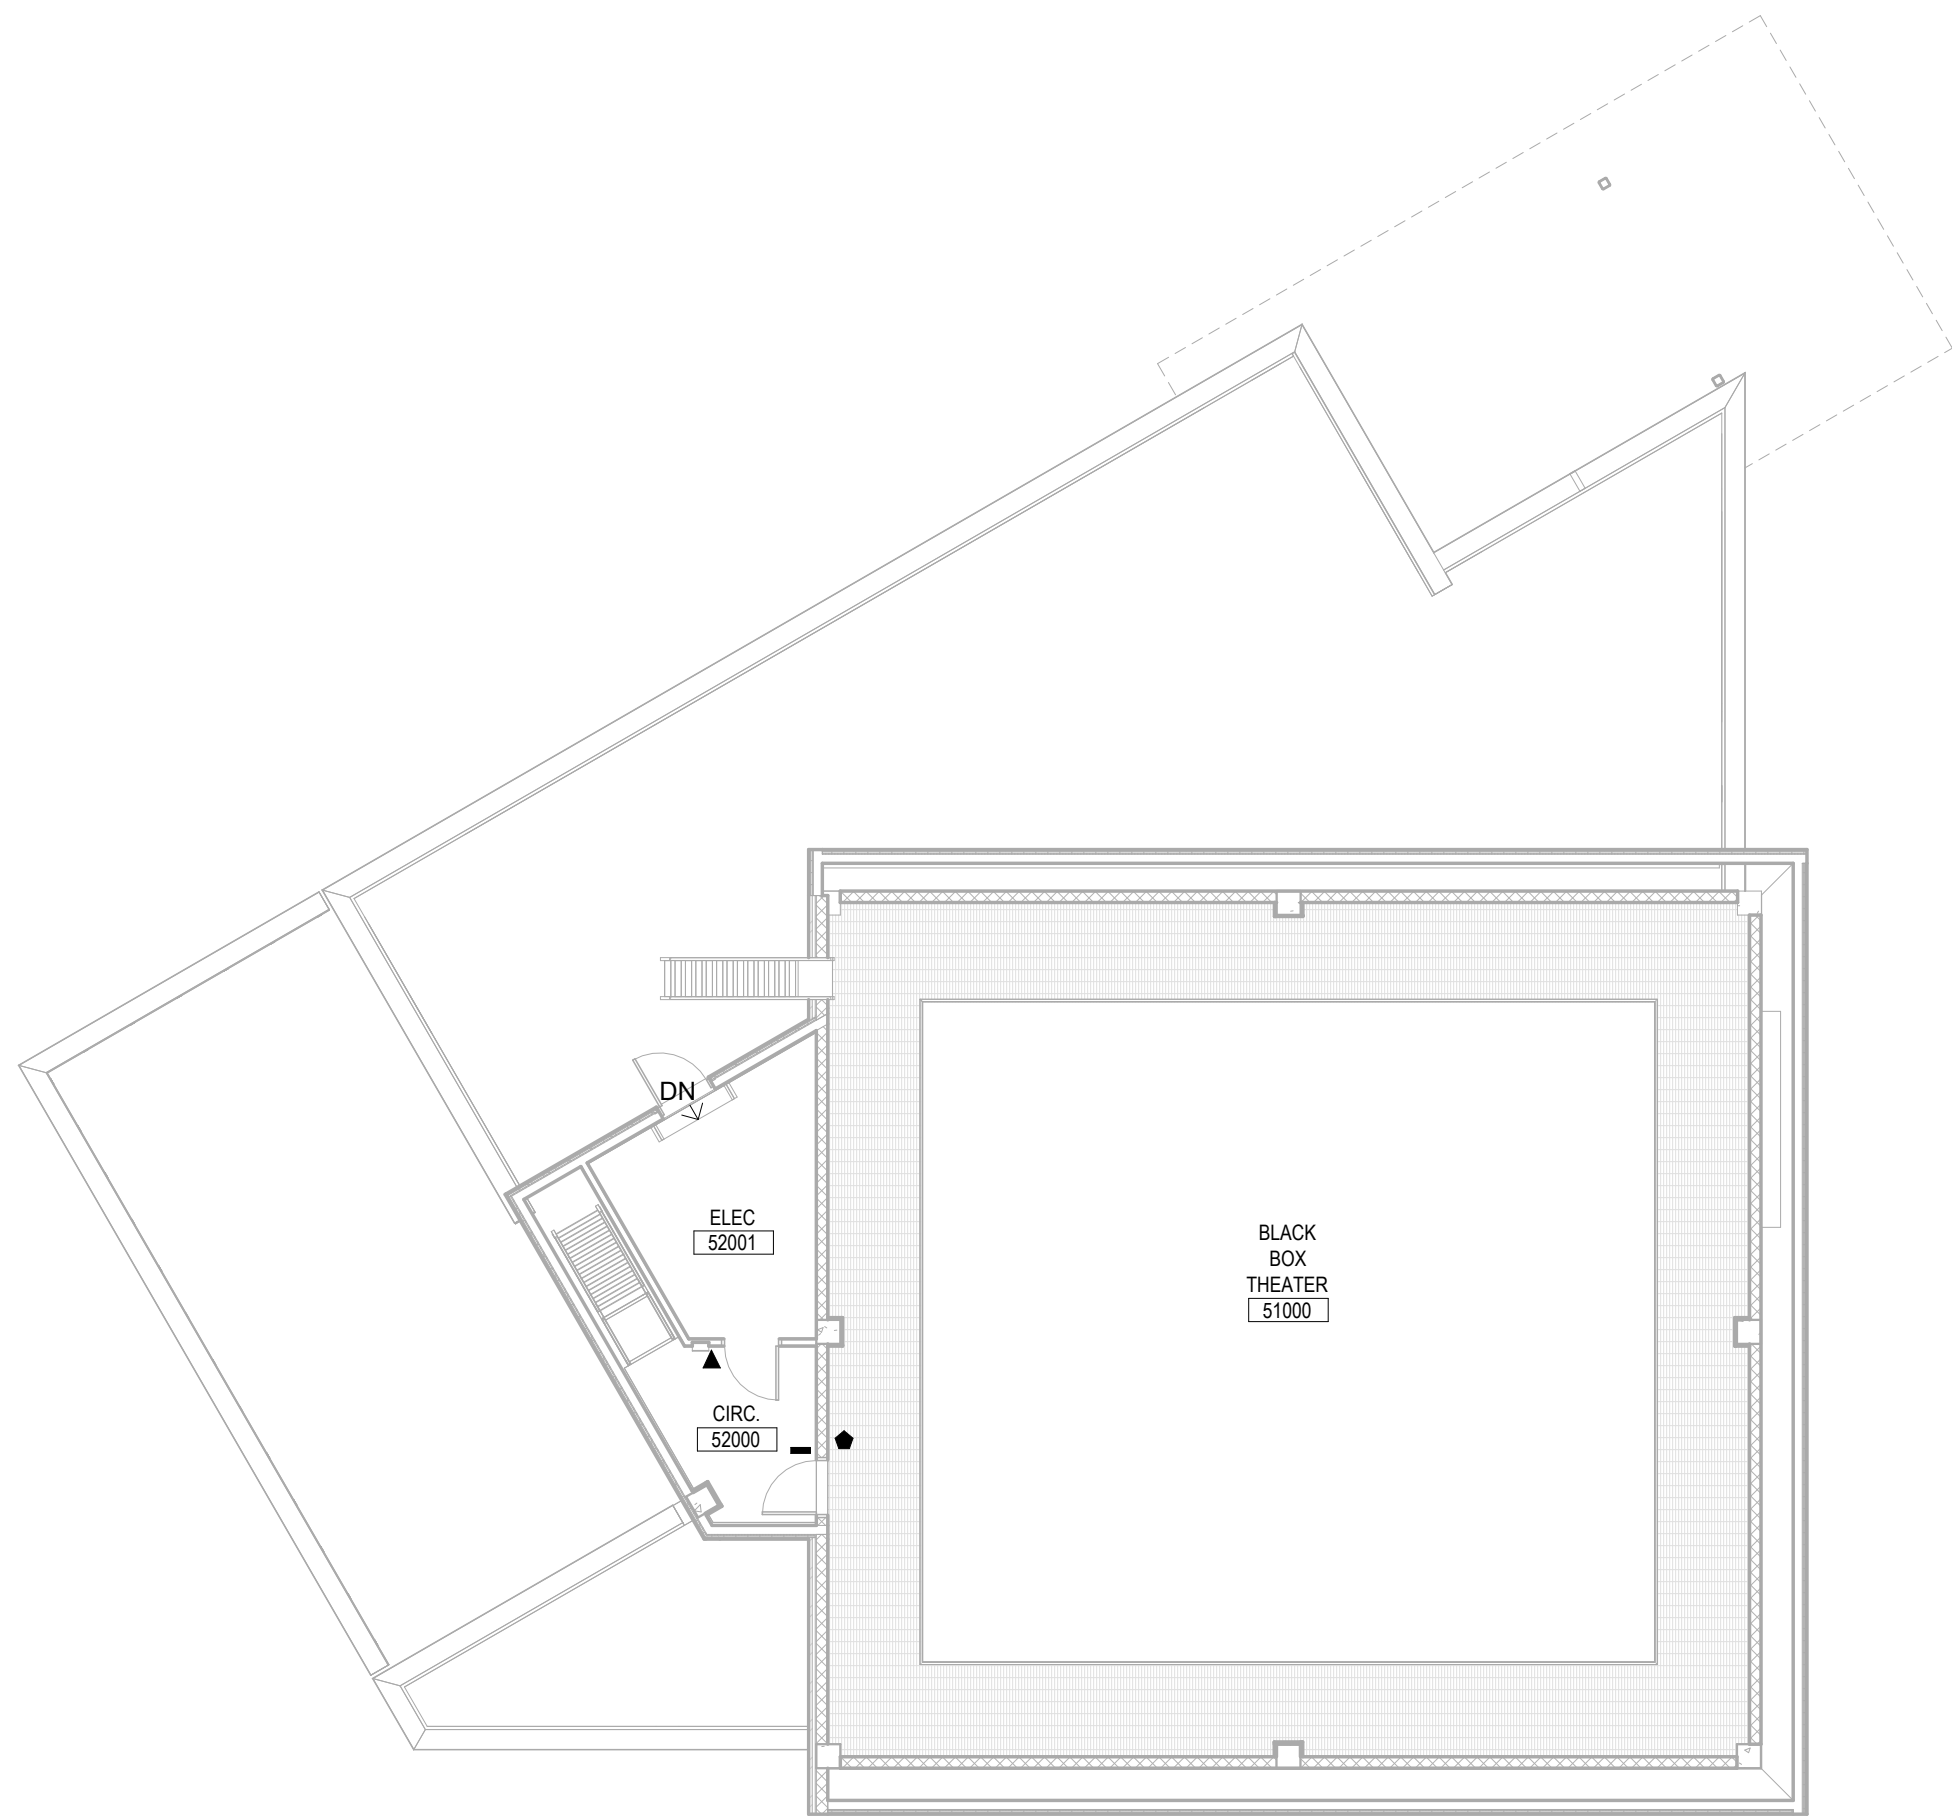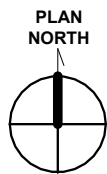

C4 **SIGNAGE FLOOR PLAN - BLACK BOX - MEZZANINE**
A-904 3/32" = 1'-0"



SIGNAGE SCHEDULE					
ROOM	SIGN TYPE	SIGN MESSAGE	PICTOGRAM	NOTES	DETAILS
1					
SV-1001	C	SPECIALIZED AREA			
SV-1001	F2	EXIT			
51000	C	SPECIALIZED AREA			
51000	C	SPECIALIZED AREA			
51000	F2	EXIT			
51000	F2	EXIT			
51001	D	MAINTENANCE AREA			
51002	E3	UNISEX - DRESSING ROOM	FEMALE, MALE & ADA ICON		
51003	E3	UNISEX - DRESSING ROOM	FEMALE, MALE & ADA ICON		
51004	C	SPECIALIZED AREA			
51004	C	SPECIALIZED AREA			
51004A	E3	UNISEX - DRESSING ROOM	FEMALE, MALE & ADA ICON		
51004B	D	MAINTENANCE AREA			
51004C	C	SPECIALIZED AREA			
51005	D	MAINTENANCE AREA		EXTERIOR SIGNAGE	
51101	D	MAINTENANCE AREA			
51102	D	MAINTENANCE AREA		EXTERIOR SIGNAGE	
1: 17					
2					
51000	C	SPECIALIZED AREA		CATWALK	
51000	F2	EXIT			
52001	D	MAINTENANCE AREA			
2: 3					

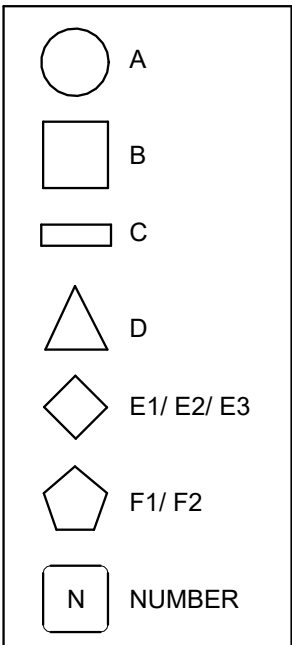

Permit/Seal



Consultant



Client/Project
SAN ANTONIO INDEPENDENT SCHOOL DISTRICT

**BOND 2020 FOX TECH CAMPUS
ADDITIONS & RENOVATIONS**

637 N. MAIN AVE.
SAN ANTONIO, TEXAS 78205

DATE	CONSTRUCTION
06/24/24	DOCUMENTS
PROJECT NO.	DRAWN BY
A202108.00	LA
	CHECKED BY
	ALTA

ISSUE / REVISIONS		
#	DESCRIPTION	DATE
1	PERMIT SET	08/23/24
1	ADDENDA #02	07/26/24

PERMIT SET

Sheet Name
**SIGNAGE FLOOR PLAN -
BLACK BOX BLDG - LEVEL
1 & 2**

Drawing No.
A-904